

Central Falls High School

100% Construction Documents

Central Falls, RI Ai3 Project #2202.02

Addendum #7

January 26, 2024

The attention of Bidders submitting proposals for Central Falls High School 100% Construction Documents is called to the following changes to the Bidding Contract Documents dated October 13, 2023 as prepared by Ai3 Architects, LLC. The items set forth therein below, whether of revision, omission, addition, substitution or clarification are all to be included as changes to Information to Bidders, the Conditions of the Contract, Specifications and Drawings of the Contract.

The number of this Addendum (Number 7) must be entered in the appropriate spaces provided on the Bid Form.

CLARIFICATIONS:

ADD 7-001	Bidder Question: Specifications call for a 2 year General Contractors comprehensive warranty but various specification sections only call for a 1 year warranty. Should all subcontractors, manufacturers and vendors be held to a 2 year warranty period accordingly? Response: Refer to included specifications for clarification.
ADD 7-002	Bidder Question: At the site walk we observed there to be an existing playground, NW of the existing track. Please confirm the General Contractor is to R&D this playground and equipment as part of their work. Response: The City will not remove or salvage the playground. The City has already removed everything they wanted to save from the complex. It is the General Contractor's responsibility to remove and dispose of the Playground Equipment. Refer to attached drawings.
ADD 7-003	Bidder Question: The fire specification, 26 00 00 page 69, 2.17.0. Notification appliances shall be fully addressable. "Systems that

utilize conventional technology for notification appliances shall furnish and install an addressable module at each device to facilitate the desired operation specified." I don't see that the desired operation is provided and code would require general evacuation (all notification appliance activate during an alarm event). This specification requires the addition of two addressable modules installed for individual control of each notification appliance. This requirement makes this a proprietary and non-competitive specification that only Simplex (Autocall) can bid. Please allow the use of conventional notification appliances without the use of additional modules. This will allow additional manufactures to provide a competitive bid for this project. **Response:** Refer to included specifications for clarification.

ADD 7-004

Bidder Question: Earthwork Spec 31 00 00 para. 1.6/A states "the Contractor shall refer to Section 00 31 32" in reference to existing site conditions, this section is not part of the contract documents.. **Response:** Refer to included specifications for clarification.

SPECIFICATIONS:

- ADD 7-005 Document 00 01 10 "Table of Contents"; REMOVE in entirety and REPLACE with new Document 00 01 10, dated January 26, 2024, Addendum #7.
- ADD 7-006 Section 01 78 36 "Warranties"; Article 1.4, Paragraph A, subparagraph 1; DELETE the words "two-year" and REPLACE with "one-year".
- ADD 7-007 Section 01 78 36 "Warranties"; Article 1.6, Paragraph A, subparagraph 1; DELETE the word "Two" and REPLACE with the word "One" as follows:
 - Duration of Comprehensive Warranty: Two One year from date of Substantial Completion.
- ADD 7-008

Section 26 00 00 "Electrical"; Article 2.17.E.1: Replace with the following: The FACP shall be an Autocall 4100ES, Edwards EST, or Notifier NFS640 and shall contain a microprocessor based Central Processing Unit (CPU). The CPU shall communicate with and control the following types of equipment used to make up the system: addressable detectors, notification devices, addressable modules, printer, annunciators, and other system controlled devices.

- a. General: Comply with UL 864, "Control Units and Accessories for Fire Alarm Systems".
- Network Communications shall be fiber optic interconnection of panels for data, voice and two-way communications via Modular Network Communications Cards
- c. Alphanumeric Display and System Controls: Panel shall include an 854 character, expanded content multi-line QVGA LCD display to indicate alarm, supervisory, and component status messages

- and shall include a keypad for use in entering and executing control commands.
- Nodes shall be interconnected via fiber-optic cable in minimum of 2" conduit.
- e. Network node communication shall be through a token ring, hub, or star topology configuration, or combination thereof
- f. A single open, ground or short on the network communication loop shall not degrade network communications. Token shall be passed in opposite direction to maintain communications throughout all network nodes. At the same time the status of the communication link shall be reported
- g. If a group of nodes becomes isolated from the rest of the network due to multiple fault conditions, that group shall automatically form a sub-network with all common interaction of monitoring and control remaining intact. The network shall be notified with the exact details of the lost communications
- h. The communication method shall be NFPA 72 style 7

ADD 7-009

Section 26 00 00 "Electrical"; Article .2.17.G.2: Replace with the following: Isolator Module: Isolator modules shall be provided every between every 25 devices and between floors to provide short circuit isolation for SLC wiring. Isolator shall be listed to UL 864. The Isolator shall mount directly to a minimum 2 1/8" deep, standard 4" square electrical box, without the use of special adapter or trim rings. Power and communications shall be supplied by the Addressable Controller channel SLC; dual port design shall accept communications and power from either port and shall automatically isolate one port from the other when a short circuit occurs. The following functionality shall be included in the Isolator module:

- a. Report faults to the host FACP.
- b. On-board Yellow LED provides module status.
- c. After the wiring fault is repaired, the Isolator modules shall test the lines and automatically restore the connection.

ADD 7-010

Section 26 00 00 "Electrical"; Article 2.17.0: Replace with the following: Notification Appliances

- 1. ADA High Intensity Strobe Audio-Visual Alarm Indicating Appliances
 - Speaker/strobe with multi candela capability shall be listed with Underwriter's Laboratories for use with Fire Protective Signaling Systems. Speaker/strobe shall have a minimum sound output of 96dB @ 10 feet and shall be flush mounted. The speaker shall sound in a Temporal pattern. The strobe shall have a candela rating that meets or exceeds the requirements of the Americans with Disabilities Act (ADA) and shall be of such rating as shown on the Drawings. The device shall be rated at 24 VDC nominally and have an acceptable operating range of 20-30 VDC.
 - b. The device shall mount to a 4" square deep with extension ring.
 - c. All strobes shall be synchronized.
 - d. Color for ceiling mounted device shall be white and color for wall mounted device shall be red, unless otherwise noted.
- 2. ADA High Intensity Strobe High Audio Output/Audio-Visual Alarm

Indicating Appliances

- a. Wheelock high performance speakers (ET70-W) and series speaker strobes (ET70-24MCW-FW) shall provide high audio output, clear audibility and field selectable taps from 1/8 to 8 watts.
- b. Any additional amplifiers shall be provided to accommodate required wattage.
- c. The device shall mount to a 4" square deep with extension ring.
- d. All strobes shall be synchronized.
- e. Color of devices shall be white, unless otherwise noted.
- 3. ADA High Intensity Strobe Only Unit
 - a. Unit shall be listed with Underwriter's Laboratories for use with Fire Protective Signaling Systems and accepted by the local Authority Having Jurisdiction. The strobe shall meet or exceed the requirements of the Americans with Disabilities Act (ADA) and shall be of such rating as shown on the Drawings. The device shall be rated at 24 vdc and shall have a flash rate of 1 HZ.
 - b. All strobes shall be synchronized.
 - c. Color for ceiling mounted device shall be white and color for wall mounted device shall be red, unless otherwise noted.
- ADD 7-011 Section 26 00 00 "Electrical"; Article.2.6.G.13: Replace with the following: Provide Shielded Cat 6A patch cable from all sub-meters listed below to data outlets in the room. Refer to Drawings for locations of Sub-meters:
 - a. Natural Gas Sub-meters
 - b. Water Sub-meters
 - c. Switchboard Sub-meters
- ADD 7-012 Section 31 00 00 "Earthwork"; Article 1.3, Paragraph B; subparagraph 11; DELETE the number "32 13 13" and replace with the number "32 13 12" as follows:
 - 11. Section 32 13 12, Site Concrete
- ADD 7-013 Section 31 00 00 "Earthwork"; Article 1.3, Paragraph B; DELETE subparagraph 15.
- ADD 7-014 Section 31 00 00 "Earthwork"; Article 1.6, Paragraph A; DELETE the sentence "The Contractor shall refer to Section 00 31 32.".
- ADD 7-015 Section 31 60 00 "Ground Improvements"; Article 1.03, Paragraph A; ADD the words "headwalls, culverts" as follows:
 - a. Provision of all equipment, material, labor, and supervision to design, furnish, and install aggregate piers and/or rigid inclusions for support of building foundations, floor slabs, stairs, access ramps, retaining walls, sidewalk attached/connected to the proposed building, utility structures, **headwalls**, **culverts**, and twin 48-inch combined sewer pipes.
- ADD 7-016 Section 28 00 00 "Electronic Safety and Security"; paragraph 2.13.D, ADD the following paragraph as item 3:
 - 3. One output to FACP shall be to trigger the FACP to energize the amber strobes on the exterior of the building to alert those outside that

a lockdown event is in progress inside the building. When the relay is de-energized, (the lockdown event is cleared) the strobes shall turn off.

DRAWINGS:

ADD 7-017	C1.0 – EXISTING CONDITIONS AND DEMOLITION
ADD 7-018	L3.03 – DETAILS
ADD 7-019	L3.04 – DETAILS
ADD 7-020	A8.41 – ENLARGED TOILET ROOM PLANS
ADD 7-021	A8.42 – ENLARGED TOILET ROOM PLANS
ADD 7-022	A8.43 – ENLARGED TOILET ROOM PLANS
ADD 7-023	A8.44 – ENLARGED TOILET ROOM INTERIOR ELEVATIONS
ADD 7-024	A8.47 – ENLARGED LOCKER ROOM PLANS & INTERIOR ELEVATIONS
ADD 7-025	E0.01 – ELECTRICAL LEGEND
ADD 7-026	E1.12C - ELECTRICAL SECOND FLOOR LIGHTING PLAN - ZONE C
ADD 7-027	E1.14B - ELECTRICAL FOURTH FLOOR LIGHTING PLAN - ZONE B
ADD 7-028	E2.11A - ELECTRICAL FIRST FLOOR POWER PLAN – ZONE
ADD 7-029	E2.11B - ELECTRICAL FIRST FLOOR POWER PLAN - ZONE B
ADD 7-030	E2.11C - ELECTRICAL FIRST FLOOR POWER PLAN - ZONE C
ADD 7-031	E2.12A -ELECTRICAL SECOND FLOOR POWER PLAN - ZONE A
ADD 7-032	E2.12B - ELECTRICAL SECOND FLOOR POWER PLAN - ZONE B
ADD 7-033	E2.12C - ELECTRICAL SECOND FLOOR POWER PLAN - ZONE C
ADD 7-034	E2.13A - ELECTRICAL THIRD FLOOR POWER PLAN - ZONE A
ADD 7-035	E2.13B - ELECTRICAL THIRD FLOOR POWER PLAN - ZONE B
ADD 7-036	E2.13C - ELECTRICAL THIRD FLOOR POWER PLAN - ZONE C
ADD 7-037	E2.14A - ELECTRICAL FOURTH FLOOR POWER PLAN - ZONE A
ADD 7-038	E2.14B - ELECTRICAL FOURTH FLOOR POWER PLAN - ZONE C
ADD 7-039	E2.15B - ELECTRICAL ROOF POWER PLAN - ZONE B
ADD 7-040	E2.15C - ELECTRICAL ROOF POWER PLAN - ZONE C
ADD 7-041	E4.02 – ELECTRICAL FIRE ALARM RISER DIAGRAM
ADD 7-042	E5.01 – ELECTRICAL LIGHTING FIXTURE SCHEDULE
ADD 7-043	EF3.11A - ELECTRICAL FIRST FLOOR FIRE ALARM PLAN - ZONE A
ADD 7-044	EF3.11B - ELECTRICAL FIRST FLOOR FIRE ALARM PLAN - ZONE B

ADD 7-045	EF3.11C - ELECTRICAL FIRST FLOOR FIRE ALARM PLAN - ZONE C
ADD 7-046	EF3.12A - ELECTRICAL SECOND FLOOR FIRE ALARM PLAN - ZONE A
ADD 7-047	EF3.12B - ELECTRICAL SECOND FLOOR FIRE ALARM PLAN - ZONE B
ADD 7-048	EF3.12C - ELECTRICAL SECOND FLOOR FIRE ALARM PLAN - ZONE C
ADD 7-049	EF3.13A - ELECTRICAL THIRD FLOOR FIRE ALARM PLAN - ZONE A
ADD 7-050	EF3.13B - ELECTRICAL THIRD FLOOR FIRE ALARM PLAN - ZONE B
ADD 7-051	EF3.13C - ELECTRICAL THIRD FLOOR FIRE ALARM PLAN - ZONE C
ADD 7-052	EF3.14A - ELECTRICAL FOURTH FLOOR FIRE ALARM PLAN - ZONE A
ADD 7-053	EF3.14B - ELECTRICAL FOURTH FLOOR FIRE ALARM PLAN - ZONE B
ADD 7-054	EF3.15A - ELECTRICAL ROOF FIRE ALARM PLAN - ZONE A
ADD 7-055	EF3.15B - ELECTRICAL ROOF FIRE ALARM PLAN - ZONE B
ADD 7-056	EF3.15C - ELECTRICAL ROOF FIRE ALARM PLAN - ZONE C
CHMENTS:	

ATTAC

ADD 7-057 RIDEM Remedial Action Approval Letter

- EXISTING UTILITY INFORMATION SHOWN HEREON IS BASED UPON PREVIOUS DESIGN DRAWINGS AND RECORD INFORMATION. LOCATIONS, SIZES, AND DEPTHS OF UTILITIES HAVE NOT BEEN SURVEYED IN THE FIELD. ADDITIONAL SITE SURVEY IS ONGOING.
- DEMOLITION OF EXISTING BUILDING AND SITE FEATURES ARE INCLUSIVE OF ALL PHASES. PROPOSED DEMOLITION ACTIVITIES SHOWN ON THESE SHEETS ARE NOT
- ALL EROSION AND SEDIMENT CONTROLS SHALL BE INSTALLED PRIOR TO COMMENCEMENT OF ANY EARTH MOVING ACTIVITIES.

INTENDED TO INDICATE THE PHASE IN WHICH THEY OCCUR. SEE PHASING DRAWINGS FOR DEMOLITION SPECIFIC TO PHASING.

- THE EROSION AND SEDIMENTATION CONTROLS SHOWN ON THE PLANS ARE INTENDED TO REPRESENT THE MINIMUM CONTROLS NECESSARY TO MEET ANTICIPATED SITE CONDITIONS. ADDITIONAL MEASURES SHALL BE IMPLEMENTED AS CONDITIONS WARRANT OR AS DIRECTED BY THE OWNER OR OWNER'S REPRESENTATIVE.
- INSTALL EROSION CONTROLS DOWNSTREAM OF ANY DISTURBED AREAS TO REDUCE POTENTIAL FOR EROSION. CONTRACTOR SHALL INDICATE LOCATIONS OF EROSION CONTROLS FOR REVIEW WITH GENERAL CONTRACTOR AND OWNER'S PROJECT MANAGER PRIOR TO COMMENCING DISTURBANCE. EROSION AND SEDIMENT

CONTROLS SHALL BE INSTALLED AND MAINTAINED IN ACCORDANCE WITH THE LATEST REVISION OF THE RI SOIL EROSION AND SEDIMENT CONTROL HANDBOOK.

- INSTALL CHAIN LINK FENCE TREE PROTECTION AT THE LOCATIONS SHOWN ON THE PLAN TO PROTECT EXISTING TREES SPECIFICALLY INDICATED ON THE PLAN. LAYOUT OF FENCE SHALL BE REVIEWED AND APPROVED BY THE LANDSCAPE ARCHITECT. TREE PROTECTION SHALL BE MAINTAINED THROUGHOUT ALL PHASES OF CONSTRUCTION.
- ALL EXISTING DRAINAGE SHALL BE MAINTAINED OR REROUTED AS NECESSARY UNTIL PERMANENT PIPING IS INSTALLED.
- ELECTRICAL DEMOLITION IS SHOWN FOR INFORMATION ONLY. REFER TO ELECTRICAL PLANS FOR COMPLETE EXTENT OF ELECTRICAL DEMOLITION.
- PROVIDE INLET PROTECTION AT ALL EXISTING DRAINAGE INLETS.
- 10. ALL ITEMS TO BE REMOVED AND STOCKPILED SHALL BE COORDINATED WITH OWNER FOR STOCKPILE LOCATIONS. AT THIS TIME, THE OWNER HAS NOT IDENTIFIED ITEMS FOR STOCKPILE.
- 11. ALL ITEMS MARKED FOR RE-USE SHALL BE STOCKPILED ONSITE, PROTECTED AND RE-INSTALLED AS SHOWN ON THE LANDSCAPE PLANS.
- 12. DRAINAGE FEATURES AND UTILITIES TO BE MAINTAINED UNLESS OTHERWISE NOTED.
- 13. TOTAL AREA OF DISTURBANCE: 2.3 ACRES.
- 14. CONTRACTOR TO REESTABLISH BENCHMARKS IN ALTERNATE LOCATION PRIOR TO CONSTRUCTION.
- 15. CONTRACTOR SHALL COORDINATE CLEARING OF ALL ABUTTER ENCROACHMENTS WITH THE CITY OF CENTRAL FALLS PRIOR TO CONSTRUCTION.
- INSTALL CONSTRUCTION ENTRANCE AT ALL ENTRY/EXIT POINT FOR VEHICULAR TRAFFIC FOR EACH PHASE OF THE PROJECT.
- 17. ALL EARTH DISTURBANCE SHALL BE CONDUCTED IN ACCORDANCE WITH THE PROJECT SPECIFICATIONS.
- 18. ACTIVE UTILITY LINES (INCLUDING SEWER, WATER, AND DRAINAGE), CONTRACTOR SHALL PROVIDE 1 WEEK NOTIFICATION FOR ANY POSSIBLE DISRUPTION OF SERVICE TO OWNER, OWNER'S REPRESENTATIVE AND ARCHITECT; PROVIDE NOTIFICATION FOR CONNECTING, DISCONNECTING, TURNING ON OR TURNING OFF ANY SERVICE WHICH MAY AFFECT USERS OF THE RESPECTIVE UTILITY.
- 19. CONTRACTOR SHALL PROVIDE 72 HOUR (3 WORKING DAYS) NOTICE TO LOCAL FIRE DEPARTMENT OF DISRUPTIONS.
- 20. DISTURBANCE ON ACTIVE GAS LINES SHALL BE COORDINATED WITH UTILITY PROVIDER.
- 21. THE CONTRACTOR SHALL CONFIRM LOCATION AND ELEVATION OF THE EXISTING DRAINAGE MANHOLES AND PIPES INDICATED. IT SHALL BE ASSUMED THAT AN ADDITIONAL 60 FEET OF PIPE WILL NEED TO BE REMOVED AND DISPOSED.
- 22. ANY UNFORESEEN UNDERGROUND TRANSITE PIPE OR OTHER UNFORESEEN HAZARDOUS MATERIAL SHALL BE ABATED IN ACCORDANCE WITH THE SPECIFICATIONS AND ALL LOCAL, STATE AND FEDERAL REGULATIONS.
- 23. CONTRACTOR SHALL COMPLY WITH ALL CHPS REQUIREMENTS FOR DEMOLITION.
- 24. ALL EXISTING MANHOLES OR CATCH BASINS TO REMAIN SHALL BE ADJUSTED TO FINISHED GRADE ELEVATION.
- 25. ALL EXISTING UTILITIES WITHIN TREE PROTECTION AREAS NOT SCHEDULED FOR RE-USE SHALL BE CUT, CAPPED, AND ABANDONED IN PLACE.
- 26. DEMOLITION WORK SHOWN ON THIS SHEET IS INDEPENDENT OF PROJECT PHASING OR SEQUENCING. CONTRACTOR SHALL BE RESPONSIBLE FOR SEQUENCING ALL WORK AS OUTLINED IN THE PROJECT SPECIFICATIONS.
- 27. CONTRACTOR SHALL SCHEDULE PRECONSTRUCTION MEETING WITH ARCHITECT, LANDSCAPE ARCHITECT, CIVIL ENGINEER, STRUCTURAL ENGINEER, AND OWNER'S PROJECT MANAGER PRIOR TO DEMOLITION OF EXISTING SERVICE AREA TO CONFIRM EXTENT OF DEMOLITION AND SAWCUT LOCATIONS.
- 28. THE CONTRACTOR MUST CONTACT THE APPROPRIATE PRIVATE UTILITY COMPANIES AND "DIGSAFE" AT LEAST 72 HOURS PRIOR TO ANY EXCAVATION WORK BEING COMPLETED. THE CONTRACTOR IS HEREBY NOTIFIED THAT SOME PUBLIC AND PRIVATE UTILITY COMPANIES ARE NOT PART OF "DIGSAFE" AND MAY HAVE ADDITIONAL NOTIFICATION REQUIREMENTS.
- 29. CUT AND CAP EXISTING WATER AND SEWER SERVICES AT THE MAIN PRIOR TO ANY BUILDING DEMOLITION.
- 30. USE OF FIRE HYDRANTS FOR DEMOLITION OR CONSTRUCTION IS NOT PERMITTED UNLESS APPROVED BEFOREHAND BY THE PAWTUCKET WATER SUPPLY BOARD.
- 31. THE CONTRACTOR SHALL KEEP ON SITE, AT ALL TIMES, ADDITIONAL SILTATION FENCING AND FILTER FABRIC FOR INSTALLATION AS DIRECTED BY THE CITY TO MITIGATE ANY EMERGENCY CONDITIONS.
- 32. CONTRACTOR TO CAMERA INSPECT AND LOCATE EXISTING SEWER AND DRAIN THROUGHOUT SITE.
- 33. EXISTING SEWER AND DRAIN MUST REMAIN ACTIVE AT ALL TIMES.
- 34. NO CONTRACTOR PARKING ON ROADWAYS.
- 35. THE CONCRETE CULVERT AND TWIN 48" PIPES ARE PART OF AN ACTIVE COMBINED SEWER OVERFLOW SYSTEM. IT IS ANTICIPATED THAT FLOWS OF UP TO 40 MGD MAY OCCUR DURING SIGNIFICANT WET WEATHER EVENTS. THE CONTRACTOR SHALL PROVIDE AND MAINTAIN THE CAPABILITY TO BYPASS PUMP SUCH FLOWS AT ALL TIMES WHEN THE PIPELINE IS DISRUPTED FOR RE-ROUTING. BYPASS PUMPING SYSTEM SHALL INCLUDE BOTH PRIMARY AND BACKUP CAPACITY.
- 36. THE CONTRACTOR SHALL PROVIDE AND MAINTAIN THE CAPABILITY TO BYPASS PUMP FLOWS AT ALL TIMES WHEN THE EXISTING DRAINAGE SYSTEM IS DISRUPTED FOR RE-ROUTING. BYPASS PUMPING SYSTEM SHALL INCLUDE BOTH PRIMARY AND BACKUP CAPACITY.
- 37. IRRIGATION SYSTEM INFORMATION HAS BEEN OBTAINED FROM THE "GRADING AND IRRIGATION PLAN" FROM WILFRID L. GATES JR LANDSCAPE ARCHITECT DATED
- 38. BORING AND MONITORING WELL INFORMATION HAS BEEN OBTAINED FROM THE FOLLOWING:
 - PHASE I ENVIRONMENTAL SITE ASSESSMENT PREPARED BY SAGE ENVIRONMENTAL, INC. DATED NOVEMBER 8, 2021
 - SITE INVESTIGATION REPORT PREPARED BY SAGE ENVIRONMENTAL, INC. DATED MAY 2023 • PRELIMINARY GEOTECHNICAL REPORT PREPARED BY LAHLAF GEOTECHNICAL CONSULTING, INC. DATED FEBRUARY 7, 2023
- 38. LIGHT POLES AND FIXTURES AT THE EXISTING BASKETBALL COURTS AND THE EXISTING FLAG POLE SHALL BE REMOVED AND SALVAGED. THESE SHALL BE DELIVERED TO THE CENTRAL FALLS DPW AT 1280 HIGH STREET, CENTRAL FALLS, RI 02863.
- 39. THE CONTRACTOR SHALL CLEAR AND GRUB ALL EXISTING VEGETATION WITHIN THE LIMITS OF DISTURBANCE UNLESS NOTED OTHERWISE.
- 40. THE CONTRACTOR SHALL BE RESPONSIBLE FOR ALL COSTS RELATED TO DEWATERING EXCAVATION, BOTH FROM GROUNDWATER AND STORMWATER RUNOFF. THE CONTRACTOR SHALL ALSO BE RESPONSIBLE FOR DETERMINING FLOW RATES AND VOLUMES. DISCHARGE OF DEWATERING EFFLUENT SHALL BE IN ACCORDANCE WITH THE REQUIREMENTS OF THE RESPECTIVE AUTHORITY HAVING JURISDICTION.

BID ALTERNATE NOTES:

BASE BID AND ALTERNATE.

BOTH THE BASE BID AND ALTERNATE.

ALTERNATE 2 - OUTDOOR FURNITURE: DEMOLITION WORK SHOWN ON THIS SHEET IS ANTICIPATED TO BE CONSISTENT WITH BOTH THE BASE BID AND ALTERNATE. REFER TO LANDSCAPE DRAWINGS FOR INFORMATION REGARDING THE BASE BID AND ALTERNATE.


ALTERNATE 3 - OUTDOOR CLASSROOM: OUTDOOR CLASSROOM FEATURES ASSOCIATED WITH THE ALTERNATE ARE SHOWN AS BACKGROUND INFORMATION ON THIS SHEET. DEMOLITION WORK SHOWN ON THIS SHEET IS ANTICIPATED TO BE CONSISTENT WITH

ALTERNATE 5 - FREIGHT FARM UNIT: DEMOLITION WORK SHOWN ON THIS SHEET IS ANTICIPATED TO BE CONSISTENT WITH BOTH THE BASE BID AND ALTERNATE. REFER TO ARCHITECTURAL AND LANDSCAPE DRAWINGS FOR INFORMATION REGARDING THE BASE BID AND

ALTERNATE. ALTERNATE 6 - THROWING EVENTS: DEMOLITION WORK SHOWN ON THIS SHEET IS ANTICIPATED TO BE CONSISTENT WITH BOTH THE

ALTERNATE 9 - SPORTS LIGHTING: ALL WORK SHOWN ON THE CIVIL DRAWING SHEETS ARE ANTICIPATED TO BE CONSISTENT WITH BOTH THE BASE BID AND ALTERNATE. REFER TO THE ELECTRICAL DRAWINGS FOR INFORMATION REGARDING SITE ELECTRIC.

ALTERNATE 10 - TREES: DEMOLITION WORK SHOWN ON THIS SHEET IS ANTICIPATED TO BE CONSISTENT WITH BOTH THE BASE BID AND ALTERNATE. REFER TO LANDSCAPE DRAWINGS FOR INFORMATION REGARDING THE BASE BID AND ALTERNATE.

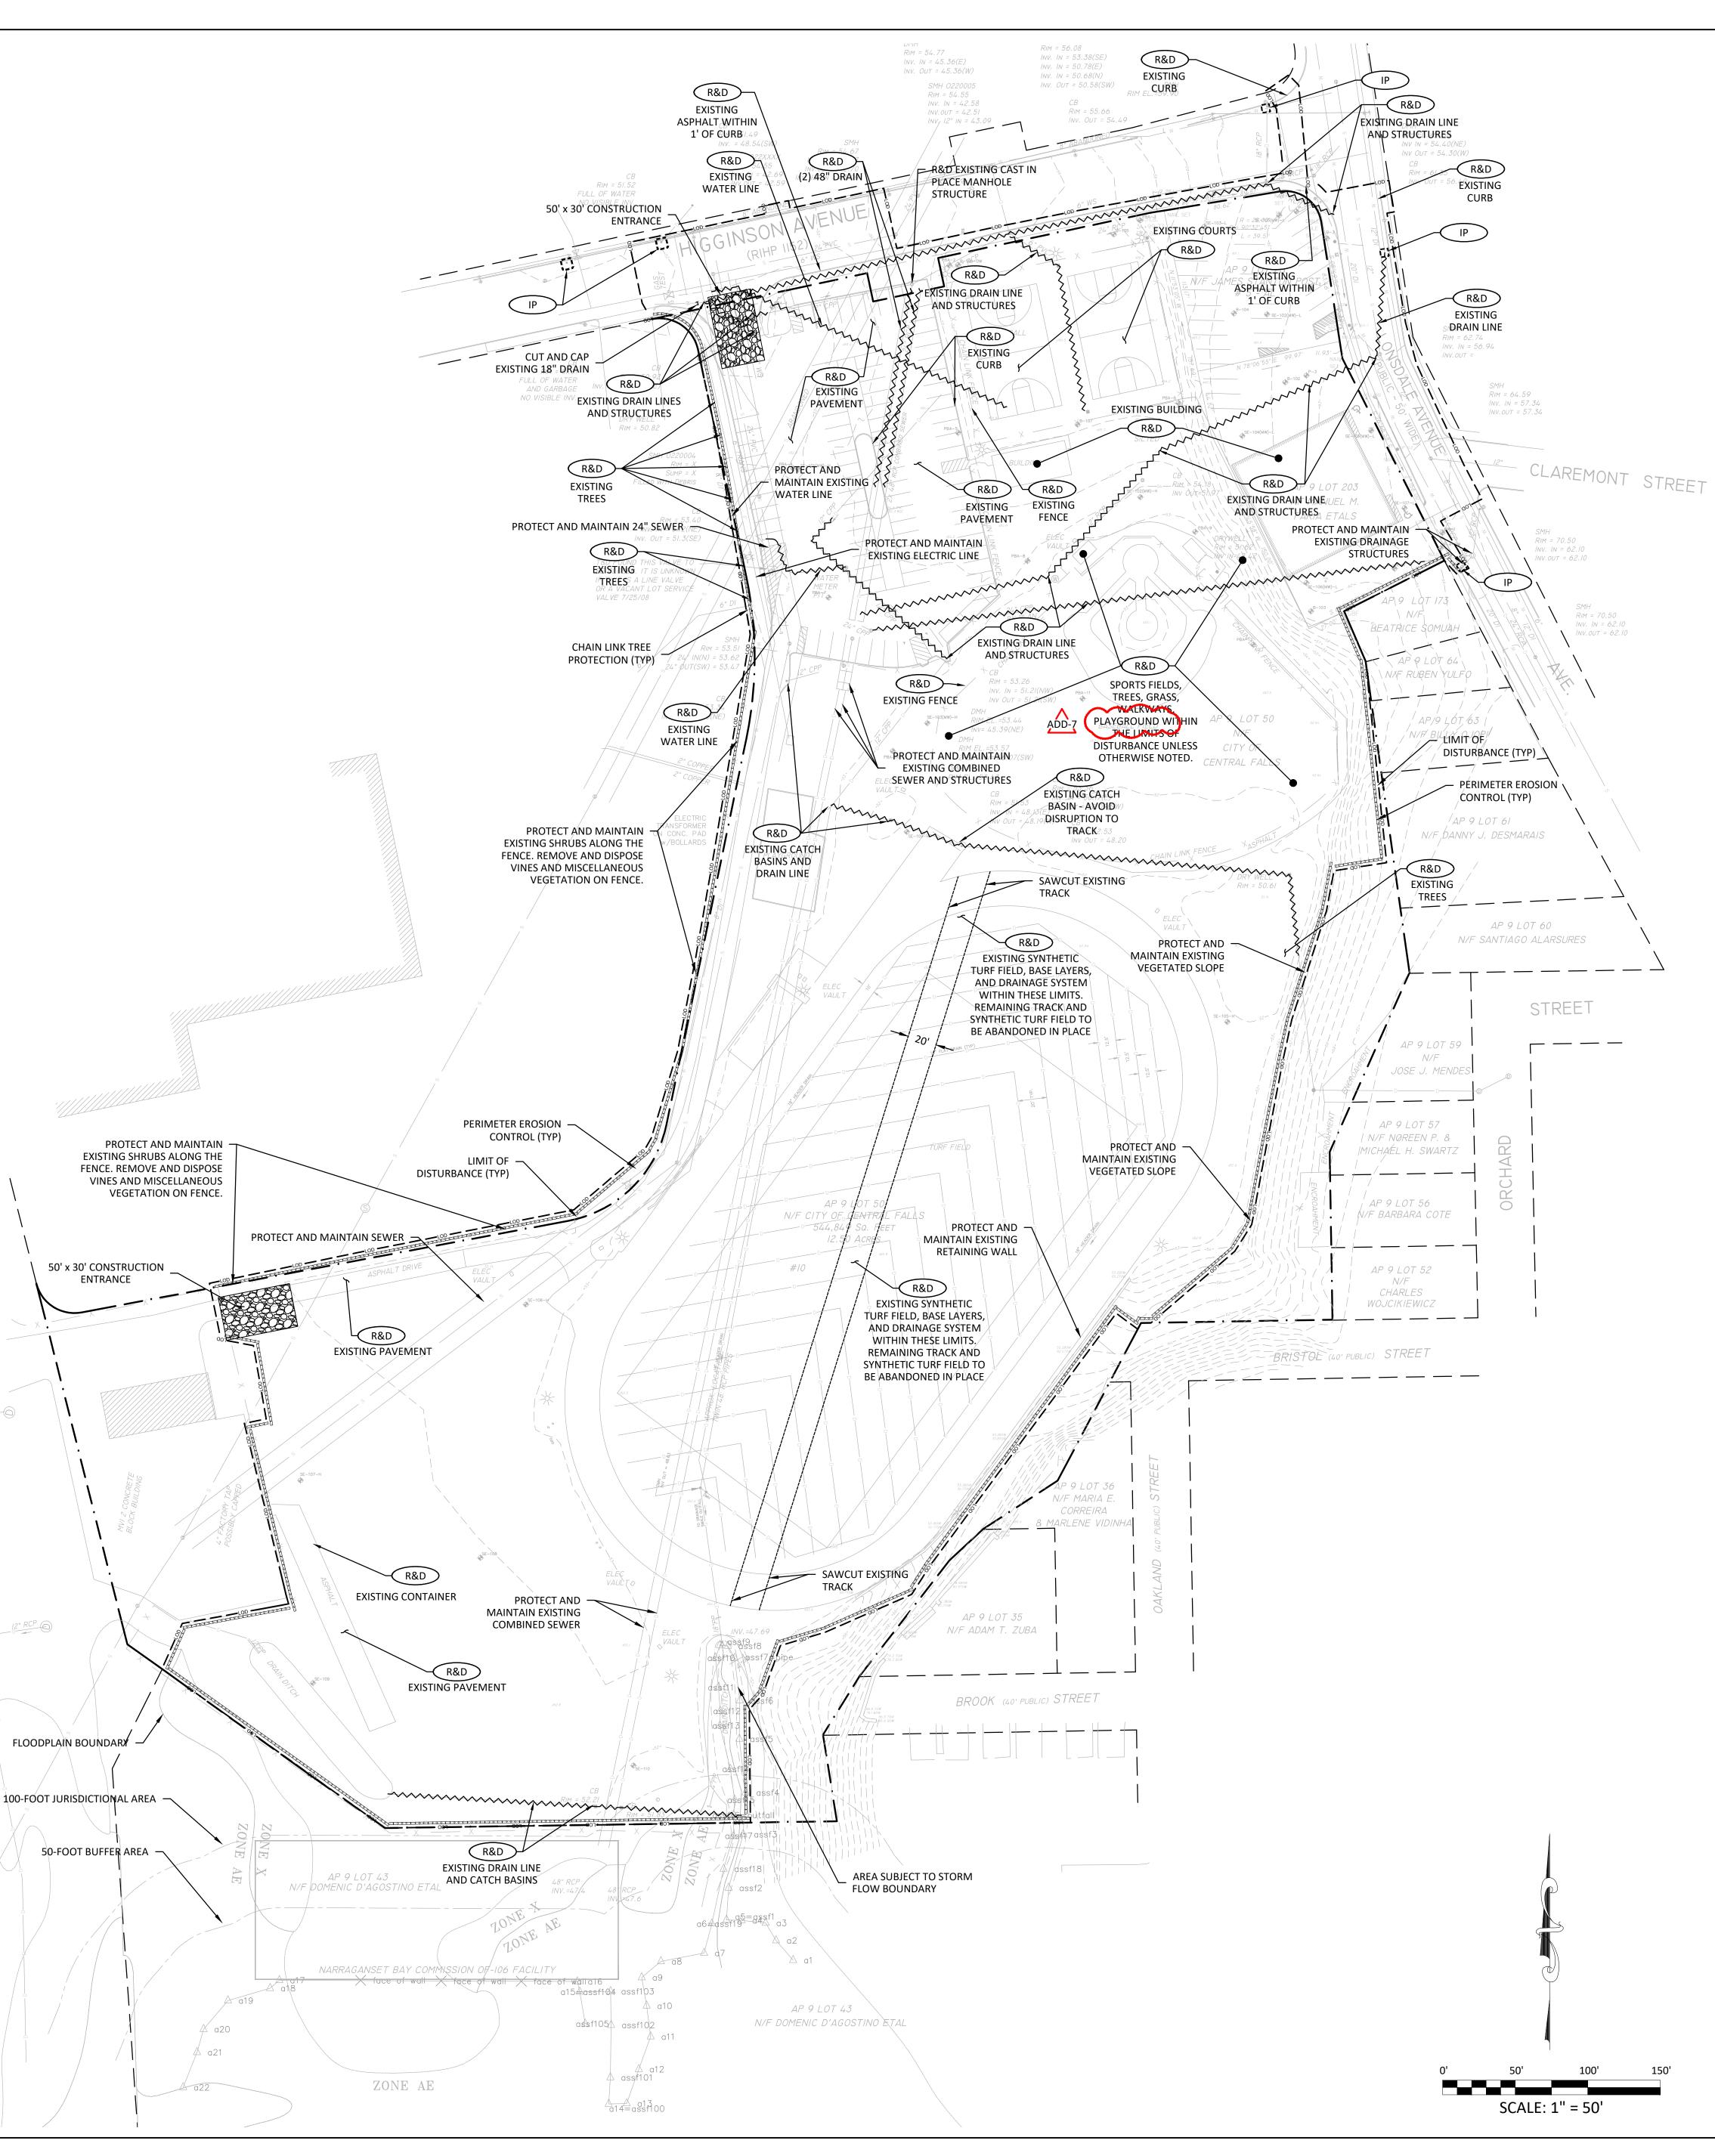




The Vertex Companies, LLC 400 Libbey Parkway Weymouth, MA 02189 **PHONE** 781.952.6000 www.vertexeng.com




CENTRAL FALLS HIGH SCHOOL 10 HIGGINSON AVE, CENTRAL FALLS, RI **KEYNOTE LEGEND:**

ADD-7 ADDENDUM #7 01.26.2024 **100% CONSTRUCTION DOCUMENTS**

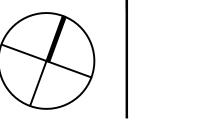


NORTH ARROW

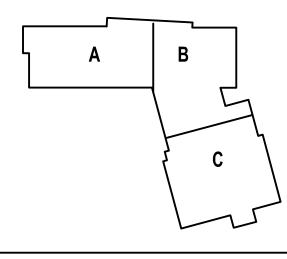

DRAWING NAME: **EXISTING CONDITIONS** AND DEMOLITION PLAN

DRAWN BY: REVIEWED BY: SCALE: AS NOTED | DRAWING NUMBER: JOB NO.:

DATE: OCTOBER 13, 2023

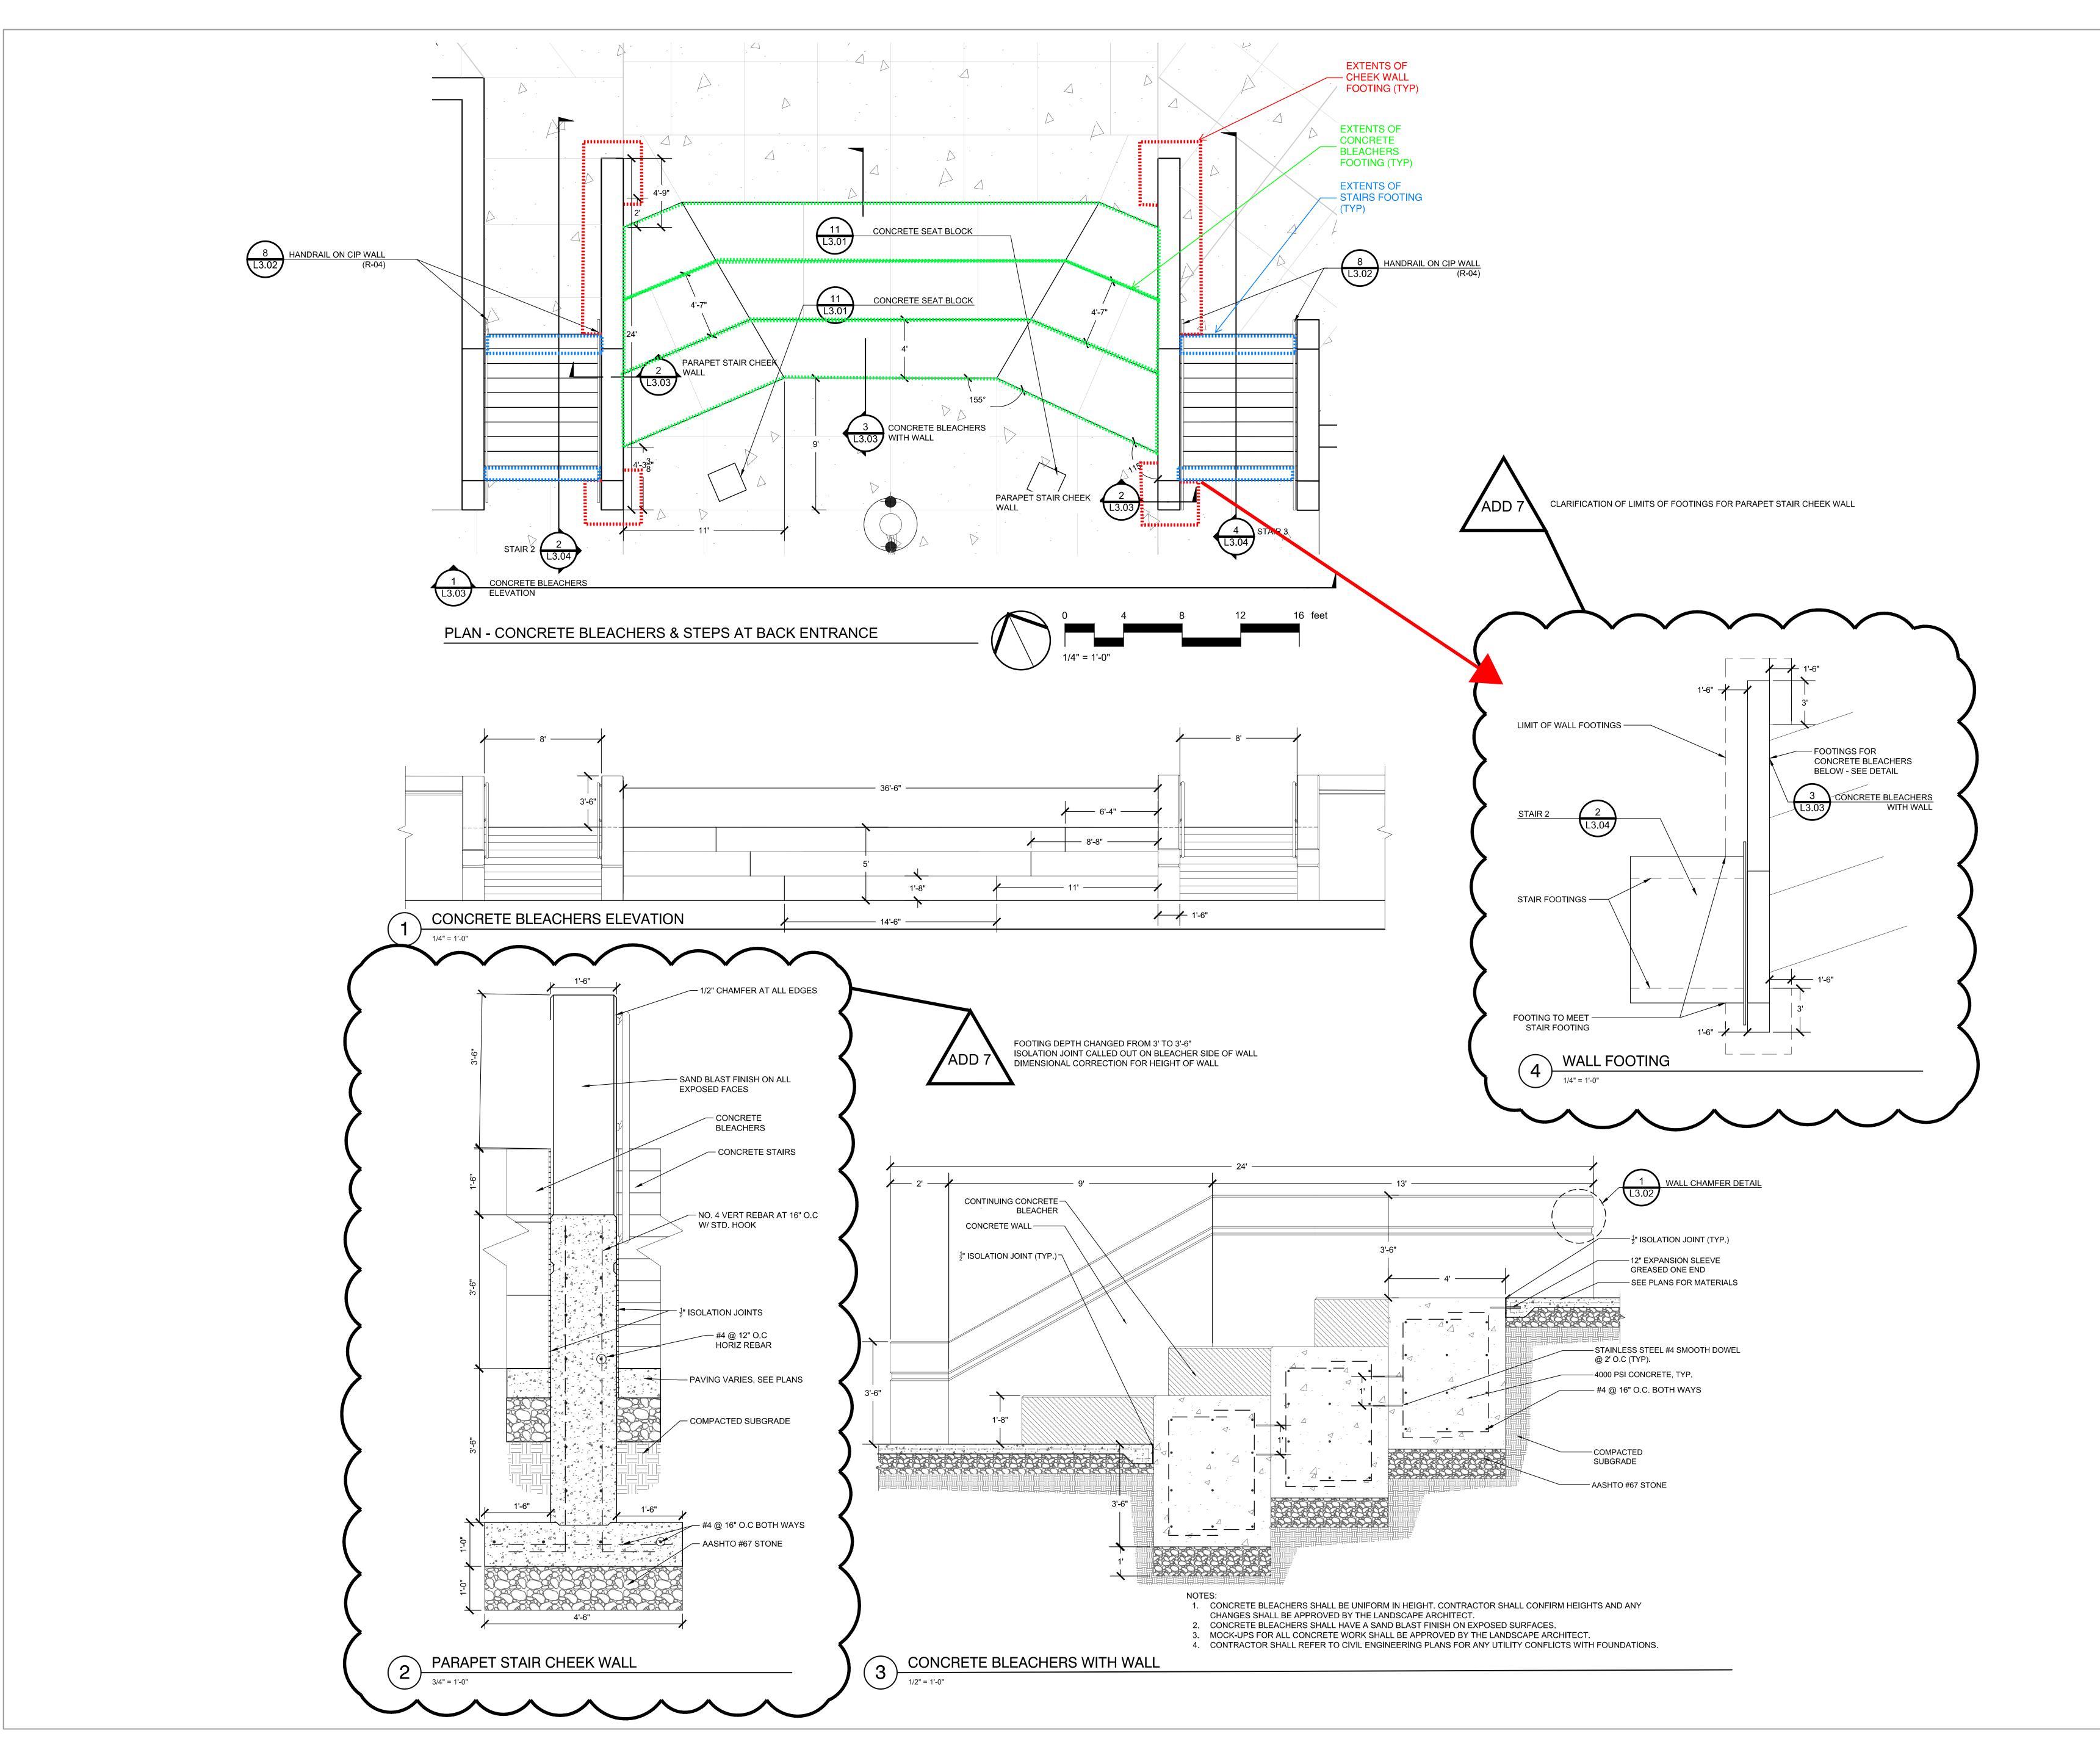



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CENTRAL FALLS HIGH SCHOOL 10 HIGGINSON AVE, CENTRAL FALLS, RI

KEYNOTE LEGEND:

100% CONSTRUCTION DOCUMENTS

KEY PLAN NORTH ARROW

KEYPLAN

DRAWING NAME:


DETAILS

DRAWN BY: J. FIGLIOZZI, E. LIMON

REVIEWED BY: S. D'AMBROSIA, J. ROBERTSHAW

SCALE: AS NOTED | DRAWING NUMBER:

JOB NO.: K1031 | L3.03

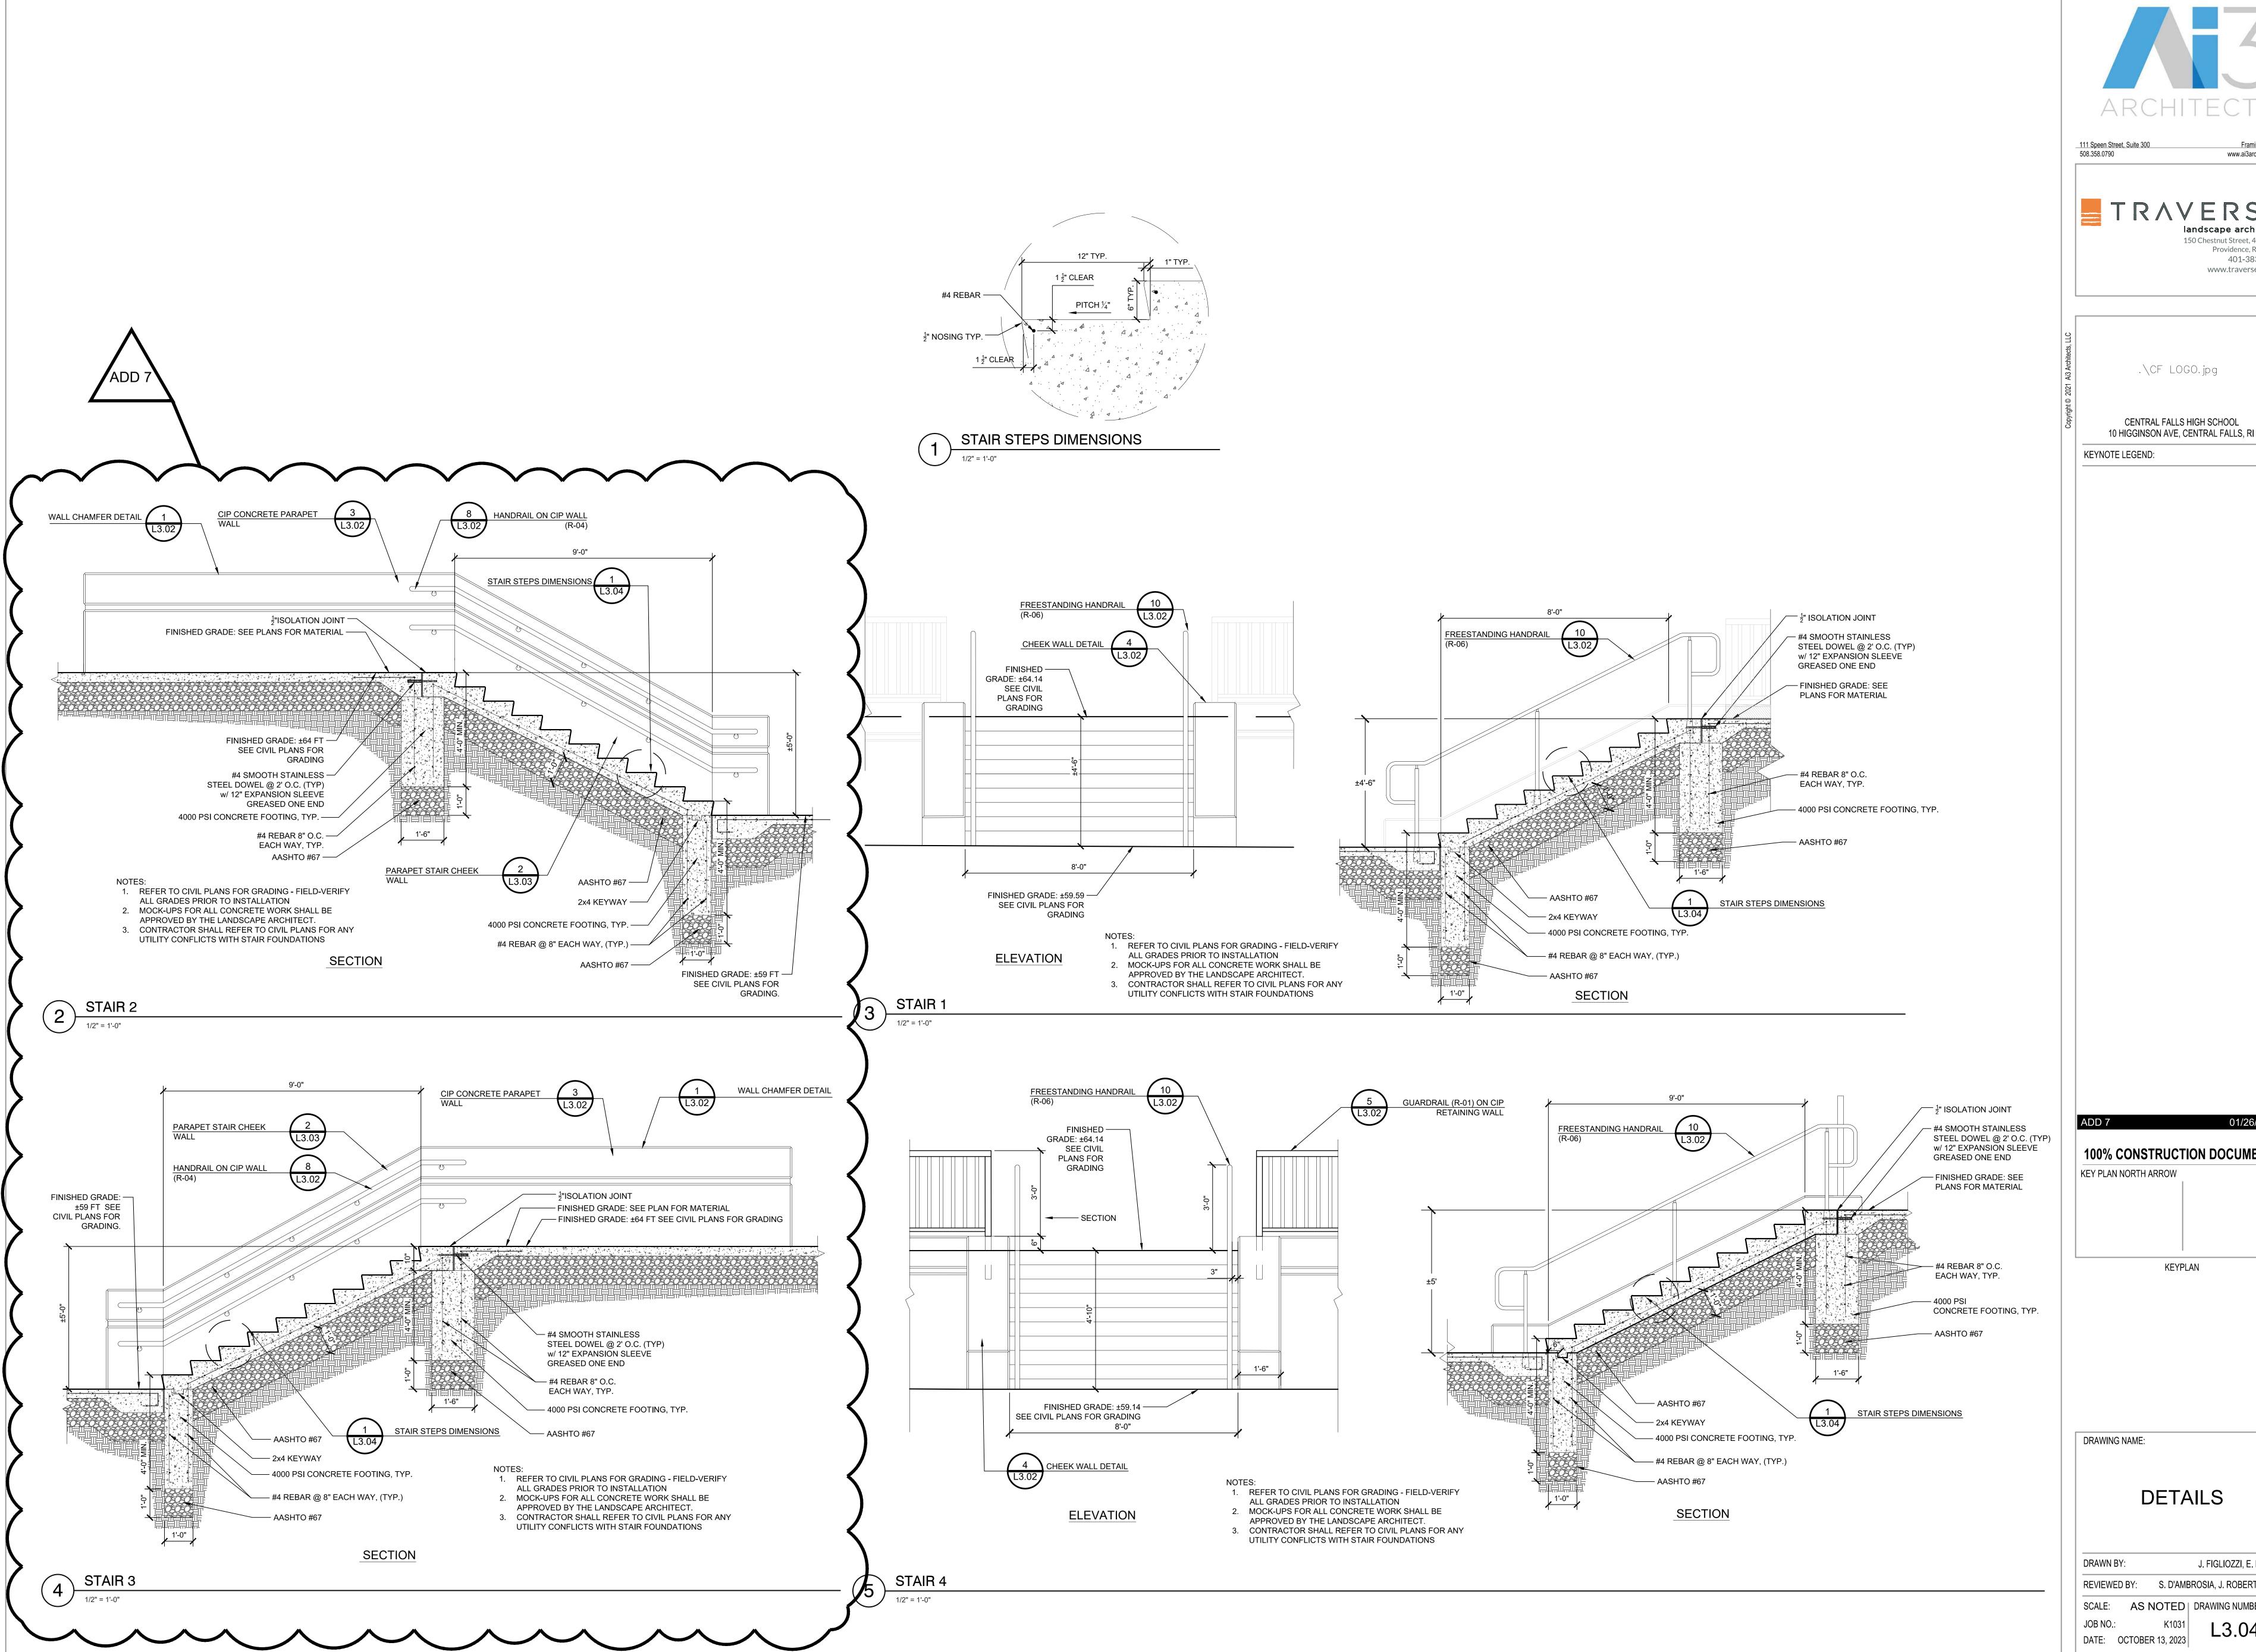



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CENTRAL FALLS HIGH SCHOOL

01/26/2024 100% CONSTRUCTION DOCUMENTS KEY PLAN NORTH ARROW KEYPLAN

DRAWING NAME:

DETAILS

J. FIGLIOZZI, E. LIMON DRAWN BY: S. D'AMBROSIA, J. ROBERTSHAW SCALE: AS NOTED | DRAWING NUMBER:

DESCRIPTION	NOTES
SOAP DISPENSERS AND PAPER TOWEL DISPENSERS	IN ADDITION TO ALL TOILET ROOM AND LOCKER ROOM LOCATIONS SHOWN, PROVIDE CONCEALED BLOCKING FOR ONE PAPER TOWEL AND ONE SOAP DISPENSER AT EACH SINK THROUGHOUT THE BUILDING.
SOAP DISPENSERS	ALL SOAP DISPENSERS SHALL BE OWNER FURNISHED AND INSTALLED. 06 10 00 - ROUGH CARPENTRY SHALL PROVIDE CONCEALED BLOCKING AS REQUIRED AT ALL SURFACE MOUNTED LOCATIONS.
TOILET TISSUE DISPENSERS AND SANITARY NAPKIN DISPOSALS	COORDINATE EXACT MOUNTING HEIGHT OF GRAB BARS WITH ARCHITECT. IN FIELD. NOTE: TOILET TISSUE DISPENSERS SHALL BE 15" A.F.F., WITH TOP OF DISPENSER 1 1/2" MIN. BELOW THE SIDE GRAB BAR AND 7" TO 9" FROM THE FRONT EDGE OF THE TOILET TO THE CENTERLINE OF THE DISPENS
GRAB BARS	PROVIDE 1 1/2" CLEARANCE FROM WALL WITH CONCEALED MOUNTING.
MOP HOLDER	PROVIDE ONE AT EACH MOP SINK LOCATION THROUGHOUT THE BUILDING TO BE MOUNTED OVER MOP SINK AT 5' - 6" A.F.F.
COAT HOOK	PROVIDE ONE AT EACH TOILET ROOM PARTITION STALL DOOR MOUNTED TO STALL SIDE OF DOOR AND PROVIDE ONE AT EACH SINGLE TOILET ROOM DOOR ON TOILET SIDE OF DOOR. CENTERED ON ALL DOORS. ALSO PROVIDE AT ADDITIONAL LOCATIONS SHOWN ON DRAWINGS.
PLUMBING FIXTURES	SEE PLUMBING DRAWINGS FOR PLUMBING FIXTURE MOUNTING HEIGHT AND LOCATION VERIFICATIONS.
STAINLESS STEEL SHELVES	PROVIDE ONE AT EACH CUSTODIAN CLOSET MOUNTED ABOVE THE SINK. PROVIDE ONE AT EACH SINGLE USER TOILET ROOM MOUNTED TO WALL ACROSS FROM TOILET. COORDINATE HEIGHT WITH OWNER / ARCHITECT IN THE FIELD.
RFACE MOUNTED TOILET ACCESSORIES	06 10 00 - ROUGH CARPENTRY SHALL PROVIDE CONCEALED BLOCKING AS REQUIRED AT ALL SURFACE MOUNTED LOCATIONS.

FIXTURE LEGEND

- (WC) WATER CLOSET: ADULT WCA) WATER CLOSET: ADULT ACCESSIBLE
- UR URINAL: ADULT
- URA) URINAL: ADULT ACCESSIBLE (LAV) LAVATORY: ADULT
- (LAVA) LAVATORY: ADULT ACCESSIBLE
- SHRA) SHOWER: ACCESSIBLE
- SS SERVICE SINK
- (FD) FLOOR DRAIN HB HOSE BIB SHR SHOWER
- **TOILET ACCESSORY LEGEND: SEE SPEC SECTION 10 28 13**
- (G.1) STAINLESS STEEL HORIZONTAL GRAB BAR (REAR WALL) (G.2) STAINLESS STEEL HORIZONTAL GRAB BAR (SIDE WALL)
- G.2 STAINLESS STEEL VERTICAL GRAB BAR (SIDE WALL)
- (GS1.1) STAINLESS STEEL GRAB BAR: 2'-6" X 5' HC SHOWER STALL (WALL ADJ. SEAT)
- (GS1.2) STAINLESS STEEL GRAB BAR: 2'-6" X 5' HC SHOWER STALL (BACK WALL) M STAINLESS STEEL FRAMED MIRROR
- (SD) SOAP DISPENSER
- (CTA) CHANGING TABLE: ADULT


(PT) SURFACE MOUNTED PAPER TOWEL DISPENSER

- (FH1) FEMININE HYGEINE DISPENSER (TYPE 1)
- FH2 FEMININE HYGIENE DISPENSER (TYPE 2)
- TOILET TISSUE DISPENSER (CH) STAINLESS STEEL COAT HOOK
- (\$N1) SANITARY NAPKIN DISPOSAL (TYPE 1: SURFACE MOUNTED) SN2 SANITARY NAPKIN DISPOSAL (TYPE 2: PARTITION MOUNTED DUAL ACCESS)
- MH) MOP HOLDER
- SH STAINLESS STEEL SHELF (COORDINATE MOUNTING HEIGHT & LOCATION IN FIELD, MIN 5'-0" AFF/ MAX 5'-6" A.F.F.)
- PS PADDED SEAT (MOUNTING HEIGHT 17"-19" AFF) SCR SHOWER CURTAIN AND ROD (COORDINATE MOUNTING HEIGHT WITH SHOWER CURTAIN LENGTH)


DRAWINGS FOR FIXTURE

INFORMATION


- HDI HAND DRYER
 - REFER TO PLUMBING

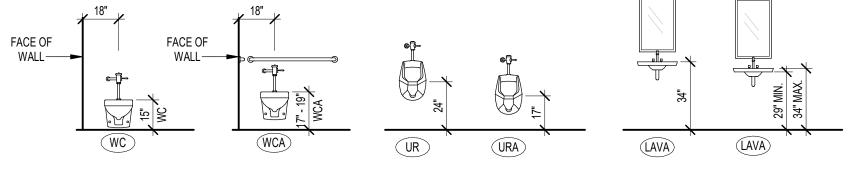


TYPICAL FIXTURE MOUNTING HEIGHTS

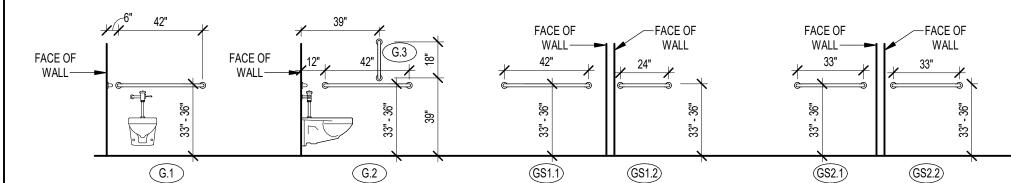

TYPICAL GRAB BAR MOUNTING HEIGHTS

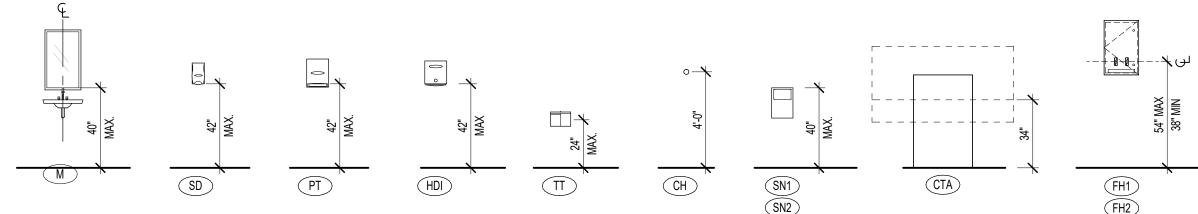


TYPICAL ACCESSORY MOUNTING HEIGHTS

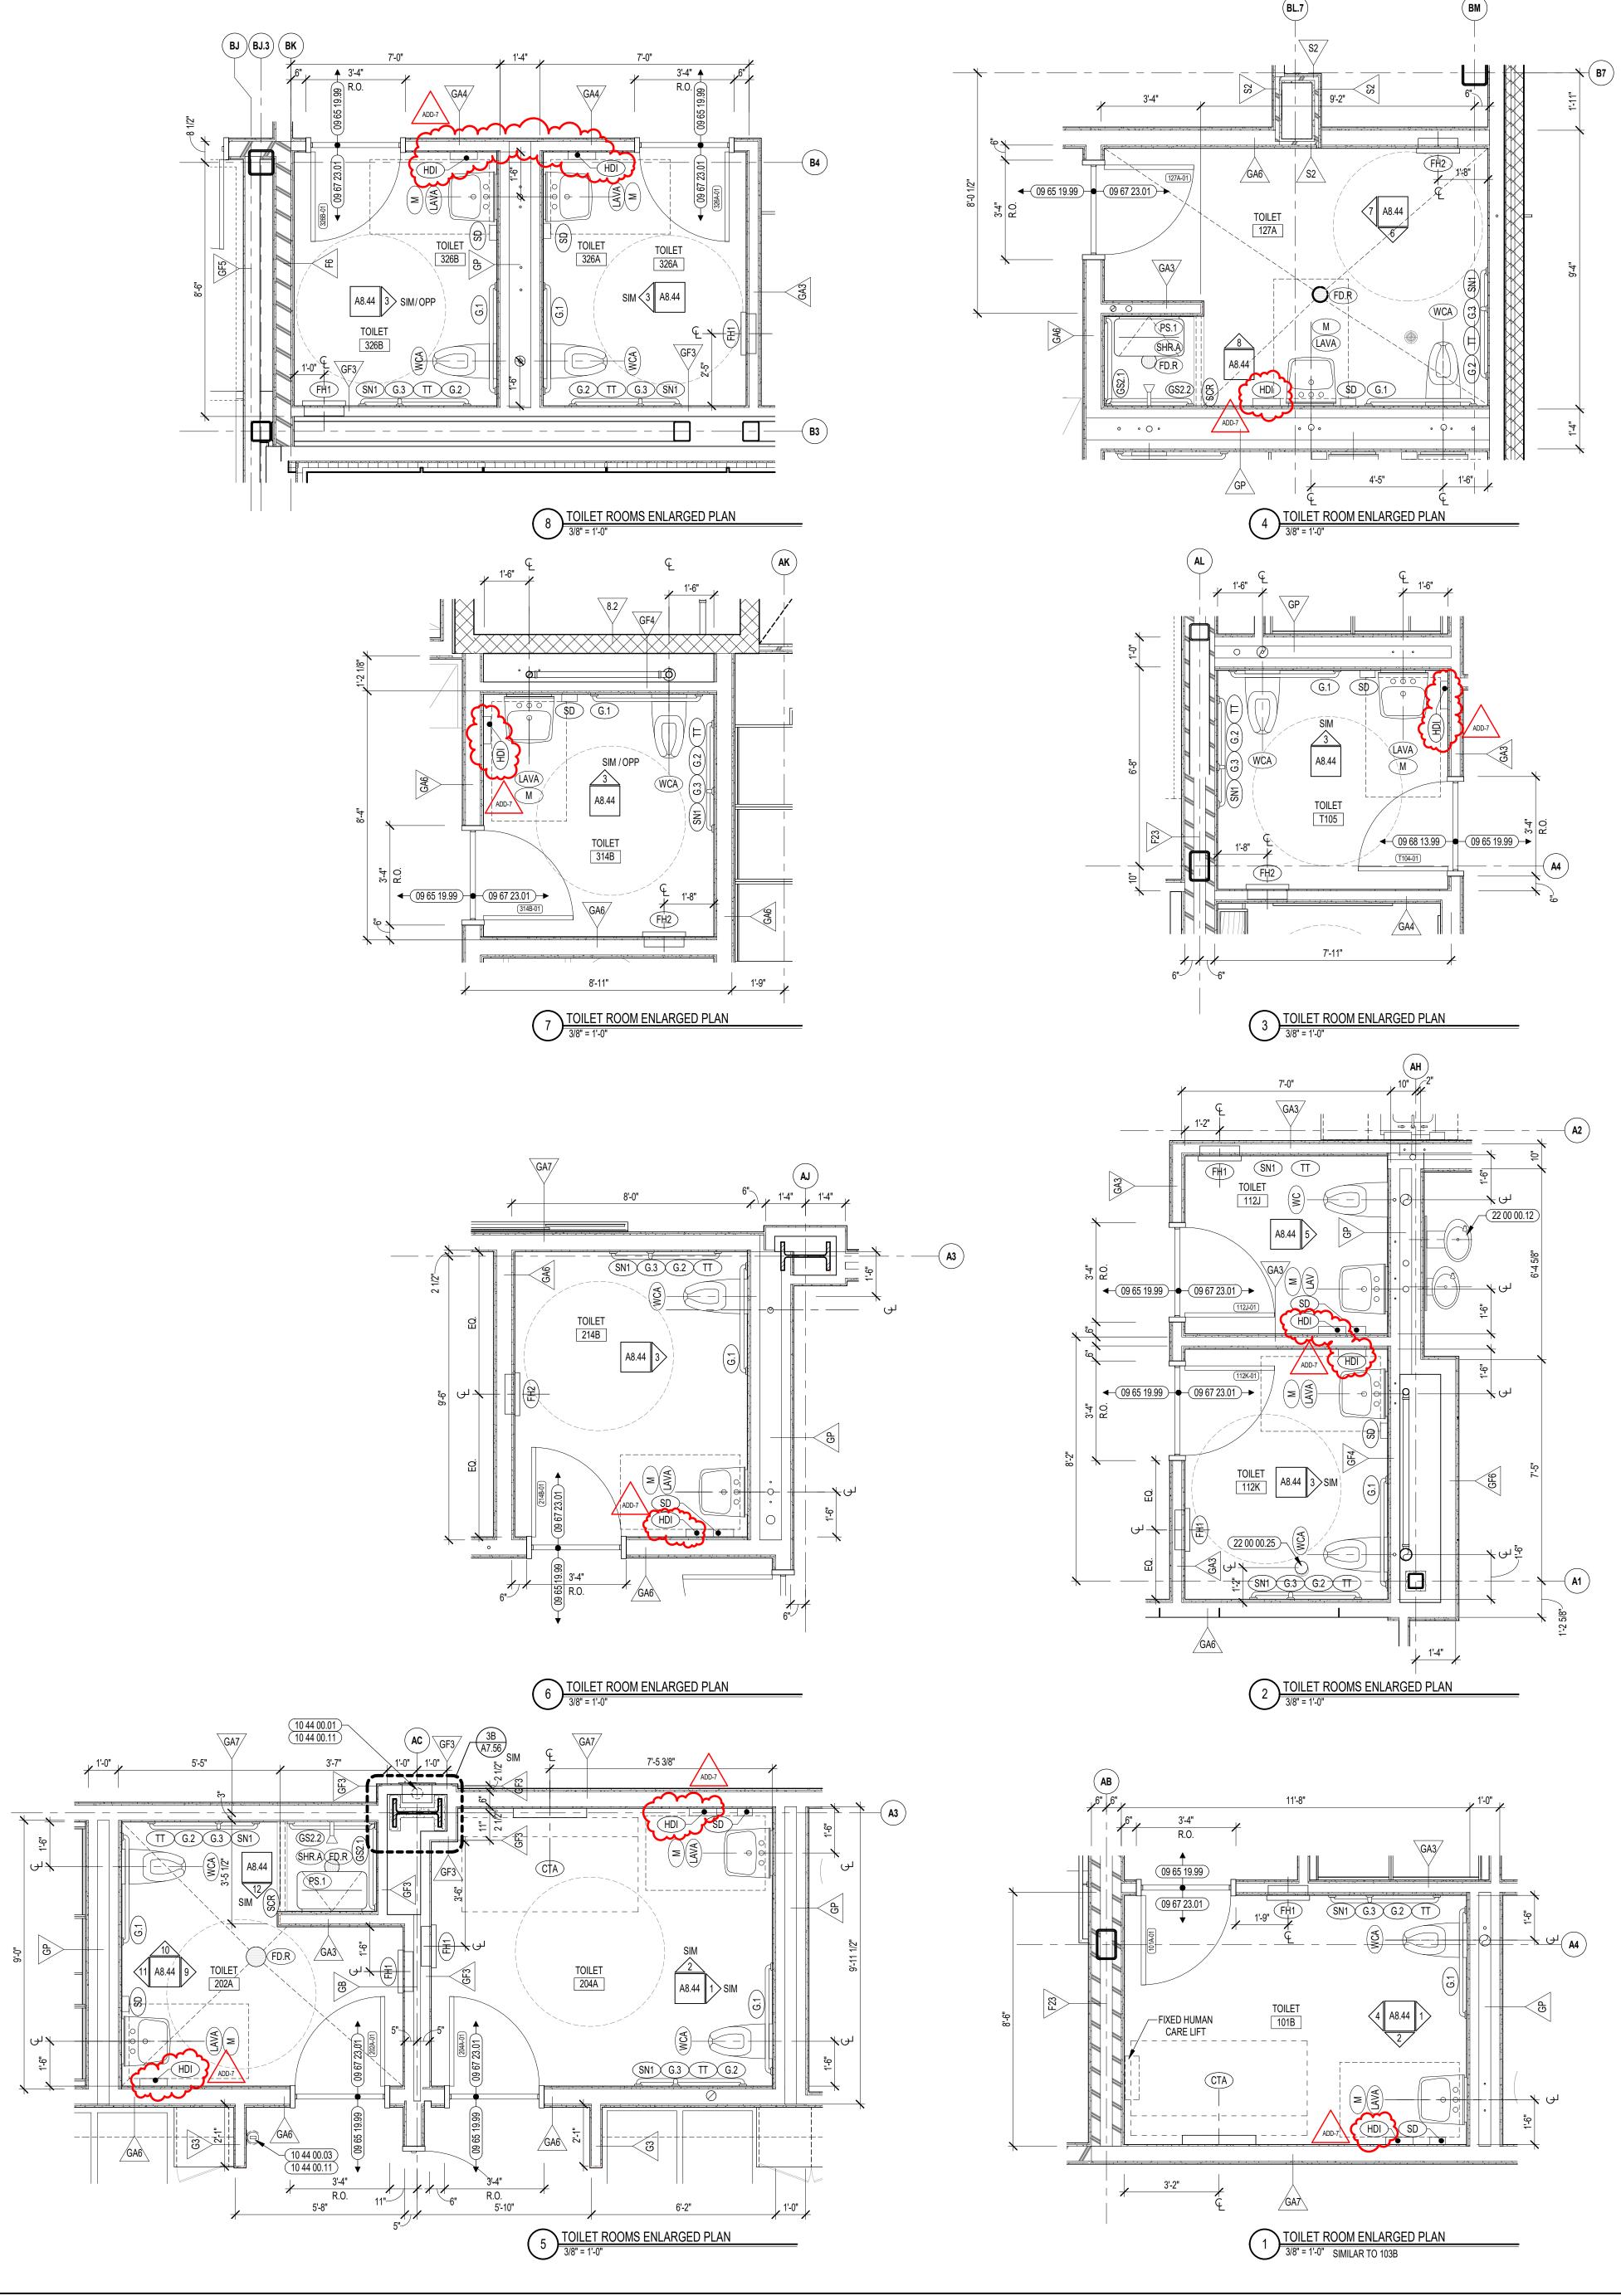



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KEYNOTE LEGEND:

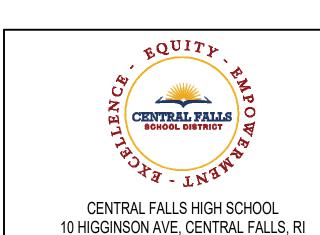09 65 19.99 RTF - REFERENCE SCHEDULE AND SAMPLE PATTERNS

09 67 23.01 FLUID APPLIED FLOORING - UCF-1 09 68 13.99 CPT - REFERENCE SCHEDULE AND SAMPLE PATTERNS

10 44 00.01 FIRE EXTINGUISHER CABINET - FULLY RECESSED 10 44 00.03 FIRE EXTINGUISHER WALL MOUNTED BRACKET

10 44 00.11 FIRE EXTINGUISHER


22 00 00.12 HYDRATION STATION - SEE PLUMBING 22 00 00.25 PIPE CLEANOUT FLOOR COVER - SEE PLUMBING

GENERAL NOTES:

 REFERENCE SAMPLE WALL CLADDING PATTERN DRAWINGS ON A7 SERIES FOR ADDITIONAL INFORMATION, TYPICAL. 2. NOT ALL POWER & DATA OUTLET/ SWITCHING LOCATIONS SHOWN, COORDINATE WITH ELECTRICAL AND TECHNOLOGY DRAWINGS FOR LOCATIONS.

ADDENDUM #7 01.26.2024 100% CONSTRUCTION DOCUMENTS KEY PLAN NORTH ARROW |


KEYPLAN

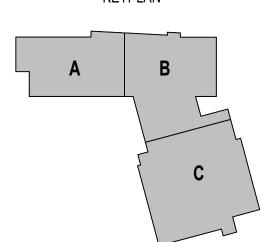


DRAWING NAME:

ENLARGED TOILET ROOM **PLANS**

DRAWN	BY:	CHR / NGA
REVIEWI	ED BY:	CHR / KK
SCALE:	AS INDICATED	DRAWING NUMBER:
JOB NO.:	2202.02 OCTOBER 13, 2023	A8.41

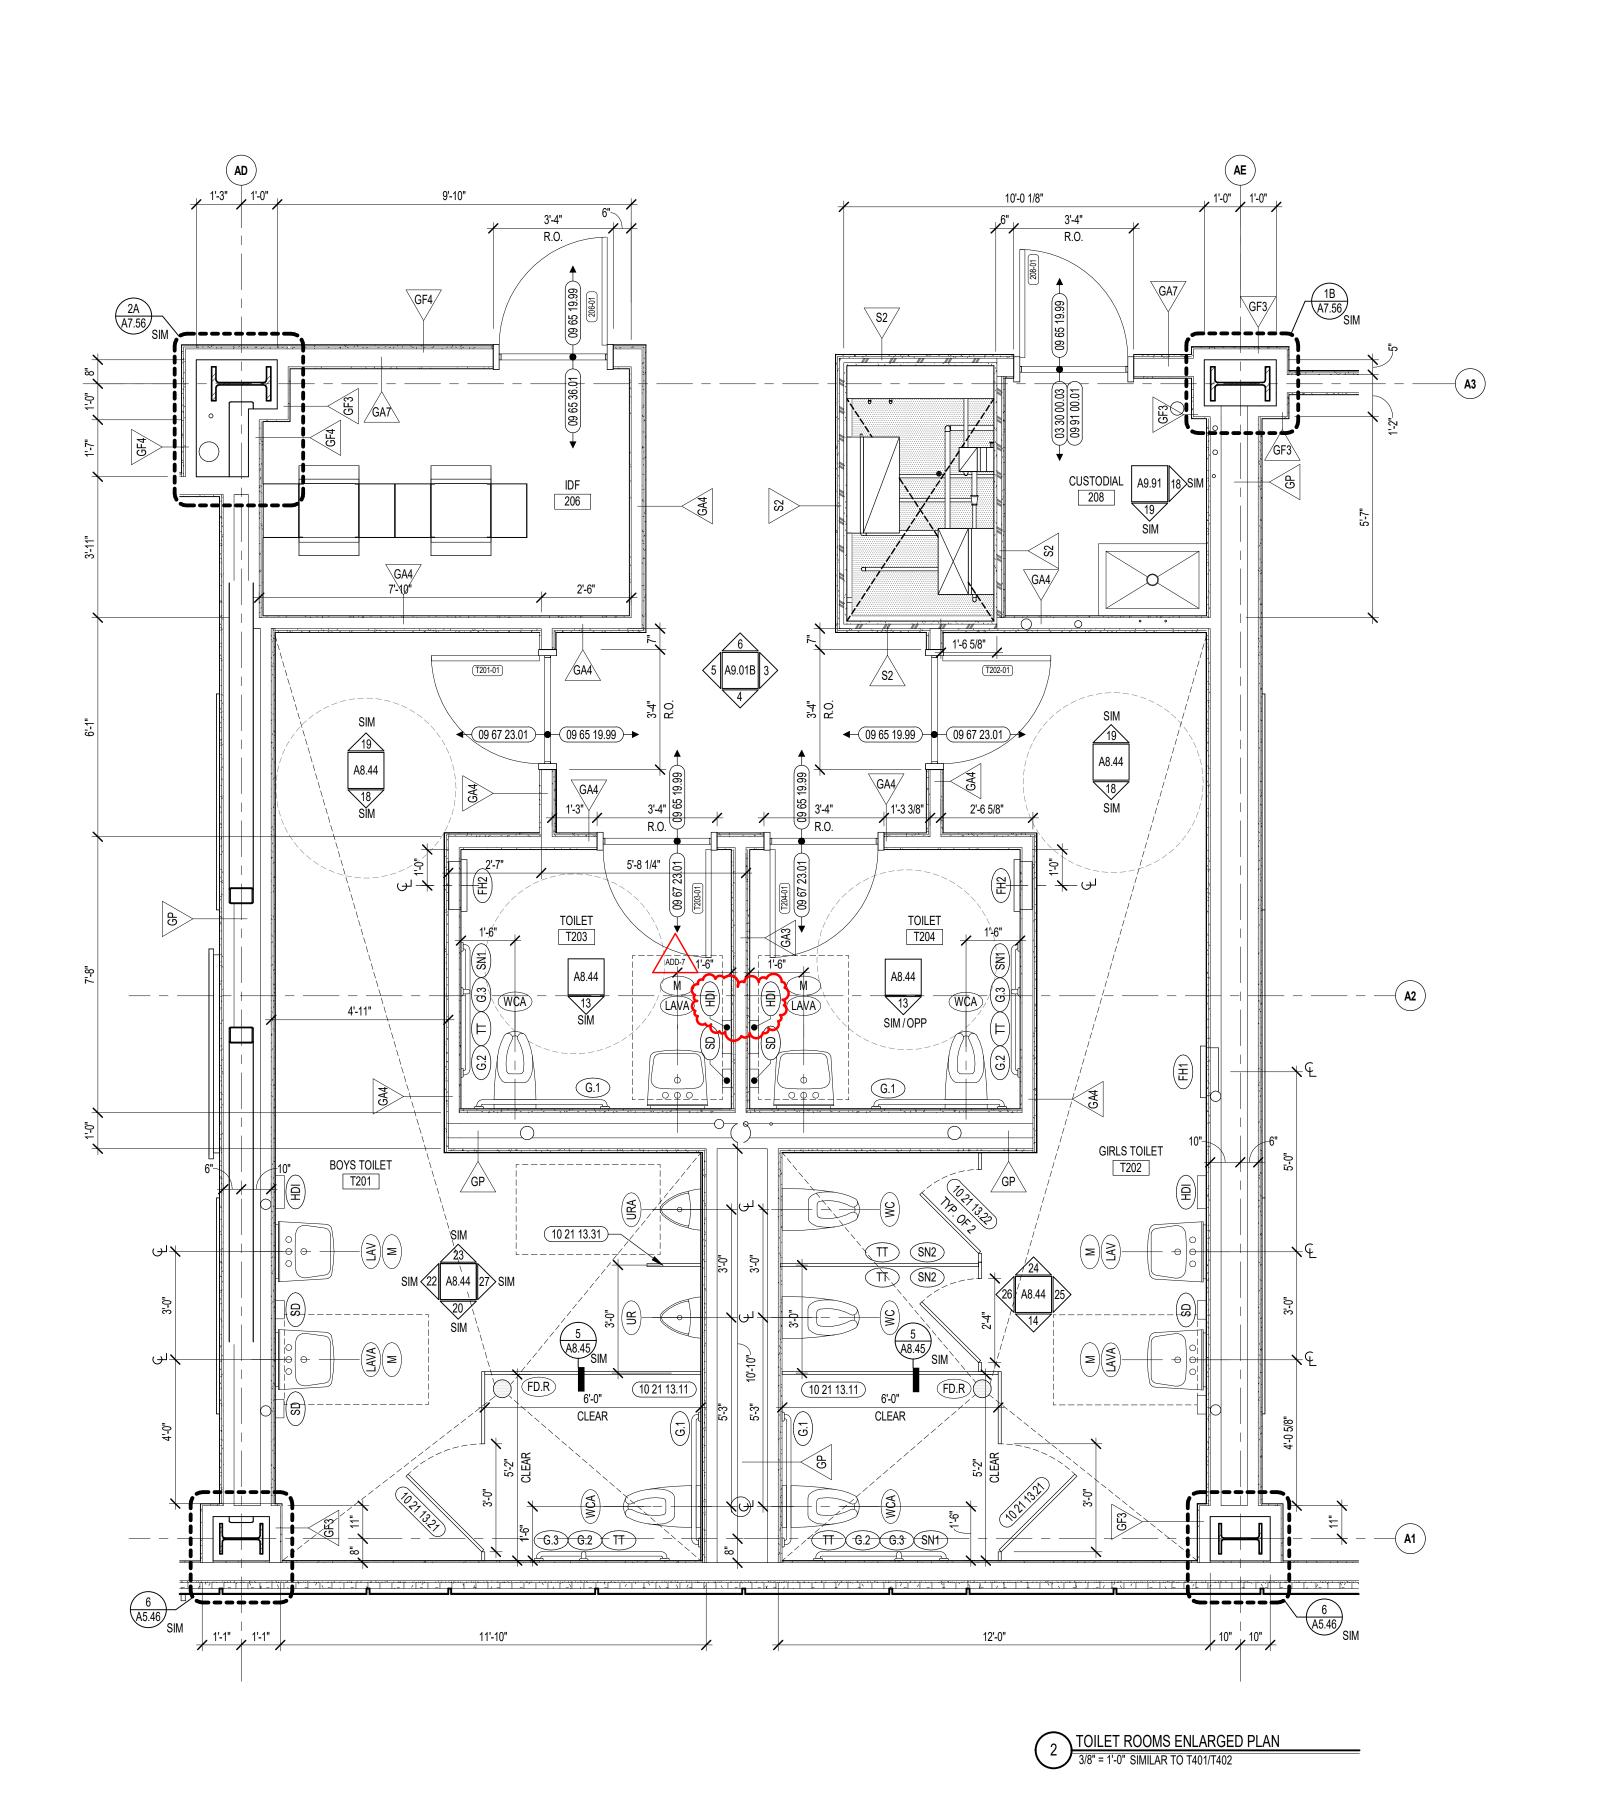

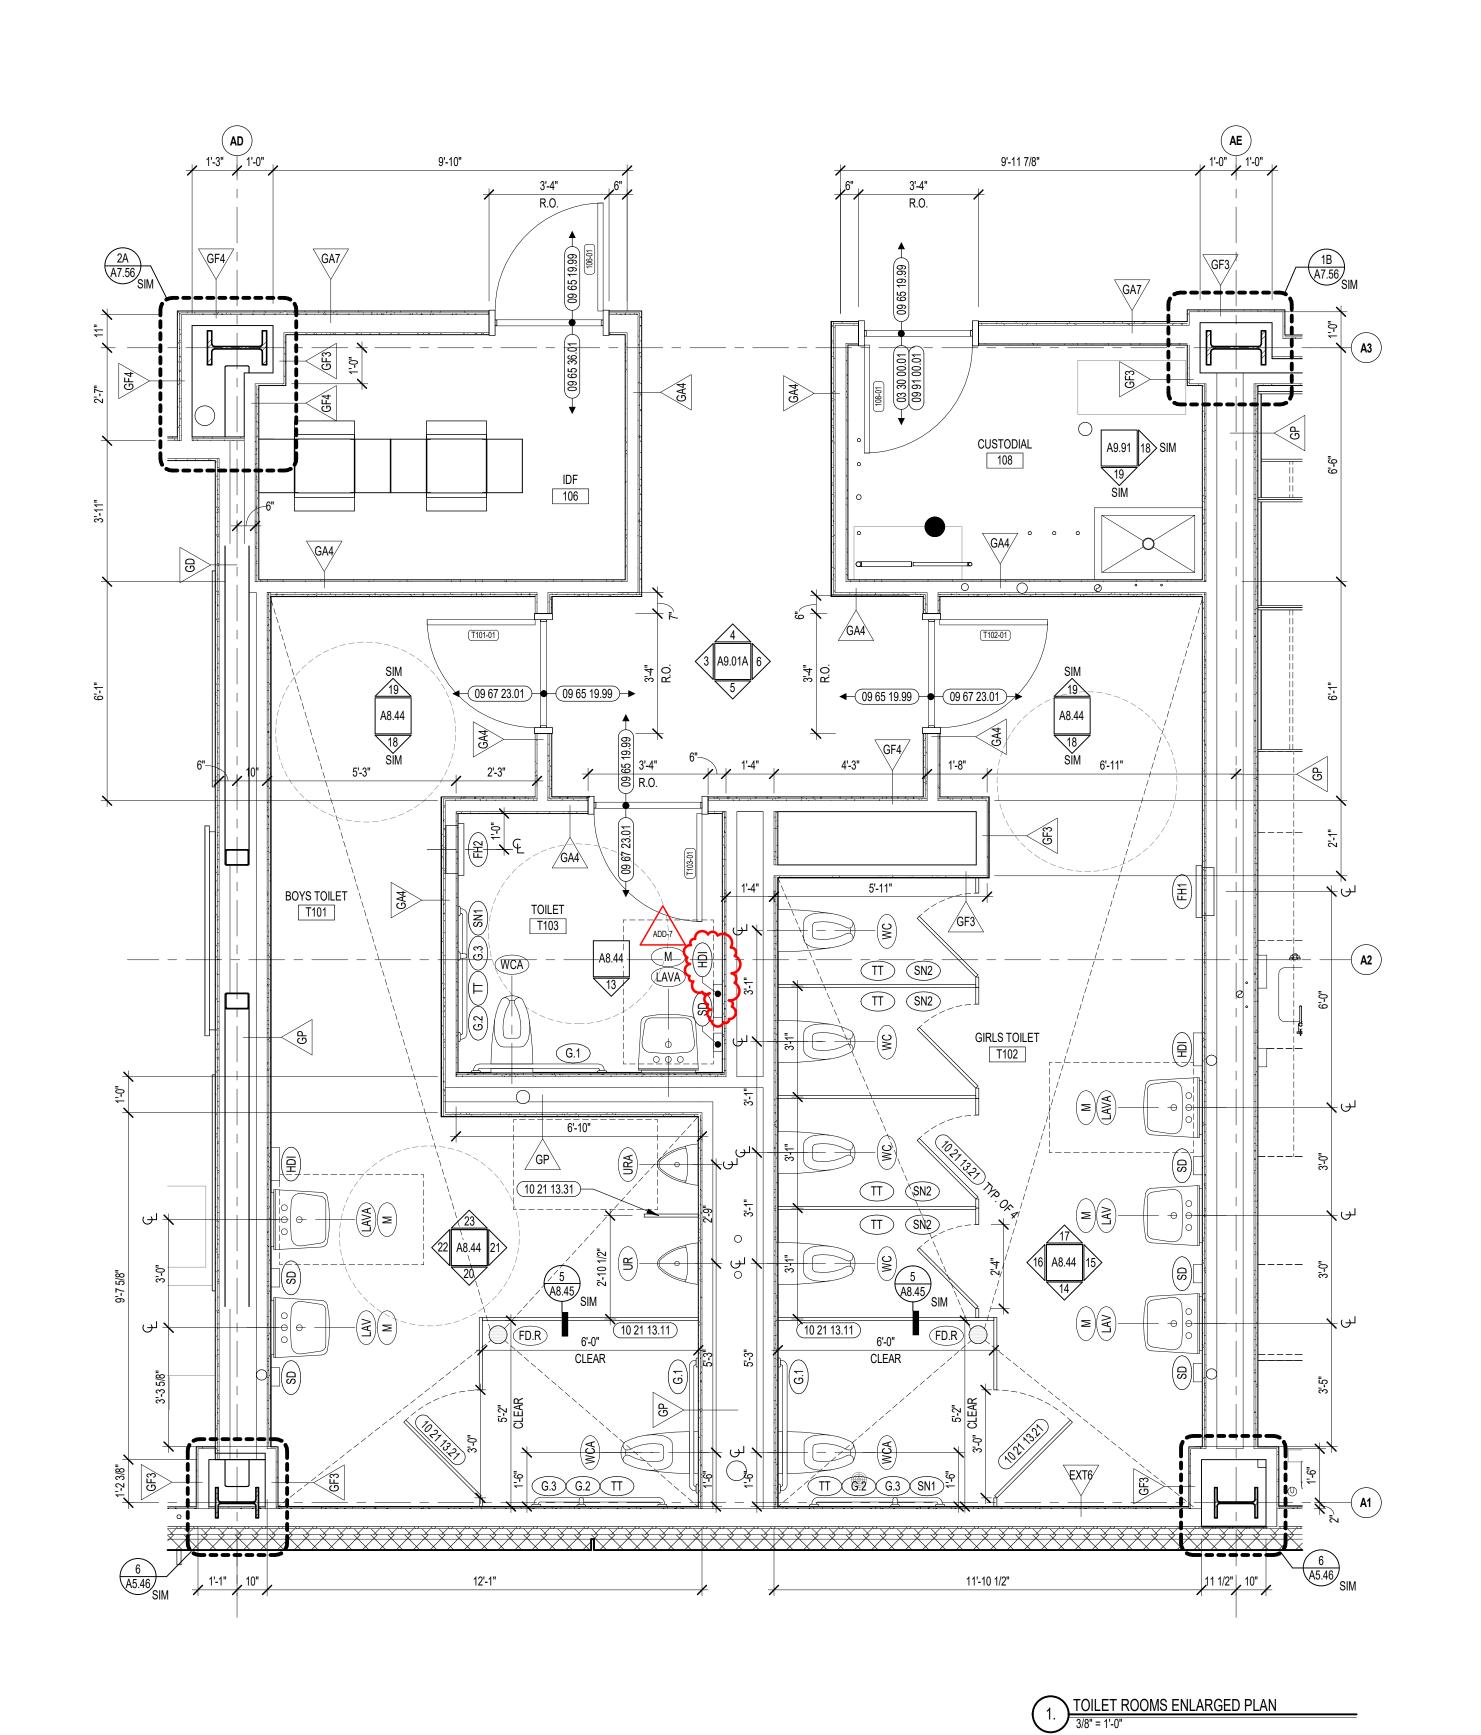



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KEYNOTE LEGEND:

FOR TYPE

03 30 00.01 CONCRETE

03 30 00.03 CONCRETE SLAB ON DECK - SEE STRUCTURAL 09 65 19.99 RTF - REFERENCE SCHEDULE AND SAMPLE PATTERNS

09 65 36.01 STATIC-CONTROL COMPOSITE TILE 09 67 23.01 FLUID APPLIED FLOORING - UCF-1

09 91 00.01 PAINT - SEE SCHEDULE 10 21 13.11 TOILET PARTITION - PANEL


10 21 13.21 TOILET COMPARTMENT DOOR - 36 INCH 10 21 13.22 TOILET COMPARTMENT DOOR - 28 INCH


10 21 13.31 URINAL SCREEN

GENERAL NOTES: REFERENCE SAMPLE WALL CLADDING PATTERN DRAWINGS ON A7 SERIES FOR ADDITIONAL INFORMATION, TYPICAL.

NOT ALL POWER & DATA OUTLET/ SWITCHING LOCATIONS SHOWN, COORDINATE WITH ELECTRICAL AND TECHNOLOGY DRAWINGS FOR LOCATIONS.

ADD-7 ADDENDUM #7 01.26.2024 100% CONSTRUCTION DOCUMENTS KEY PLAN NORTH ARROW

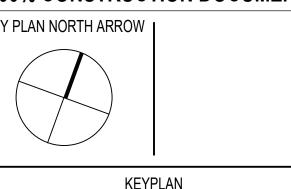


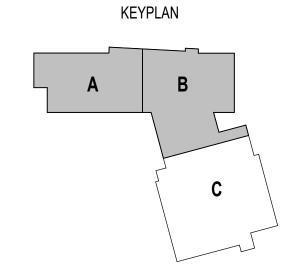

DRAWING NAME:


ENLARGED TOILET ROOM **PLANS**

	DRAWN	BY:	CHR / NGA
	REVIEW	ED BY:	CHR / KK
	SCALE:	AS INDICATED	DRAWING NUMBER:
	JOB NO.	.: 2202.02	A8.42
	DATE:	OCTOBER 13, 2023	/\U. +∠

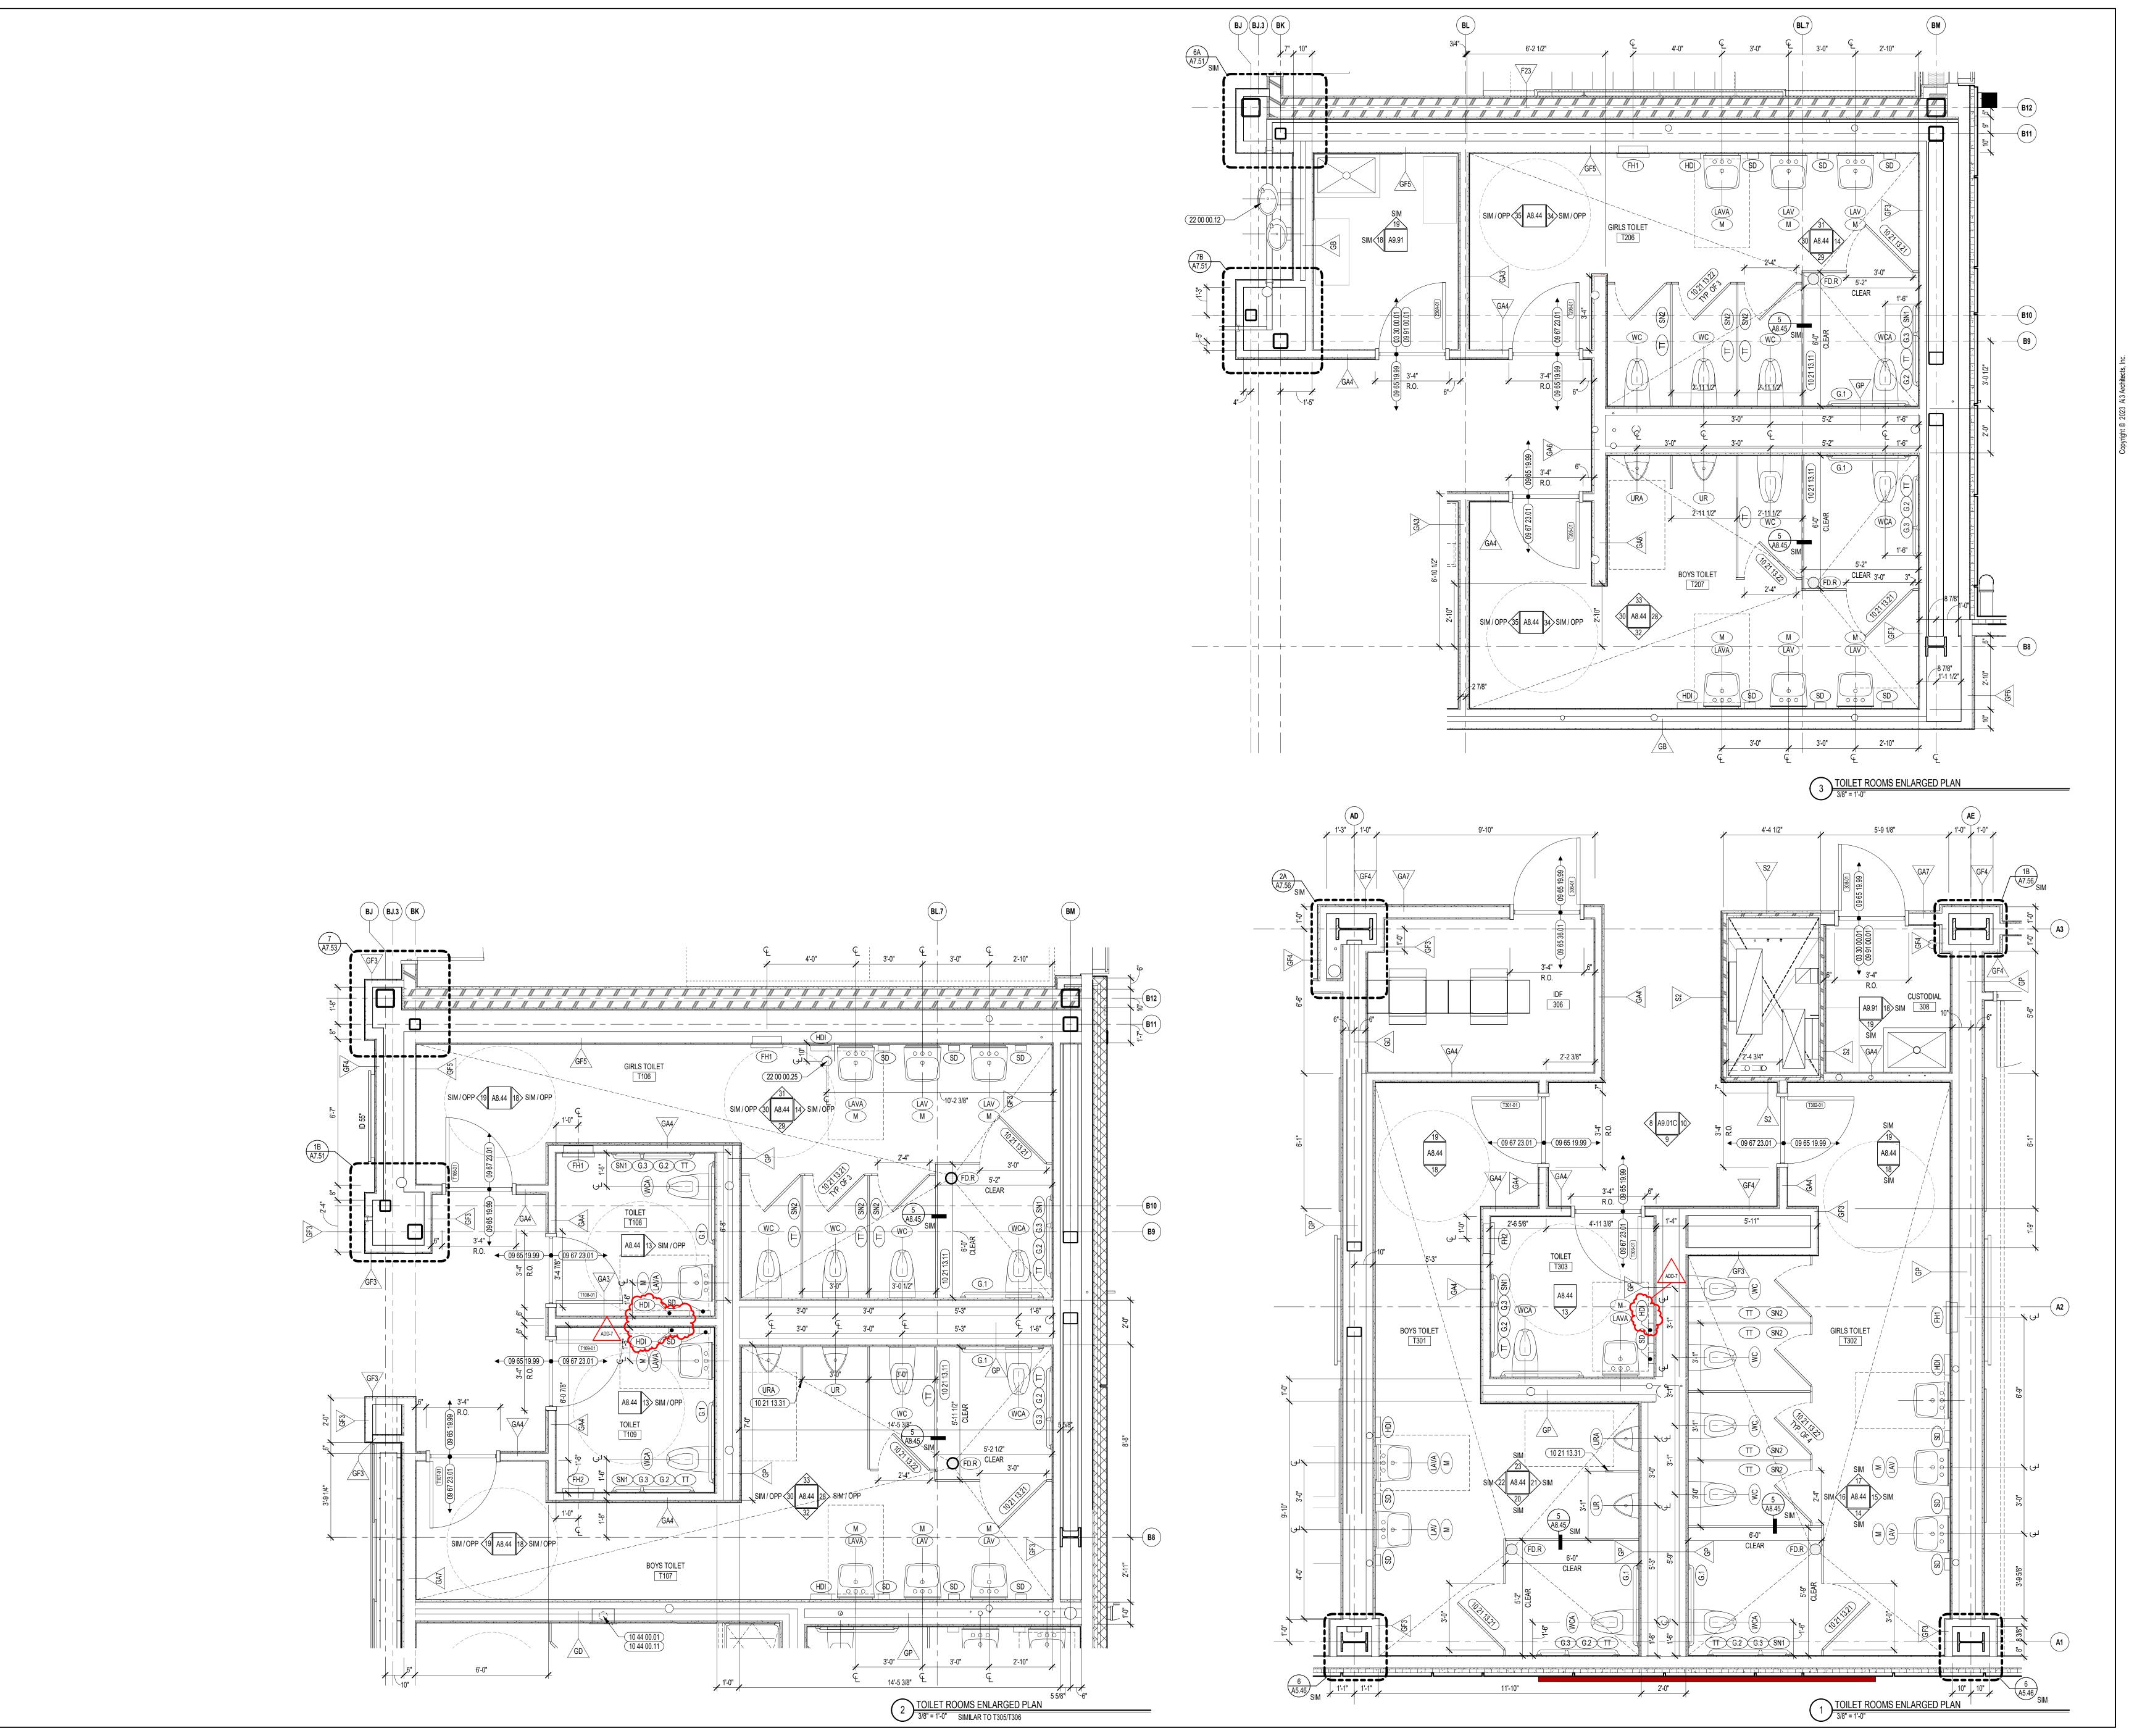



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KEYNOTE LEGEND:

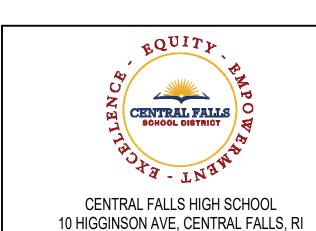03 30 00.01 CONCRETE
09 65 19.99 RTF - REFERENCE SCHEDULE AND SAMPLE PATTERNS

FOR TYPE

09 65 36.01 STATIC-CONTROL COMPOSITE TILE

09 67 23.01 FLUID APPLIED FLOORING - UCF-1

09 91 00.01 PAINT - SEE SCHEDULE
10 21 13.11 TOILET PARTITION - PANEL
10 21 13.21 TOILET COMPARTMENT DOOR - 36 INCH

10 21 13.22 TOILET COMPARTMENT DOOR - 28 INCH 10 21 13.31 URINAL SCREEN

10 44 00.01 FIRE EXTINGUISHER CABINET - FULLY RECESSED 10 44 00.11 FIRE EXTINGUISHER

10 44 00.11 FIRE EXTINGUISHER
22 00 00.12 HYDRATION STATION - SEE PLUMBING

22 00 00.25 PIPE CLEANOUT FLOOR COVER - SEE PLUMBING


GENERAL NOTES:


1. REFERENCE SAMPLE WALL CLADDING PATTERN DRAWINGS ON A7 SERIES FOR ADDITIONAL INFORMATION, TYPICAL.

2. NOT ALL POWER & DATA OUTLET/ SWITCHING LOCATIONS SHOWN, COORDINATE WITH ELECTRICAL AND TECHNOLOGY DRAWINGS FOR LOCATIONS.

ADD-7 ADDENDUM #7 01.26.2024

100% CONSTRUCTION DOCUMENTS

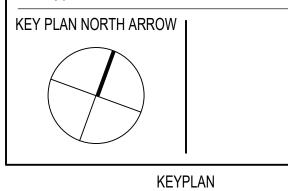


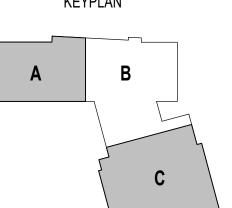


DRAWING NAME:

ENLARGED TOILET ROOM PLANS

DRAWN E	BY:	CHR / NGA
REVIEWE	D BY:	CHR / KK
SCALE:	AS INDICATED	DRAWING NUMBER:
JOB NO.:	2202.02	A8.43
DATE:	OCTOBER 13, 2023	/ 10.70

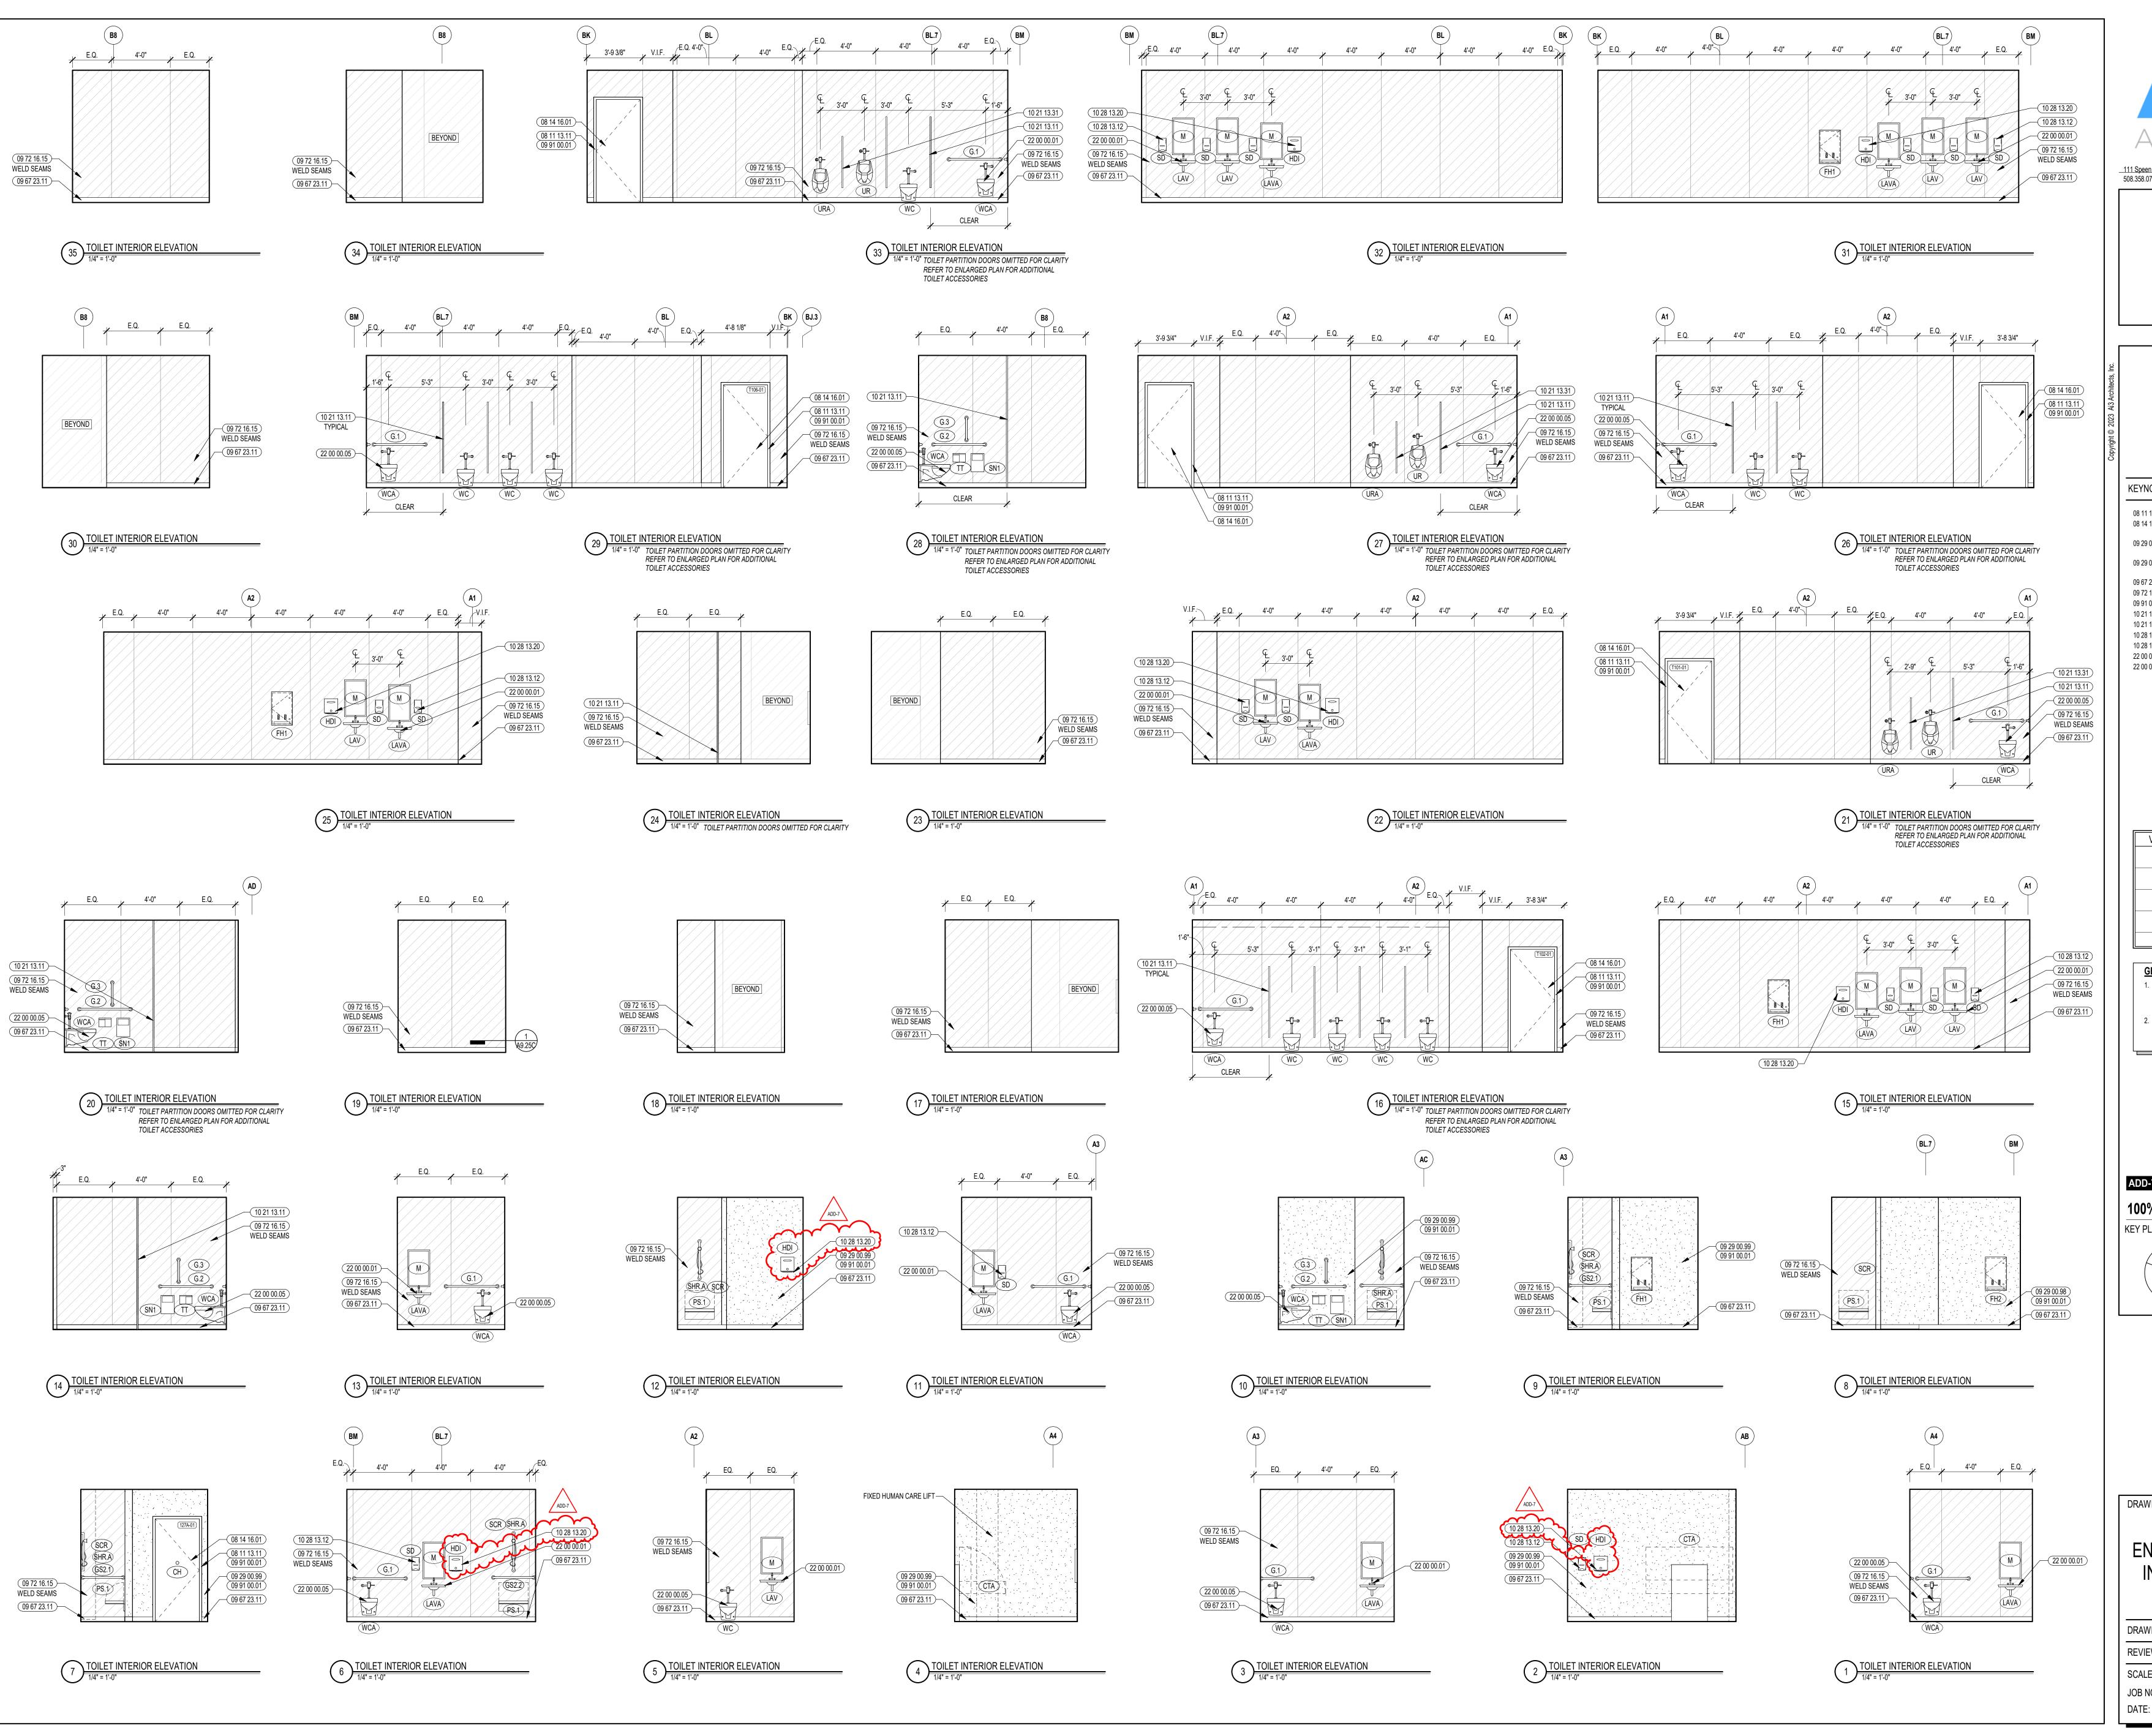



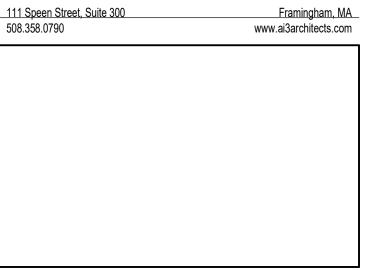



KEYNOTE LEGEND:

08 11 13.11 STEEL FRAME - SEE SCHEDULE FOR TYPES 08 14 16.01 SOLID CORE FLUSH WOOD DOOR- SEE DOOR

SCHEDULE 09 29 00.98 GYPSUM BOARD SYSTEM - LEVEL 5 FINISH - REFER TO FLOOR PLANS AND WALL TYPES FOR COMPONENTS


09 29 00.99 GYPSUM BOARD SYSTEM - LEVEL 4 FINISH - REFER TO FLOOR PLANS AND WALL TYPES FOR COMPONENTS 09 67 23.11 FLUID APPLIED FLOORING - INTEGRATED COVE BASE

09 72 16.15 VINYL WALL CLADDING - TYPE 5 09 91 00.01 PAINT - SEE SCHEDULE 10 21 13.11 TOILET PARTITION - PANEL

10 21 13.31 URINAL SCREEN

10 28 13.12 SOAP DISPENSER 10 28 13.20 ELECTRIC HAND DRYER


22 00 00.01 SINK - SEE PLUMBING 22 00 00.05 WATER CLOSET - SEE PLUMBING

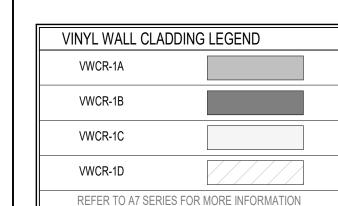


GENERAL NOTES: REFERENCE SAMPLE WALL CLADDING PATTERN DRAWINGS ON A7 SERIES FOR ADDITIONAL INFORMATION, TYPICAL.

2. NOT ALL POWER & DATA OUTLET/ SWITCHING LOCATIONS SHOWN, COORDINATE WITH ELECTRICAL AND TECHNOLOGY DRAWINGS FOR LOCATIONS.


ADDENDUM #7 01.26.2024 **100% CONSTRUCTION DOCUMENTS** KEY PLAN NORTH ARROW |

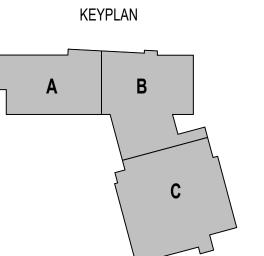

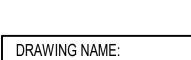


ENLARGED TOILET ROOM INTERIOR ELEVATIONS

	DRAWN	BY:	CHR / NGA
	REVIEW	ED BY:	CHR / KK
	SCALE:	AS INDICATED	DRAWING NUMBER:
	JOB NO.	: 2202.02	A8.44
	DATE:	OCTOBER 13, 2023	/ \ O.¬¬

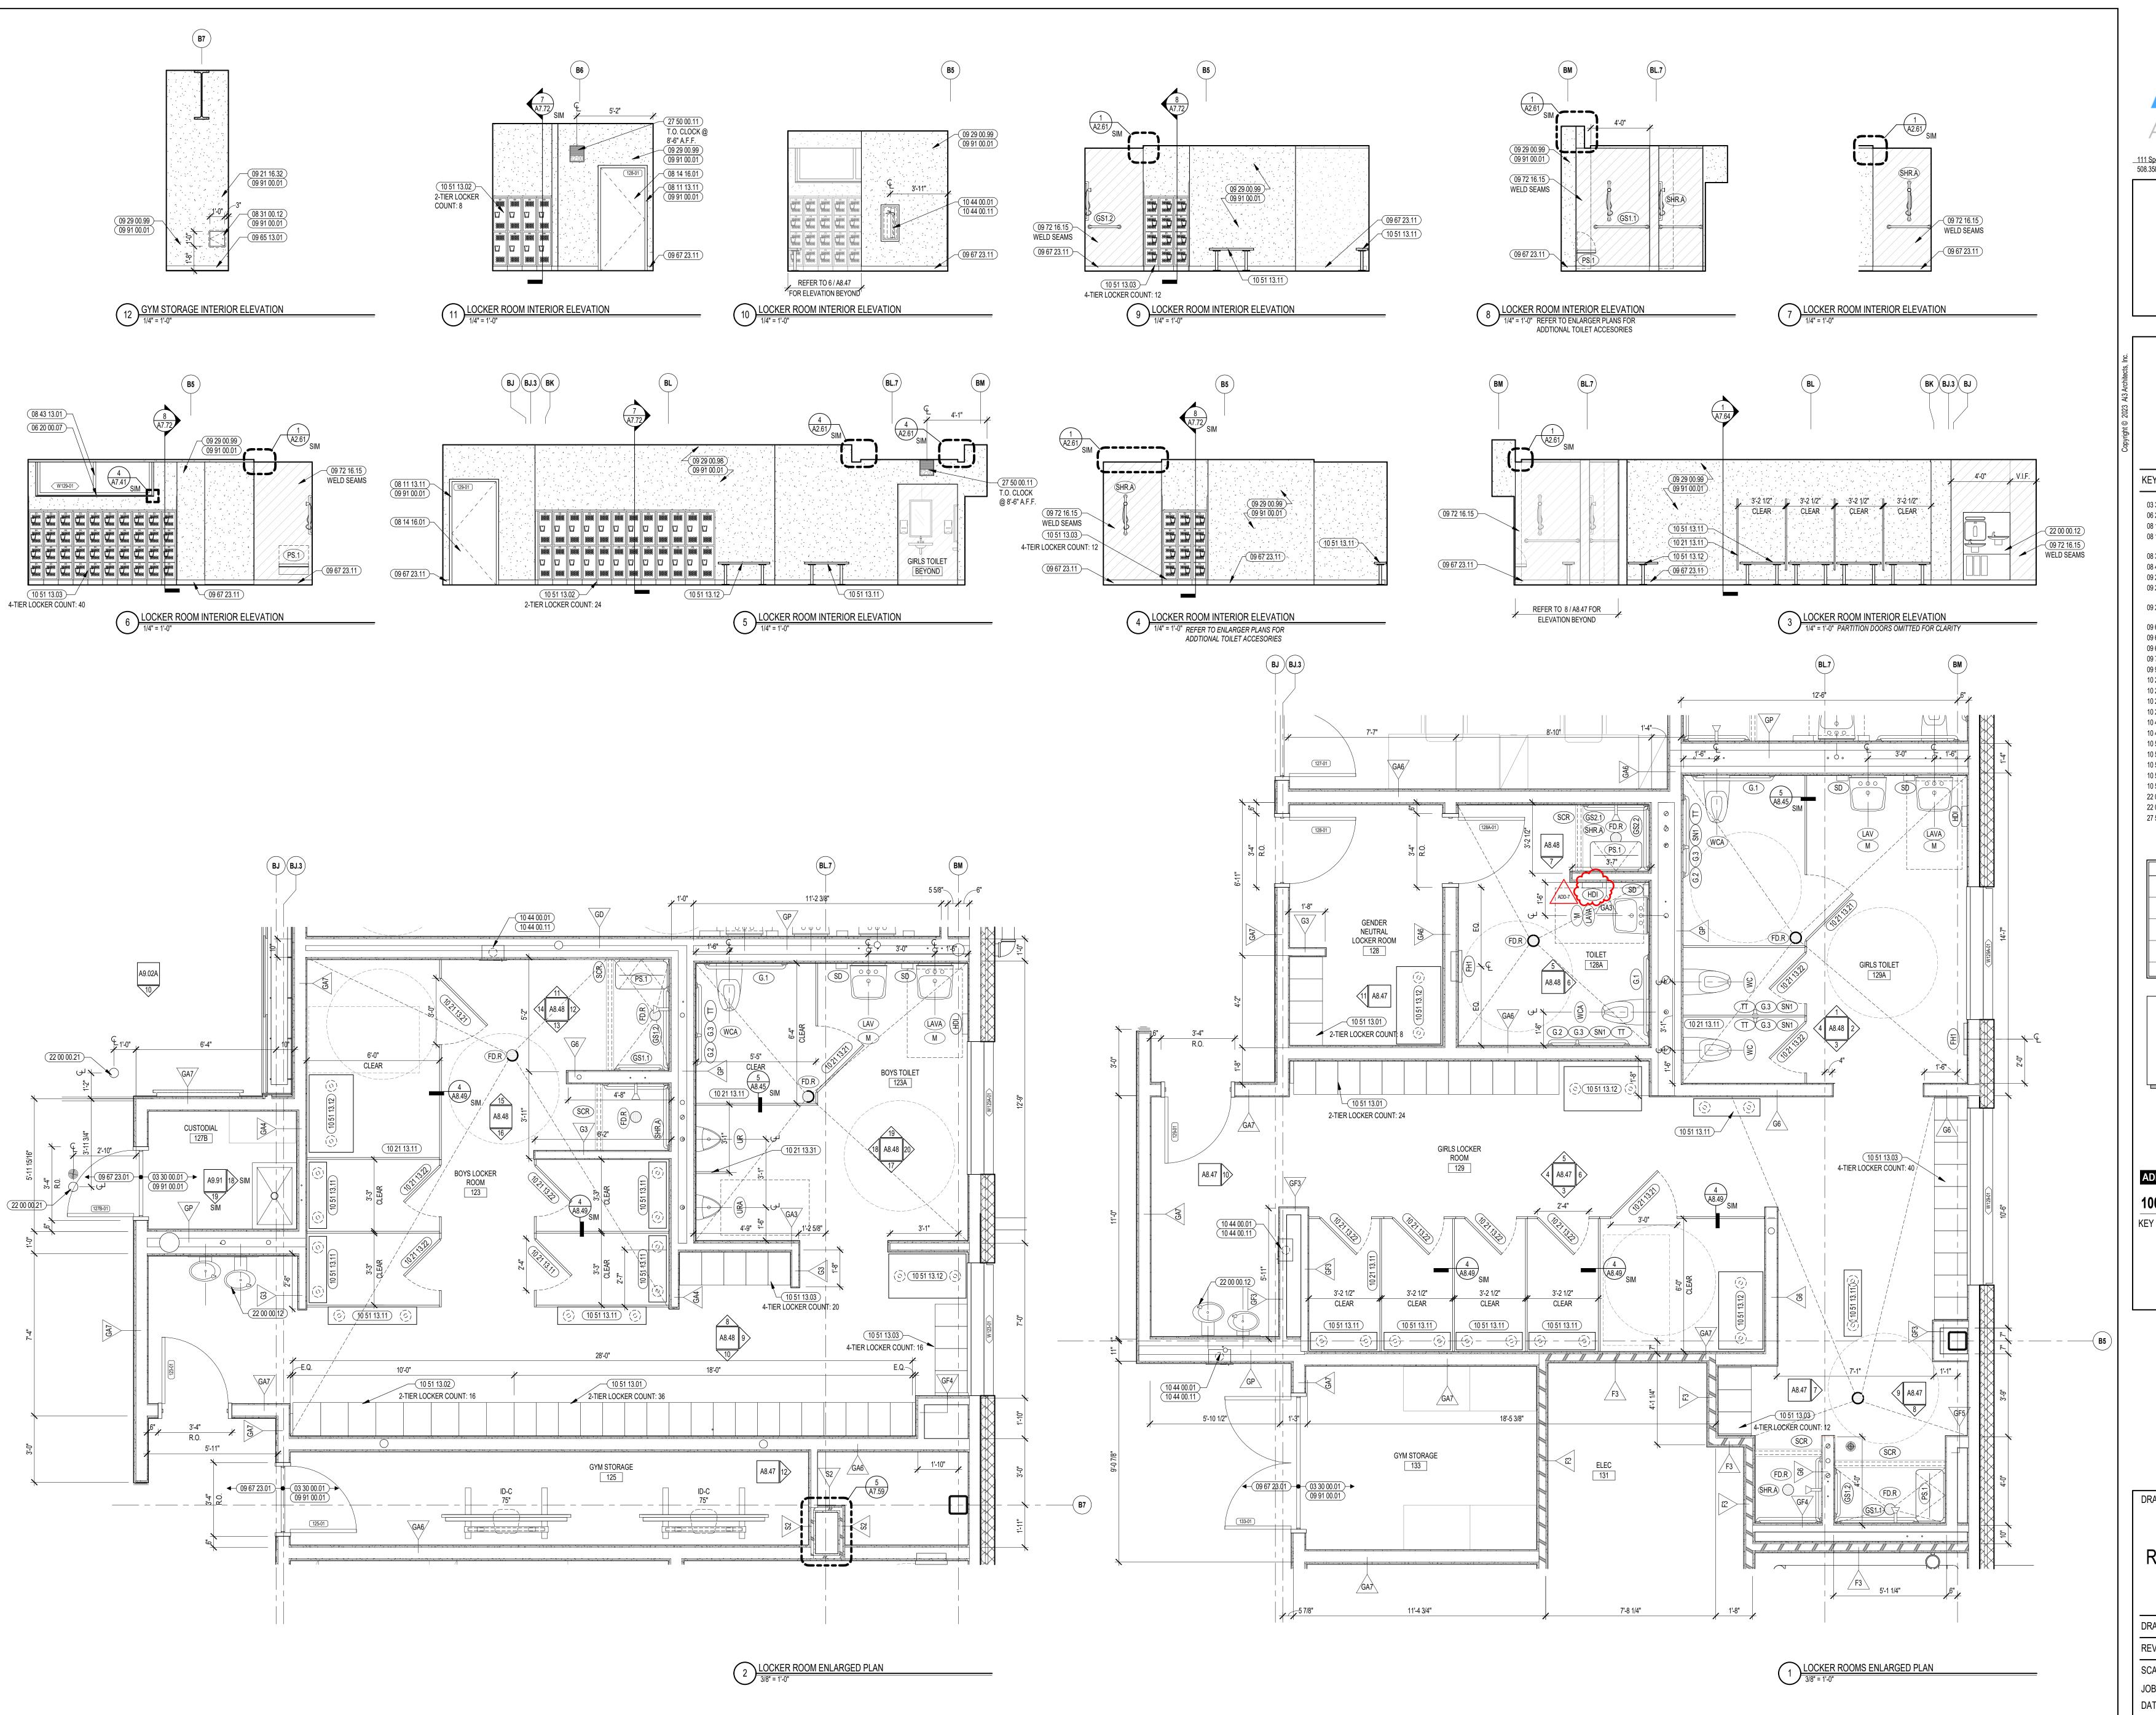



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KEYNOTE LEGEND:

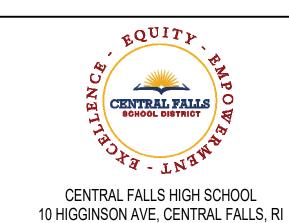- 03 30 00.01 CONCRETE
- 06 20 00.07 HARDWOOD SILL TRANSPARENT FINISH
 08 11 13.11 STEEL FRAME SEE SCHEDULE FOR TYPES
 08 14 16.01 SOLID CORE FLUSH WOOD DOOR- SEE DOOR
- SCHEDULE

 08 31 00.12 ACCESS PANEL FIRE RATED

 08 43 13.01 ALUMINUM STOREFRONT FRAME
- 09 21 16.32 GYPSUM BOARD 5/8 INCH TYPE X 2 LAYERS
- 09 29 00.98 GYPSUM BOARD SYSTEM LEVEL 5 FINISH REFER TO FLOOR PLANS AND WALL TYPES FOR COMPONENTS
- 09 29 00.99 GYPSUM BOARD SYSTEM LEVEL 4 FINISH REFER TO FLOOR PLANS AND WALL TYPES FOR COMPONENTS
- 09 65 13.01 RUBBER BASE 4 INCH 09 67 23.01 FLUID APPLIED FLOORING - UCF-1
- 09 67 23.11 FLUID APPLIED FLOORING INTEGRATED COVE BASE
- 09 72 16.15 VINYL WALL CLADDING TYPE 5
- 09 91 00.01 PAINT SEE SCHEDULE
- 10 21 13.11 TOILET PARTITION PANEL
- 10 21 13.21 TOILET COMPARTMENT DOOR 36 INCH
- 10 21 13.22 TOILET COMPARTMENT DOOR 28 INCH 10 21 13.31 URINAL SCREEN
- 10 44 00.01 FIRE EXTINGUISHER CABINET FULLY RECESSED
- 10 44 00.11 FIRE EXTINGUISHER
- 10 51 13.01 METAL LOCKER SLOPED TOP TYPE 1
- 10 51 13.02 METAL LOCKER SLOPED TOP TYPE 2
- 10 51 13.03 METAL LOCKER SLOPED TOP TYPE 3 10 51 13.11 LOCKER ROOM BENCH
- 10 51 13.11 LOCKER ROOM BENCH 10 51 13.12 LOCKER ROOM BENCH - ADA
- 22 00 00.12 HYDRATION STATION SEE PLUMBING

VWCR-1D

22 00 00.21 FLOOR DRAIN - SEE PLUMBING 27 50 00.11 CLOCK - SEE TECHNOLOGY

	VINYL WALL CLADI	DING LEGEND
	VWCR-1A	
	VWCR-1B	
	VWCR-1C	
- I⊢		

REFER TO A7 SERIES FOR MORE INFORMATION

GENERAL NOTES:

1. REFERENCE SAMPLE WALL CLADDING PATTER


REFERENCE SAMPLE WALL CLADDING PATTERN DRAWINGS ON A7 SERIES FOR ADDITIONAL INFORMATION, TYPICAL.


2. NOT ALL POWER & DATA OUTLET/ SWITCHING LOCATIONS SHOWN, COORDINATE WITH ELECTRICAL AND TECHNOLOGY DRAWINGS FOR LOCATIONS.

ADD-7 ADDENDUM #7 01.26.2024

100% CONSTRUCTION DOCUMENTS

KEY DI ANI NORTH APPONI I

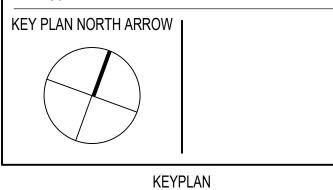


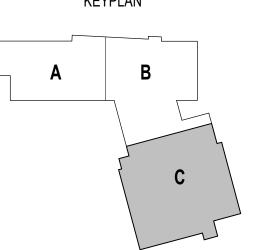



DRAWING NAME:

ENLARGED LOCKER ROOM PLANS & INTERIOR ELEVATIONS

	DRAWN	BY:	CHR / BFC
	REVIEW	ED BY:	CHR / KK
	SCALE:	AS INDICATED	DRAWING NUMBER:
	JOB NO	.: 2202.02	A8.47
	DATE:	OCTOBER 13, 2023	$\Lambda \cup \Lambda \cap \Lambda$

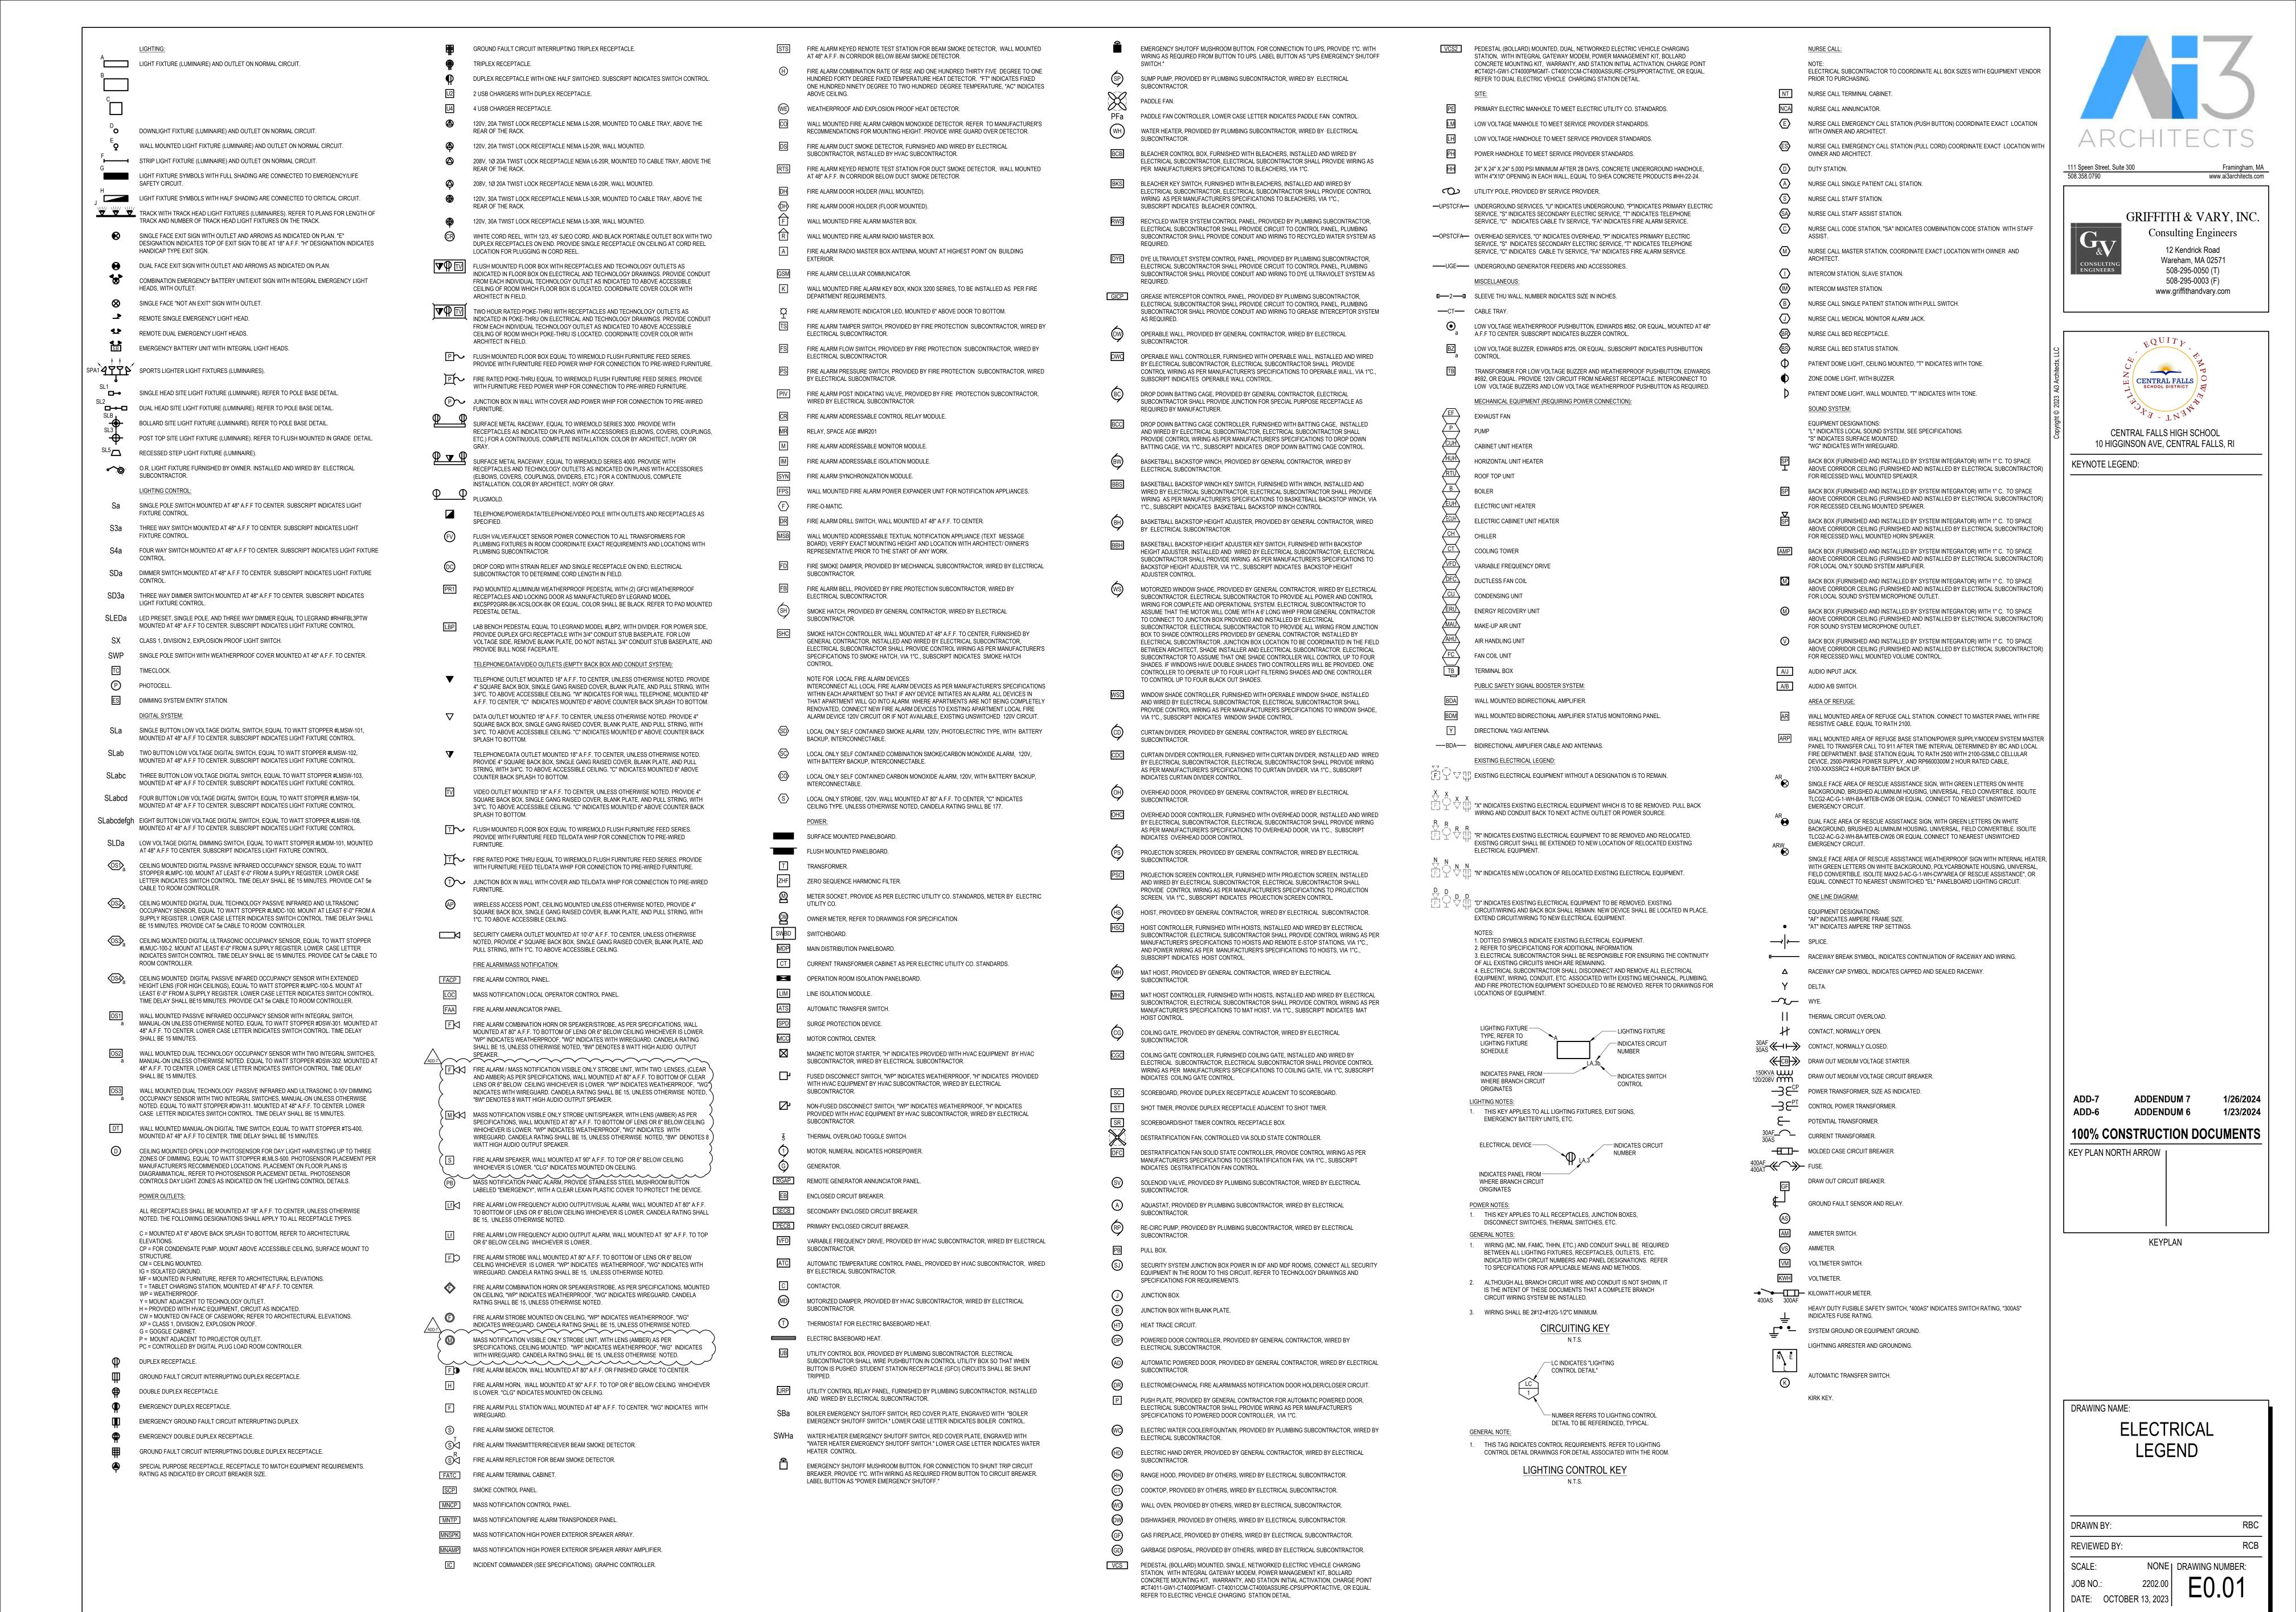

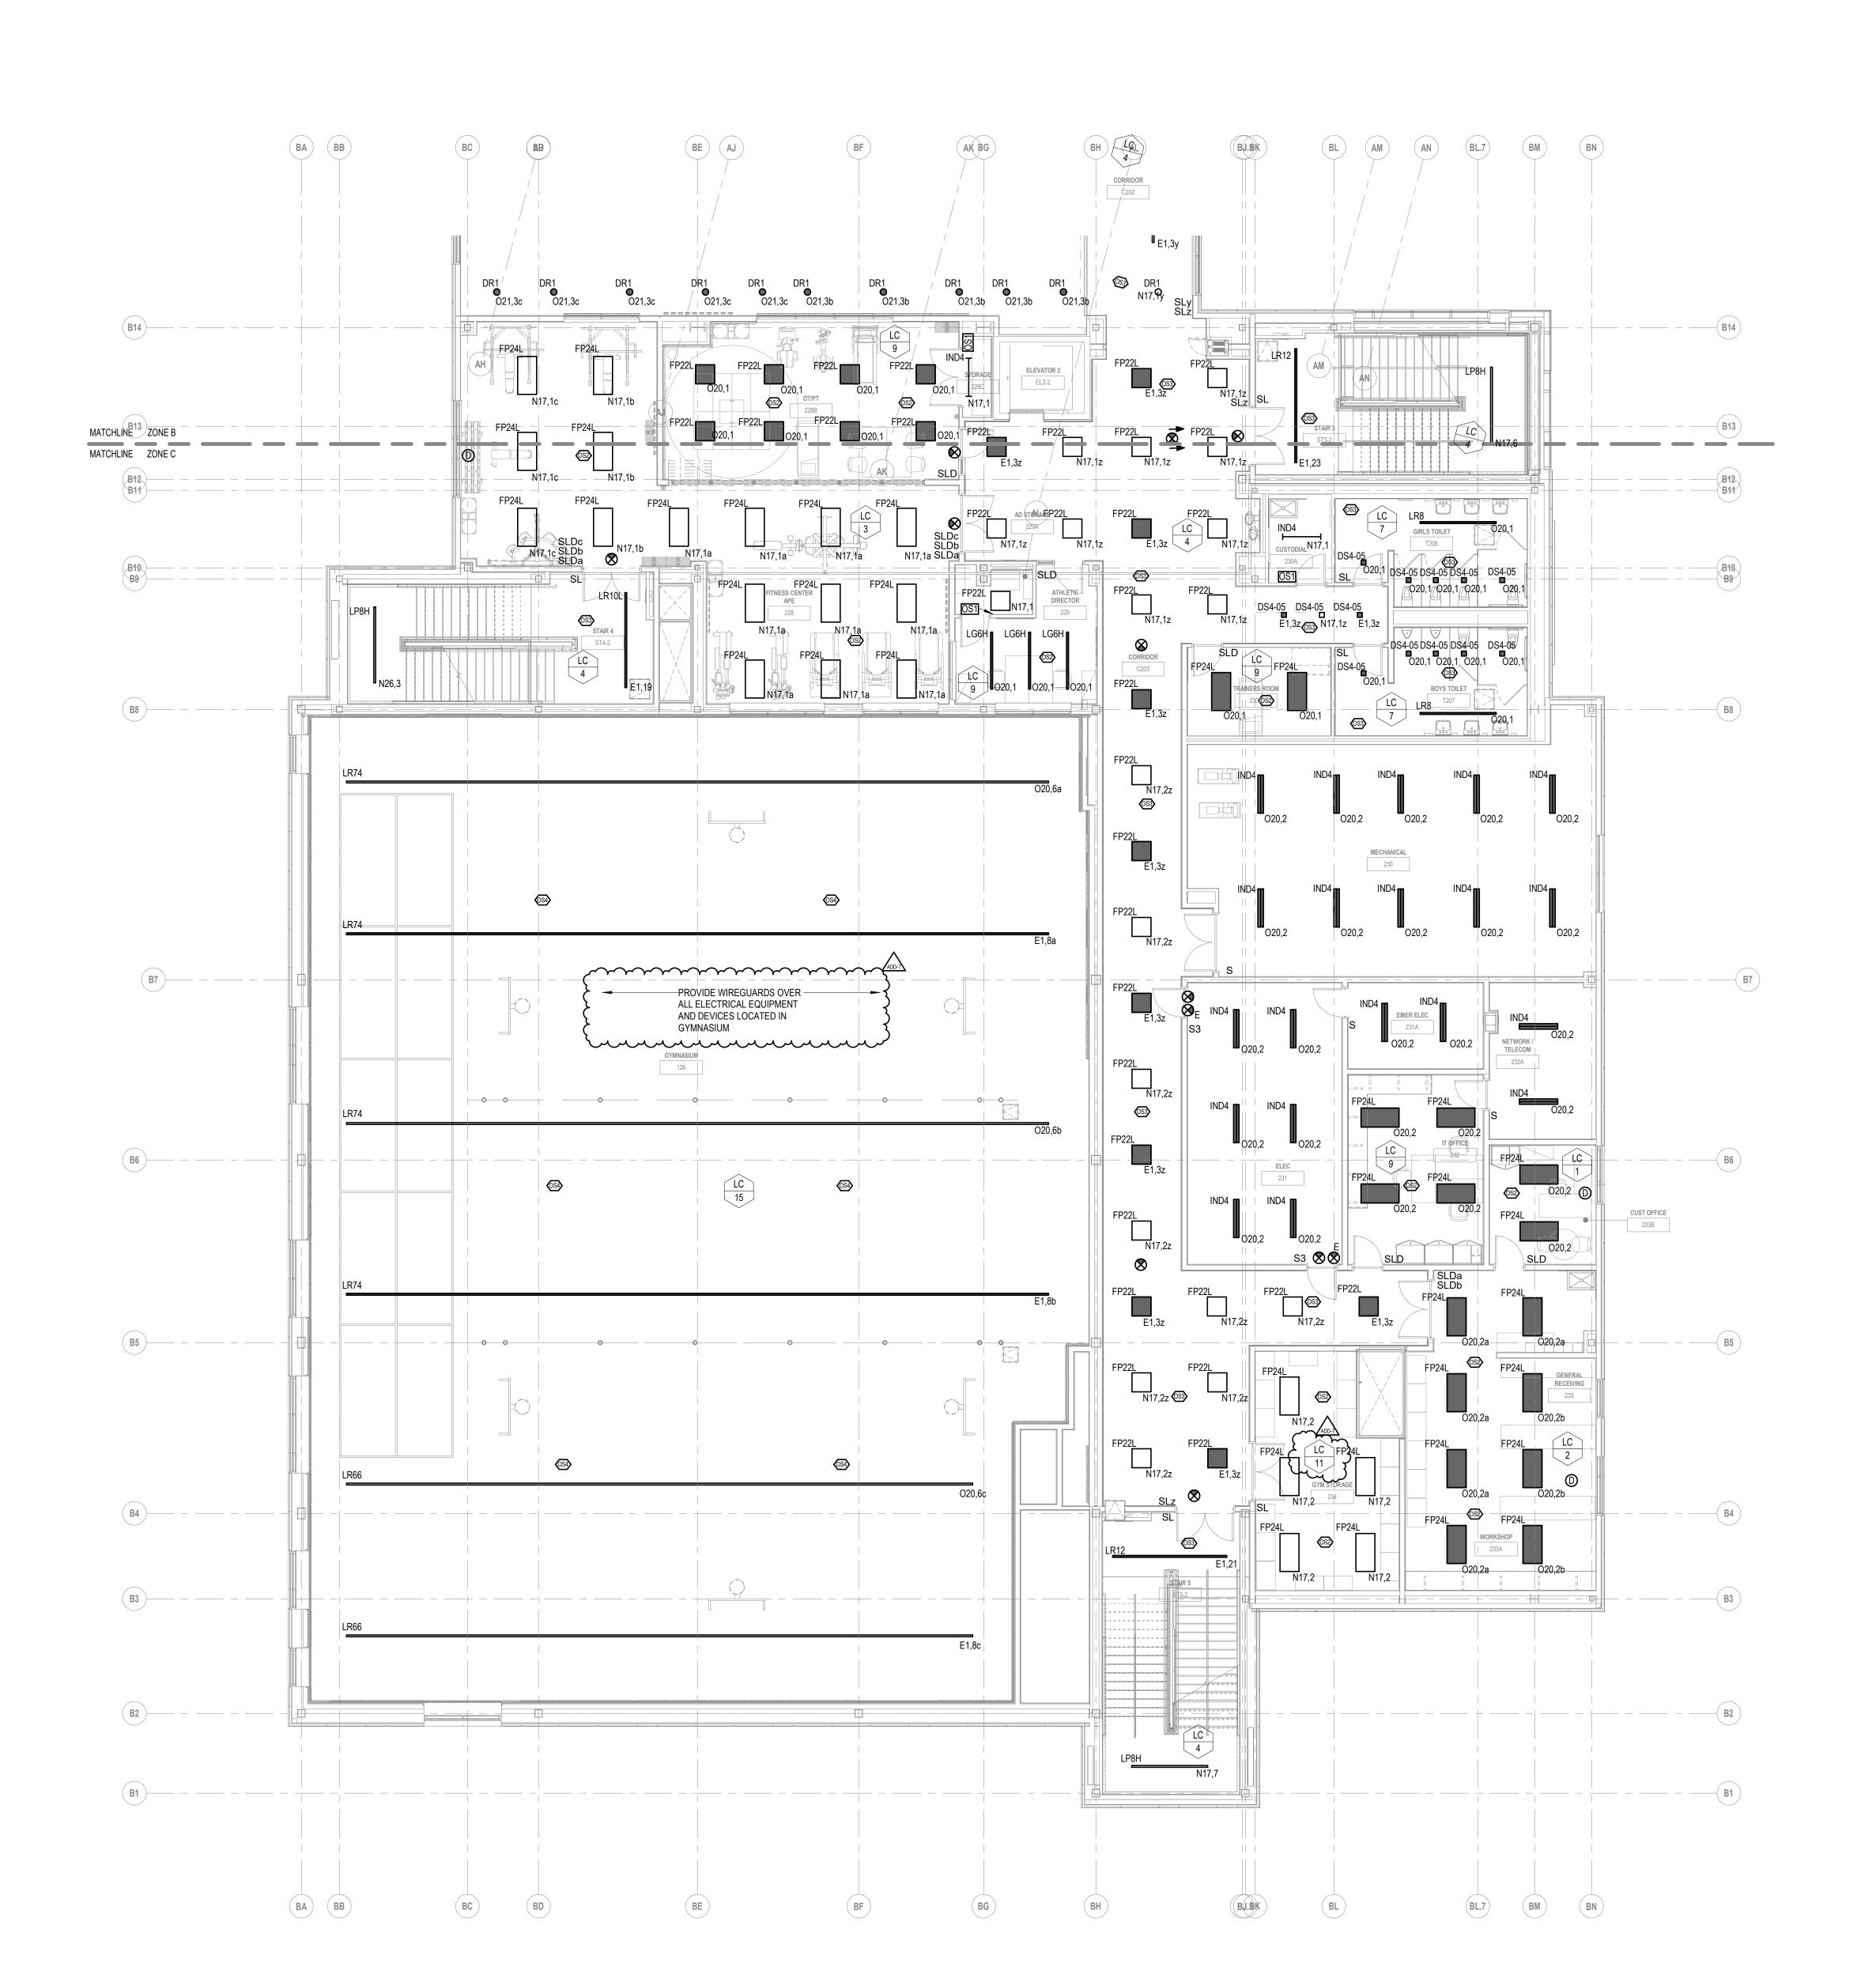

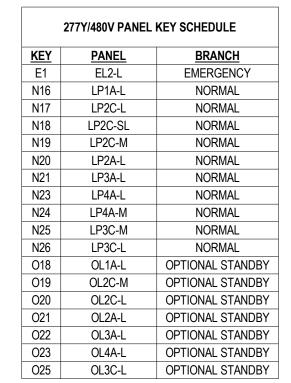

OPTIONAL STANDBY

ARCHIT	S ECTS
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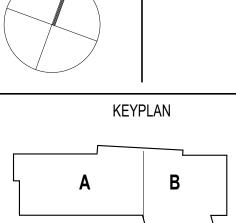
CENTRAL FALLS HIGH SCHOOL 10 HIGGINSON AVE, CENTRAL FALLS, RI


KEYNOTE LEGEND:

208Y/120V PANEL KEY SCHEDULE		
KEY	PANEL NAME	BRANCH
<u>E2</u>	EP2-R	EMERGENCY
C1	CP1A	NORMAL
C2	CP1C	NORMAL
C4	CP2A	NORMAL
C5	CP2C	NORMAL
C6	CP3A	NORMAL
C7	CP3C	NORMAL
C8	CP4A	NORMAL
N1	PP1A-R	NORMAL
N2	PP1A-M	NORMAL
N3	PP1C-M	NORMAL
N4	PP1C-R	NORMAL
N5	PP2A-M	NORMAL
N6	PP2A-R	NORMAL
N7	PP2C-M	NORMAL
N8	PP2C-R	NORMAL
N10	PP3A-R	NORMAL
N11	PP3C-M	NORMAL
N12	PP3C-R	NORMAL
N13	PP4A-M	NORMAL
N14	PP4A-R	NORMAL
N15	KP1B	NORMAL
N27	PP1A-RBT	NORMAL
01	OP1A-R	OPTIONAL STAND
02	OP1A-M	OPTIONAL STAND
O3	OP1C-M	OPTIONAL STAND
04	OP1C-R	OPTIONAL STAND
06	OP2A-R	OPTIONAL STAND
07	OP2C-M	OPTIONAL STAND
08	OP2C-R	OPTIONAL STAND
O10	OP3A-R	OPTIONAL STAND
011	OP3C-L	OPTIONAL STAND
012	OP3C-M	OPTIONAL STAND
013	OP3C-R	OPTIONAL STAND
015	OP4A-R	OPTIONAL STAND
016	OKP1B	OPTIONAL STAND
017	OMDF	OPTIONAL STAND

OPTIONAL STANDBY	
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	- 1

ADDENDUM 6 ADDENDUM 3 100% CONSTRUCTION DOCUMENTS KEY PLAN NORTH ARROW |



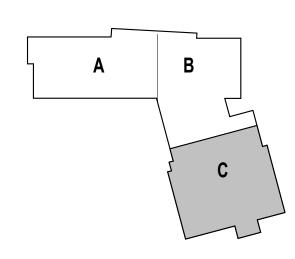


DRAWING NAME: ELECTRICAL SECOND FLOOR LIGHTING PLAN -ZONE C

DRAWN BY:		RBC/JAJ
REVIEWED B'	Y:	RCB
SCALE:	AS NOTED	DRAWING NUMBER:
JOB NO.:	2202.02	F1 12C
DATE: OCT	OBER 13, 2023	L1.120

1 SECOND FLOOR LIGHTING PLAN - ZONE C

	MATCHLINE ZONE B MATCHLINE ZONE B	AH AJ	AK AL	AM AN	
A6 — — — — — — — — — — — — — — — — — — —	VM2	VM2 VM2 N23,4c VM1 VM1 VM1	VM1 LG12	DIVERSE LEARNERS (SPEECH) 1 N23,6 N23,6 N23,6 N23,6 N23,6 N23,6 N23,6	A6 A5
A4 — —	FP24L SLD VM2 CHEMISTRY VM2 413 SLDC SLDb SLDb SLDa FP22L FP22L FP22L N23,7z FP22L FP22L N23,7z FP22L FP22L N23,7z FP22L FP22L N23,7z FP22L FP22L N23,7z FP22L FP22L N23,7z FP22L FP22L N23,7z FP22L FP22L N23,7z FP22L FP22L N23,7z FP22L FP22L N23,7z FP22L FP22L N23,7z FP22L FP22L N23,7z FP22L FP22L N23,7z FP22L	VM2 VM2 N23,4b N23,4 N23,4a N23,4a N23,4a N23,4 SLDc SLDb SLDb SLDa 3 FP22L N23,7z FP22L N23,7z FP22L N23,7z	4b N23,4b VM1 LC LC 4 4a N23,4a STAIR 2 ST2-4 SS3 E1,17 FP22L SLZ N23,7z FP24L E1,6z CORRIDOR	CORRIDOR C401A FP22L FP22L 9 N23,6 FP22L 9 N23,6 FP22L 9 N23,6 SLD SLD FP22L SLD SLD FP22L G6H N23,6 FP22L FP22L G6H N23,6 G8H FP22L G6H N23,6 FP22L FP22L G6H N23,6 FP22L G6H N23,6 FP22L FP22L FP22L G6H N23,6 FP22L FP2L FP22L FP2L FP22L FP2	A4
A3 ————————————————————————————————————	N23,7z	E1,6z N23,7z N23 N23,7z N23	N23,7z N23,7z DR05 O N23,7z FP2 SLDa VM1 SLDb VM1 SLDc N23,5a	O23,2 PP22L N23,8 SLD SRO OFFICE 1 LG6M SRO OFFICE 1 LG6M N23,8 LG6H N23,8 SOCIAL WORKER A8 A8 A8 A8 A8 A8 A8 A8 A8 A	A3
A1 ————————————————————————————————————	N23,5a N23,5a N23,5a N23,5b N2	VM1 VM1 VM1 VM1 VM1 VM1 VM1 VM1 VM1	VM1 VM1 DIVE LEARI (BEHAW MEET 42	SLDa SLDb E1,6 LG6H 1 N23,6 N23,6 N23,6 LC SS N23,2b N23,6 N23,6 N23,6 N23,6 N23,6	B15
B15	AF AG			AM) AN)	B13 B12 B10 B99
	B13 B12 B31 BA BB	AH AJ BBD BIO BB BE	AK AL BG	BH B8 BL	BL.7 BM BN

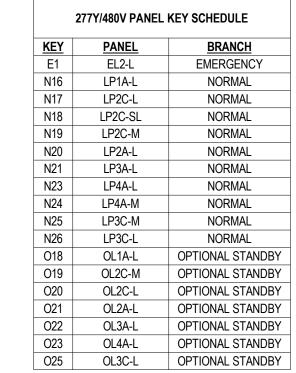

277Y/480V PANEL KEY SCHEDULE				
KEY	<u>PANEL</u>	BRANCH		
E1	EL2-L	EMERGENCY		
N16	LP1A-L	NORMAL		
N17	LP2C-L	NORMAL		
N18	LP2C-SL	NORMAL		
N19	LP2C-M	NORMAL		
N20	LP2A-L	NORMAL		
N21	LP3A-L	NORMAL		
N23	LP4A-L	NORMAL		
N24	LP4A-M	NORMAL		
N25	LP3C-M	NORMAL		
N26	LP3C-L	NORMAL		
O18	OL1A-L	OPTIONAL STANDBY		
O19	OL2C-M	OPTIONAL STANDBY		
O20	OL2C-L	OPTIONAL STANDBY		
O21	OL2A-L	OPTIONAL STANDBY		
022	OL3A-L	OPTIONAL STANDBY		
O23	OL4A-L	OPTIONAL STANDBY		

	208Y/120V PANEL	KEY SCHEDULE
KEY	PANEL NAME	BRANCH
E2	EP2-R	EMERGENCY
C1	CP1A	NORMAL
C2	CP1C	NORMAL
C4	CP2A	NORMAL
C5	CP2C	NORMAL
C6	CP3A	NORMAL
C7	CP3C	NORMAL
C8	CP4A	NORMAL
N1	PP1A-R	NORMAL
N2	PP1A-M	NORMAL
N3	PP1C-M	NORMAL
N4	PP1C-R	NORMAL
N5	PP2A-M	NORMAL
N6	PP2A-R	NORMAL
N7	PP2C-M	NORMAL
N8	PP2C-R	NORMAL
N10	PP3A-R	NORMAL
N11	PP3C-M	NORMAL
N12	PP3C-R	NORMAL
N13	PP4A-M	NORMAL
N14	PP4A-R	NORMAL
N15	KP1B	NORMAL
N27	PP1A-RBT	NORMAL
01	OP1A-R	OPTIONAL STANDBY
02	OP1A-M	OPTIONAL STANDBY
O3	OP1C-M	OPTIONAL STANDBY
04	OP1C-R	OPTIONAL STANDBY
O6	OP2A-R	OPTIONAL STANDBY
07	OP2C-M	OPTIONAL STANDBY
08	OP2C-R	OPTIONAL STANDBY
O10	OP3A-R	OPTIONAL STANDBY
011	OP3C-L	OPTIONAL STANDBY
012	OP3C-M	OPTIONAL STANDBY
013	OP3C-R	OPTIONAL STANDBY
O15	OP4A-R	OPTIONAL STANDBY
O16	OKP1B	OPTIONAL STANDBY
017	OMDF	OPTIONAL STANDBY


1 FOURTH FLOOR LIGHTING PLAN - ZONE B

Framingham, MA 01701 111Speen Street, Suite 300


508.358.0790

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ADDENDUM 6 ADDENDUM 3 100% CONSTRUCTION DOCUMENTS KEY PLAN NORTH ARROW |

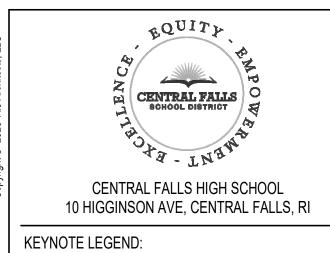

DRAWING NAME: ELECTRICAL FOURTH FLOOR LIGHTING PLAN -

	ZONI	EΒ
DRAWN BY:		RBC/JAJ
REVIEWED BY	' :	RCB
SCALE:	AS NOTED	DRAWING NUMBER:
JOB NO.:	2202.02	F1.14B
DATE: OCTO	OBER 13, 2023	

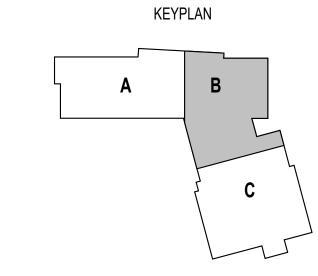BRANCH	<u>PANEL</u>	KEY
EMERGENC	EL2-L	E1
NORMAL	LP1A-L	N16
NORMAL	LP2C-L	N17
NORMAL	LP2C-SL	N18
NORMAL	LP2C-M	N19
NORMAL	LP2A-L	N20
NORMAL	LP3A-L	N21
NORMAL	LP4A-L	N23
NORMAL	LP4A-M	N24
NORMAL	LP3C-M	N25
NORMAL	LP3C-L	N26
OPTIONAL STAN	OL1A-L	O18
OPTIONAL STAN	OL2C-M	O19
OPTIONAL STAN	OL2C-L	O20
OPTIONAL STAN	OL2A-L	O21
OPTIONAL STAN	OL3A-L	O22
OPTIONAL STAN	OL4A-L	O23
OPTIONAL STAN	OL3C-L	O25

277Y/480V PANEL KEY SCHEDULE		
KEY	PANEL	BRANCH
E1	EL2-L	EMERGENCY
N16	LP1A-L	NORMAL
N17	LP2C-L	NORMAL
N18	LP2C-SL	NORMAL
N19	LP2C-M	NORMAL
N20	LP2A-L	NORMAL
N21	LP3A-L	NORMAL
N23	LP4A-L	NORMAL
N24	LP4A-M	NORMAL
N25	LP3C-M	NORMAL
N26	LP3C-L	NORMAL
018	OL1A-L	OPTIONAL STANDI
019	OL2C-M	OPTIONAL STANDI
O20	OL2C-L	OPTIONAL STANDI
021	OL2A-L	OPTIONAL STANDI
022	OL3A-L	OPTIONAL STANDI
023	OL4A-L	OPTIONAL STANDI
005	01.00.1	ODTIONAL OTANDI

	208Y/120V PANEL	KET SCHEDULE
<u>KEY</u>	PANEL NAME	BRANCH
E2	EP2-R	EMERGENCY
C1	CP1A	NORMAL
C2	CP1C	NORMAL
C4	CP2A	NORMAL
C5	CP2C	NORMAL
C6	CP3A	NORMAL
C7	CP3C	NORMAL
C8	CP4A	NORMAL
N1	PP1A-R	NORMAL
N2	PP1A-M	NORMAL
N3	PP1C-M	NORMAL
N4	PP1C-R	NORMAL
N5	PP2A-M	NORMAL
N6	PP2A-R	NORMAL
N7	PP2C-M	NORMAL
N8	PP2C-R	NORMAL
N10	PP3A-R	NORMAL
N11	PP3C-M	NORMAL
N12	PP3C-R	NORMAL
N13	PP4A-M	NORMAL
N14	PP4A-R	NORMAL
N15	KP1B	NORMAL
N27	PP1A-RBT	NORMAL
01	OP1A-R	OPTIONAL STANDB
02	OP1A-M	OPTIONAL STANDB
03	OP1C-M	OPTIONAL STANDB
04	OP1C-R	OPTIONAL STANDB
06	OP2A-R	OPTIONAL STANDB
07	OP2C-M	OPTIONAL STANDB
08	OP2C-R	OPTIONAL STANDB
O10	OP3A-R	OPTIONAL STANDB
011	OP3C-L	OPTIONAL STANDB
012	OP3C-M	OPTIONAL STANDB
013	OP3C-R	OPTIONAL STANDB
015	OP4A-R	OPTIONAL STANDB
016	OKP1B	OPTIONAL STANDB
017	OMDF	OPTIONAL STANDB

	<u> </u>
ARCHITE	CTS
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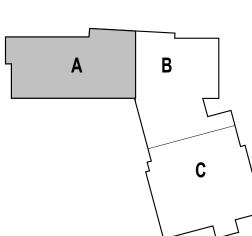
CENTRAL FALLS SCHOOL DISTRICT
CENTRAL FALLS HIGH SCHOOL 10 HIGGINSON AVE, CENTRAL FALLS,

GENERAL NOTES:

ELECTRICAL SUBCONTRACTOR SHALL WIRE ALL
 TERMINAL BOXES SHOWN ON THIS DRAWING TO N2,1.

ADDENDUM 7 ADD-6 ADDENDUM 6 100% CONSTRUCTION DOCUMENTS KEY PLAN NORTH ARROW

KEYPLAN



DRAWING NAME:

ELECTRICAL FIRST FLOOR POWER PLAN -**ZONE A**

	20111	
DRAWN	BY:	RBC/JAJ
REVIEW	/ED BY:	RCB
SCALE:	AS NOTED	DRAWING NUMBER:
JOB NO DATE:	.: 2202.02 OCTOBER 13, 2023	E2.11A

	(AA)	AB AC AC	(AD)	AE	AF AG AG SONE B SONE B LINE ZONE B LINE AG SONE B S
					MATCH
A6 — — — — — — — — — — — — — — — — — — —		N1,58 WP TB			N1,22
A5 — — — — — — — — — — — — — — — — — — —		1-3 C1,1 N1,2 N1,18 N1,2	3 DIVERSE LEARNES (SID THERAPEUTIC) 103 C1,2 TB TB TB N1,18 TB N1,4 N1,3 TB N1,4	N1,18	N1,13 N1,14 C1,4 N1,21 C1,4 C1,6 N1,15 C1,4 C1,4 C1,4 C1,4 C1,4 C1,4 C1,4 C1,4
A4 — — — — — — — — — — — — — — — — — — —	O2,1	DFC N13,4,6 C1,1 Provense Learners (SID) 1018 N1,2 N1,64 N1,2 S	DFC 1-2 C1,2 C1,2 C1,3 DIVERSE LEARNERS (SII 105 TORAGE 103B SMALL GROUP	N1,4 TOILET N1,4 TOILET N1,4 TOILET N1,4 TOILET CALMING ROOM N1,74 N1,74 N1,74 N1,74 N1,74	22
(A3)	O1,5	N1,56	8 E3.01 CORRIDOR	N1,56 N1,57 CUSTODIAL 108	1,10
AJ	N1,58	CLASSROOM 102 N1,55	CLASSROOM 104 N1,53 N1,53 N1,53 N1,53	C1,18 C1,18 C1,18	N27,11 N27,2 N27,3 CR N27,4 N1,50
A2 — — — — — — — — — — — — — — — — — — —		M1,54 C1,17 N1,55	N1,54 C1,16 HD N1,61 BOYS TOIL	N1,65 HD N1,65 HD N1,65 HD N1,62 HD N27,16	N27,7 J N27,6 N1,73 EXAM ROOM N27,5 CR N1,73 N1,73 N1,73 N1,73 N1,73
A1 — — — — — — — — — — — — — — — — — — —		C1,17	TB T101	CIRLS OLET 12.7.7.1.3.1.1.2.1.1.2.1.1.2.1.1.2.1.1.2.1.1.2.1.1.1.2.1	N27,8 (R) (R) (N1,73 (R)
					BB N1,58
	AA	AB	AD	AE	AF BA BB AG BC

1 FIRST FLOOR POWER PLAN - ZONE A
1/8" = 1'-0"

	AF AG				
	NE ZONE B NE ZONE B	AK	AL	AM	
	MATCHLI				
(A6)	ф ° С 1 1 2 2 2 2 2 2 2 2 2 2 2 2 2 2 2 2 2		WP		(A6)
(A5) — — —	N1,10 N1,21 N1,24 C1 N1,24 C1 N1,25 N1,26 N1,27	C1,28 C1,28 C1,28 C1,32 EBP C1,32 EBP C1,32 EBP	01,7	N1,33	
	C1,4 CR N1,31 CR C1,6 CR N1,31 CR N1,10 CR N1,10 CR N1,23 CR N1,24 CR N1,24 CR N1,24 CR N1,24 CR N1,25 CR N1,26 CR N1,26 CR N1,26 CR CR N1,26 CR	C1,7 N1,31 C1,7 C1,30 LBP C1,30 LBP C1,30 LBP C1,30 LBP C1,30 LBP C1,30 LBP C1,30 LBP		Y = = = =	
A4 — — —	TB 2-4 N1,24 N1,63 N1,11 C1,60 PT	N1,24 TB 2-7 N1,32 N1,32	O2,2 S N1,36 HD N1,34 KITCH T105 N1,38 ADMIN CORRIDOR	N1,35 N1,36 N1,36 N1,35	
	TB 2-5 COLLABORATION	N1,56	O1,7 O18 OP TB DUPLICATING / MAIL	01,34 TB 3-10	
(A3)————————————————————————————————————	01,6 O1,4 P C1,13 C O1,72 T N1,49 C O1,13 C O1,72 T N1,49 C O1,13 C O1	C1,18 C1,18 O1,30 AB/CHART N1,44 N1,68 REAK	CORRIDOR C101 N1,38 E2,12 U N1,41	01,34 BN BN	
	N27,1 N2	N1,70	TB V N1,41 BL BL BL	C1,10 BL.7 PRINCIPALS SEGRETARY 119	
A2 — —	N27,5 C1,20 C1,14 CORRIDOR TOLET 112,5 CRIDOR N1,73 N1,73 N1,73 N1,73 N1,52 N1,52 N1,59 N	43 N1,43 N1,43	N1,37	N1,42	A2 B15
A1 — —	C1,20		01,2 01,8 01,8 V 01,8 V 01,37	112 C1,12 N1,60	A1
	BA BB N1,58 CUH 3 VESTIBULE 224		O1,10 (AD) O1,9	5 O2,4 O1,11 (AD) (DP) O1,9	
	O1,12 DP C1 19		(DP) 01,9	(CUH) (DP) Q1,9	B14
	C1,19 cM		3 E6.02	AM AN 204,18	B13
B15			ELEVATOR 2 EL2-1 E12-1 O4,18	CUH 7 \$T341 7 \$T341 7 \$T341 7 8 8 8 8 8 8 8 8 8 8 8 8 8 8 8 8 8 8	B10 B30 B9
			N11,9,11 D E3.02	GIRLS TOILET T106 TOILET TOILET	B9'
	B14	AK	C2,1	N4,1 N4,1 N4,28 (HD) C C2,1 N4,29 (HD) C TOILET	WP N4,20 B8
			CORRII	DOR T107 BOYS TOILET T109 T107	
	B12 B11 BB BC BC	BD B9 BE	BF BG BH B8	BJ.BK BL	BL.7 BM BN
		\ \ \ \			

KEY	<u>PANEL</u>	BRANCH		
E1	EL2-L	EMERGENCY		
N16	LP1A-L	NORMAL		
N17	LP2C-L	NORMAL		
N18	LP2C-SL	NORMAL		
N19	LP2C-M	NORMAL		
N20	LP2A-L	NORMAL		
N21	LP3A-L	NORMAL		
N23	LP4A-L	NORMAL		
N24	LP4A-M	NORMAL		
N25	LP3C-M	NORMAL		
N26	LP3C-L	NORMAL		
O18	OL1A-L	OPTIONAL STANDBY		
O19	OL2C-M	OPTIONAL STANDBY		
O20	OL2C-L	OPTIONAL STANDBY		
O21	OL2A-L	OPTIONAL STANDBY		
022	OL3A-L	OPTIONAL STANDBY		
O23	OL4A-L	OPTIONAL STANDBY		
O25	OL3C-L	OPTIONAL STANDBY		

415
ARCHITECTS
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508.358.0790 www.ai3architects.com



CENTRAL FALLS HIGH SCHOOL 10 HIGGINSON AVE, CENTRAL FALLS, RI

PROVIDE TAMPER-RESISTANT HOSPITAL GRADE TYPE RECEPTACLE AT THIS LOCATION.

1. ELECTRICAL SUBCONTRACTOR SHALL WIRE ALL

TERMINAL BOXES SHOWN ON THIS DRAWING TO N2,2.

KEYNOTE LEGEND:


GENERAL NOTES:


208Y/120V PANEL KEY SCHEDULE				
<u>KEY</u>	PANEL NAME	BRANCH		
E2	EP2-R	EMERGENCY		
C1	CP1A	NORMAL		
C2	CP1C	NORMAL		
C4	CP2A	NORMAL		
C5	CP2C	NORMAL		
C6	CP3A	NORMAL		
C7	CP3C	NORMAL		
C8	CP4A	NORMAL		
N1	PP1A-R	NORMAL		
N2	PP1A-M	NORMAL		
N3	PP1C-M	NORMAL		
N4	PP1C-R	NORMAL		
N5	PP2A-M	NORMAL		
N6	PP2A-R	NORMAL		
N7	PP2C-M	NORMAL		
N8	PP2C-R	NORMAL		
N10	PP3A-R	NORMAL		
N11	PP3C-M	NORMAL		
N12	PP3C-R	NORMAL		
N13	PP4A-M	NORMAL		
N14	PP4A-R	NORMAL		
N15	KP1B	NORMAL		
N27	PP1A-RBT	NORMAL		
01	OP1A-R	OPTIONAL STANDBY		
02	OP1A-M	OPTIONAL STANDBY		
O3	OP1C-M	OPTIONAL STANDBY		
04	OP1C-R	OPTIONAL STANDBY		
O6	OP2A-R	OPTIONAL STANDBY		
07	OP2C-M	OPTIONAL STANDBY		
08	OP2C-R	OPTIONAL STANDBY		
010	OP3A-R	OPTIONAL STANDBY		
011	OP3C-L	OPTIONAL STANDBY		
012	OP3C-M	OPTIONAL STANDBY		
O13	OP3C-R	OPTIONAL STANDBY		
O15	OP4A-R	OPTIONAL STANDBY		
O16	OKP1B	OPTIONAL STANDBY		
017	OMDF	OPTIONAL STANDBY		

1 FIRST FLOOR POWER PLAN - ZONE B

-2U-IVI	NORIVIAL
P2C-R	NORMAL
P3A-R	NORMAL
P3C-M	NORMAL
P3C-R	NORMAL
P4A-M	NORMAL
P4A-R	NORMAL
KP1B	NORMAL
1A-RBT	NORMAL
P1A-R	OPTIONAL STANDBY
P1A-M	OPTIONAL STANDBY
P1C-M	OPTIONAL STANDBY
P1C-R	OPTIONAL STANDBY
P2A-R	OPTIONAL STANDBY
P2C-M	OPTIONAL STANDBY
P2C-R	OPTIONAL STANDBY
P3A-R	OPTIONAL STANDBY
P3C-L	OPTIONAL STANDBY
P3C-M	OPTIONAL STANDBY
P3C-R	OPTIONAL STANDBY
P4A-R	OPTIONAL STANDBY
KP1B	OPTIONAL STANDBY
OMDF	OPTIONAL STANDBY
WDI	OF HONAL OTANDET


ADD-7 ADD-6	ADDENDUM 7 ADDENDUM 6	1/26/2024 1/23/2024
100% CC	ONSTRUCTION D	OCUMENTS
KEY PLAN NO	ORTH ARROW	

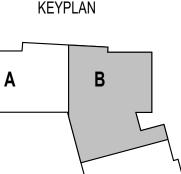


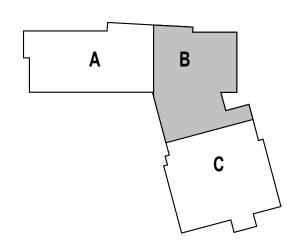

DRAWING NAME: ELECTRICAL FIRST FLOOR POWER PLAN -ZONE B

	ZON	
DRAWN BY:		RBC/JAJ
REVIEWED B	Y:	RCB
SCALE:	AS NOTED	DRAWING NUMBER:
JOB NO.:	2202.02	F2 11R
DATE: OCT	OBER 13, 2023	

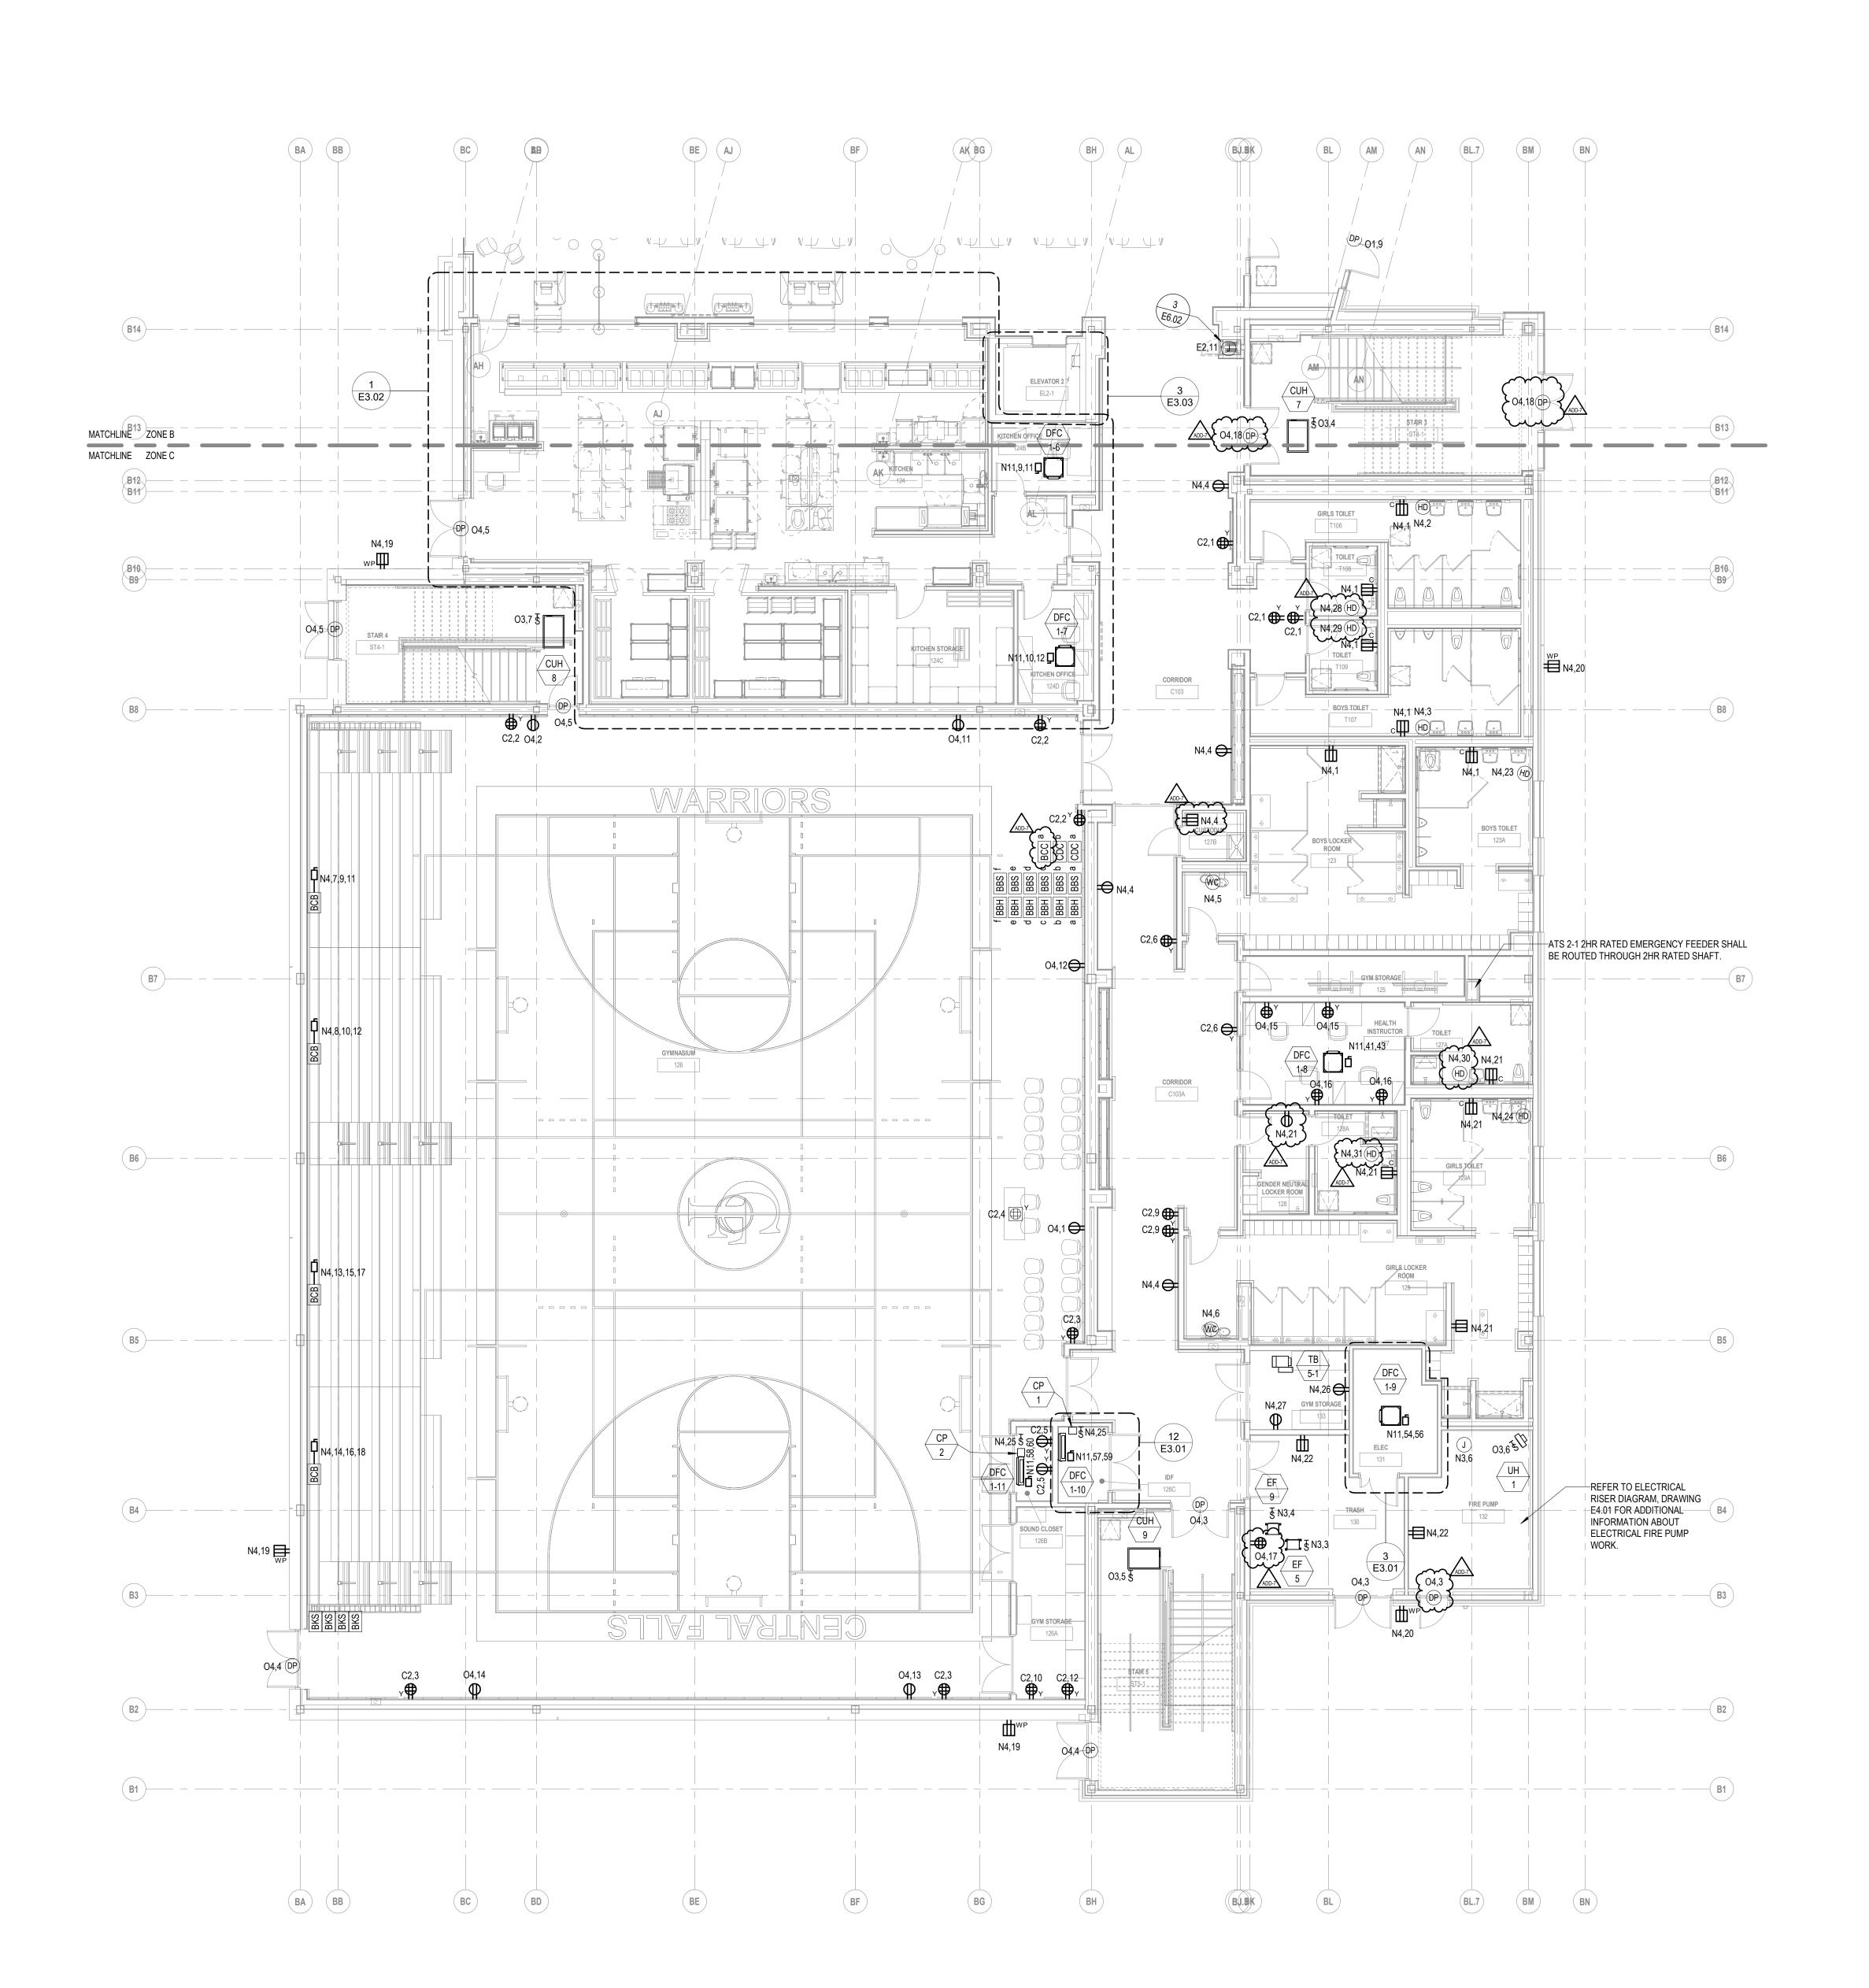

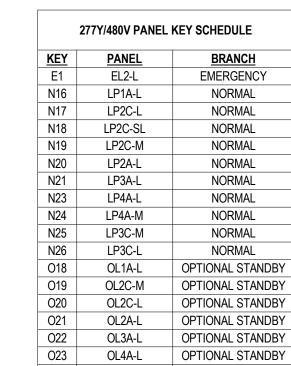

	KEY SCHEDULE	277Y/480V PANEL KEY SCHEDULE		
	BRANCH	<u>PANEL</u>	KEY	
	EMERGENCY	EL2-L	E1	
	NORMAL	LP1A-L	N16	
	NORMAL	LP2C-L	N17	
	NORMAL	LP2C-SL	N18	
	NORMAL	LP2C-M	N19	
	NORMAL	LP2A-L	N20	
\wedge	NORMAL	LP3A-L	N21	
$\overline{}$	NORMAL	LP4A-L	N23	
	NORMAL	LP4A-M	N24	
111Speen S	NORMAL	LP3C-M	N25	
508.358.07	NORMAL	LP3C-L	N26	
	OPTIONAL STANDBY	OL1A-L	O18	
	OPTIONAL STANDBY	OL2C-M	O19	
	OPTIONAL STANDBY	OL2C-L	O20	
	OPTIONAL STANDBY	OL2A-L	O21	
	OPTIONAL STANDBY	OL3A-L	O22	
	OPTIONAL STANDBY	OL4A-L	O23	
G	OPTIONAL STANDBY	OL3C-L	O25	

	208Y/120V PANEL	KEY SCHEDULE
KEY	PANEL NAME	BRANCH
<u>E2</u>	EP2-R	EMERGENCY
C1	CP1A	NORMAL
C2	CP1C	NORMAL
C4	CP2A	NORMAL
C5	CP2C	NORMAL
C6	CP3A	NORMAL
C7	CP3C	NORMAL
C8	CP4A	NORMAL
N1	PP1A-R	NORMAL
N2	PP1A-M	NORMAL
N3	PP1C-M	NORMAL
N4	PP1C-R	NORMAL
N5	PP2A-M	NORMAL
N6	PP2A-R	NORMAL
N7	PP2C-M	NORMAL
N8	PP2C-R	NORMAL
N10	PP3A-R	NORMAL
N11	PP3C-M	NORMAL
N12	PP3C-R	NORMAL
N13	PP4A-M	NORMAL
N14	PP4A-R	NORMAL
N15	KP1B	NORMAL
N27	PP1A-RBT	NORMAL
01	OP1A-R	OPTIONAL STANDBY
02	OP1A-M	OPTIONAL STANDBY
О3	OP1C-M	OPTIONAL STANDBY
04	OP1C-R	OPTIONAL STANDBY
06	OP2A-R	OPTIONAL STANDBY
07	OP2C-M	OPTIONAL STANDBY
08	OP2C-R	OPTIONAL STANDBY
010	OP3A-R	OPTIONAL STANDBY
011	OP3C-L	OPTIONAL STANDBY
012	OP3C-M	OPTIONAL STANDBY
O13	OP3C-R	OPTIONAL STANDBY
015	OP4A-R	OPTIONAL STANDBY
O16	OKP1B	OPTIONAL STANDBY
017	OMDF	OPTIONAL STANDBY

	3
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GENERAL NOTES:


ELECTRICAL SUBCONTRACTOR SHALL WIRE ALL TERMINAL BOXES SHOWN ON THIS DRAWING TO N3,2.

ADDENDUM 7 **ADDENDUM 6** 100% CONSTRUCTION DOCUMENTS KEY PLAN NORTH ARROW |

KEYPLAN

DRAWING NAME: ELECTRICAL FIRST FLOOR POWER PLAN -**ZONE C**

RBC/JAJ DRAWN BY: REVIEWED BY: SCALE: AS NOTED | DRAWING NUMBER: JOB NO.: 2202.02 E2.11C

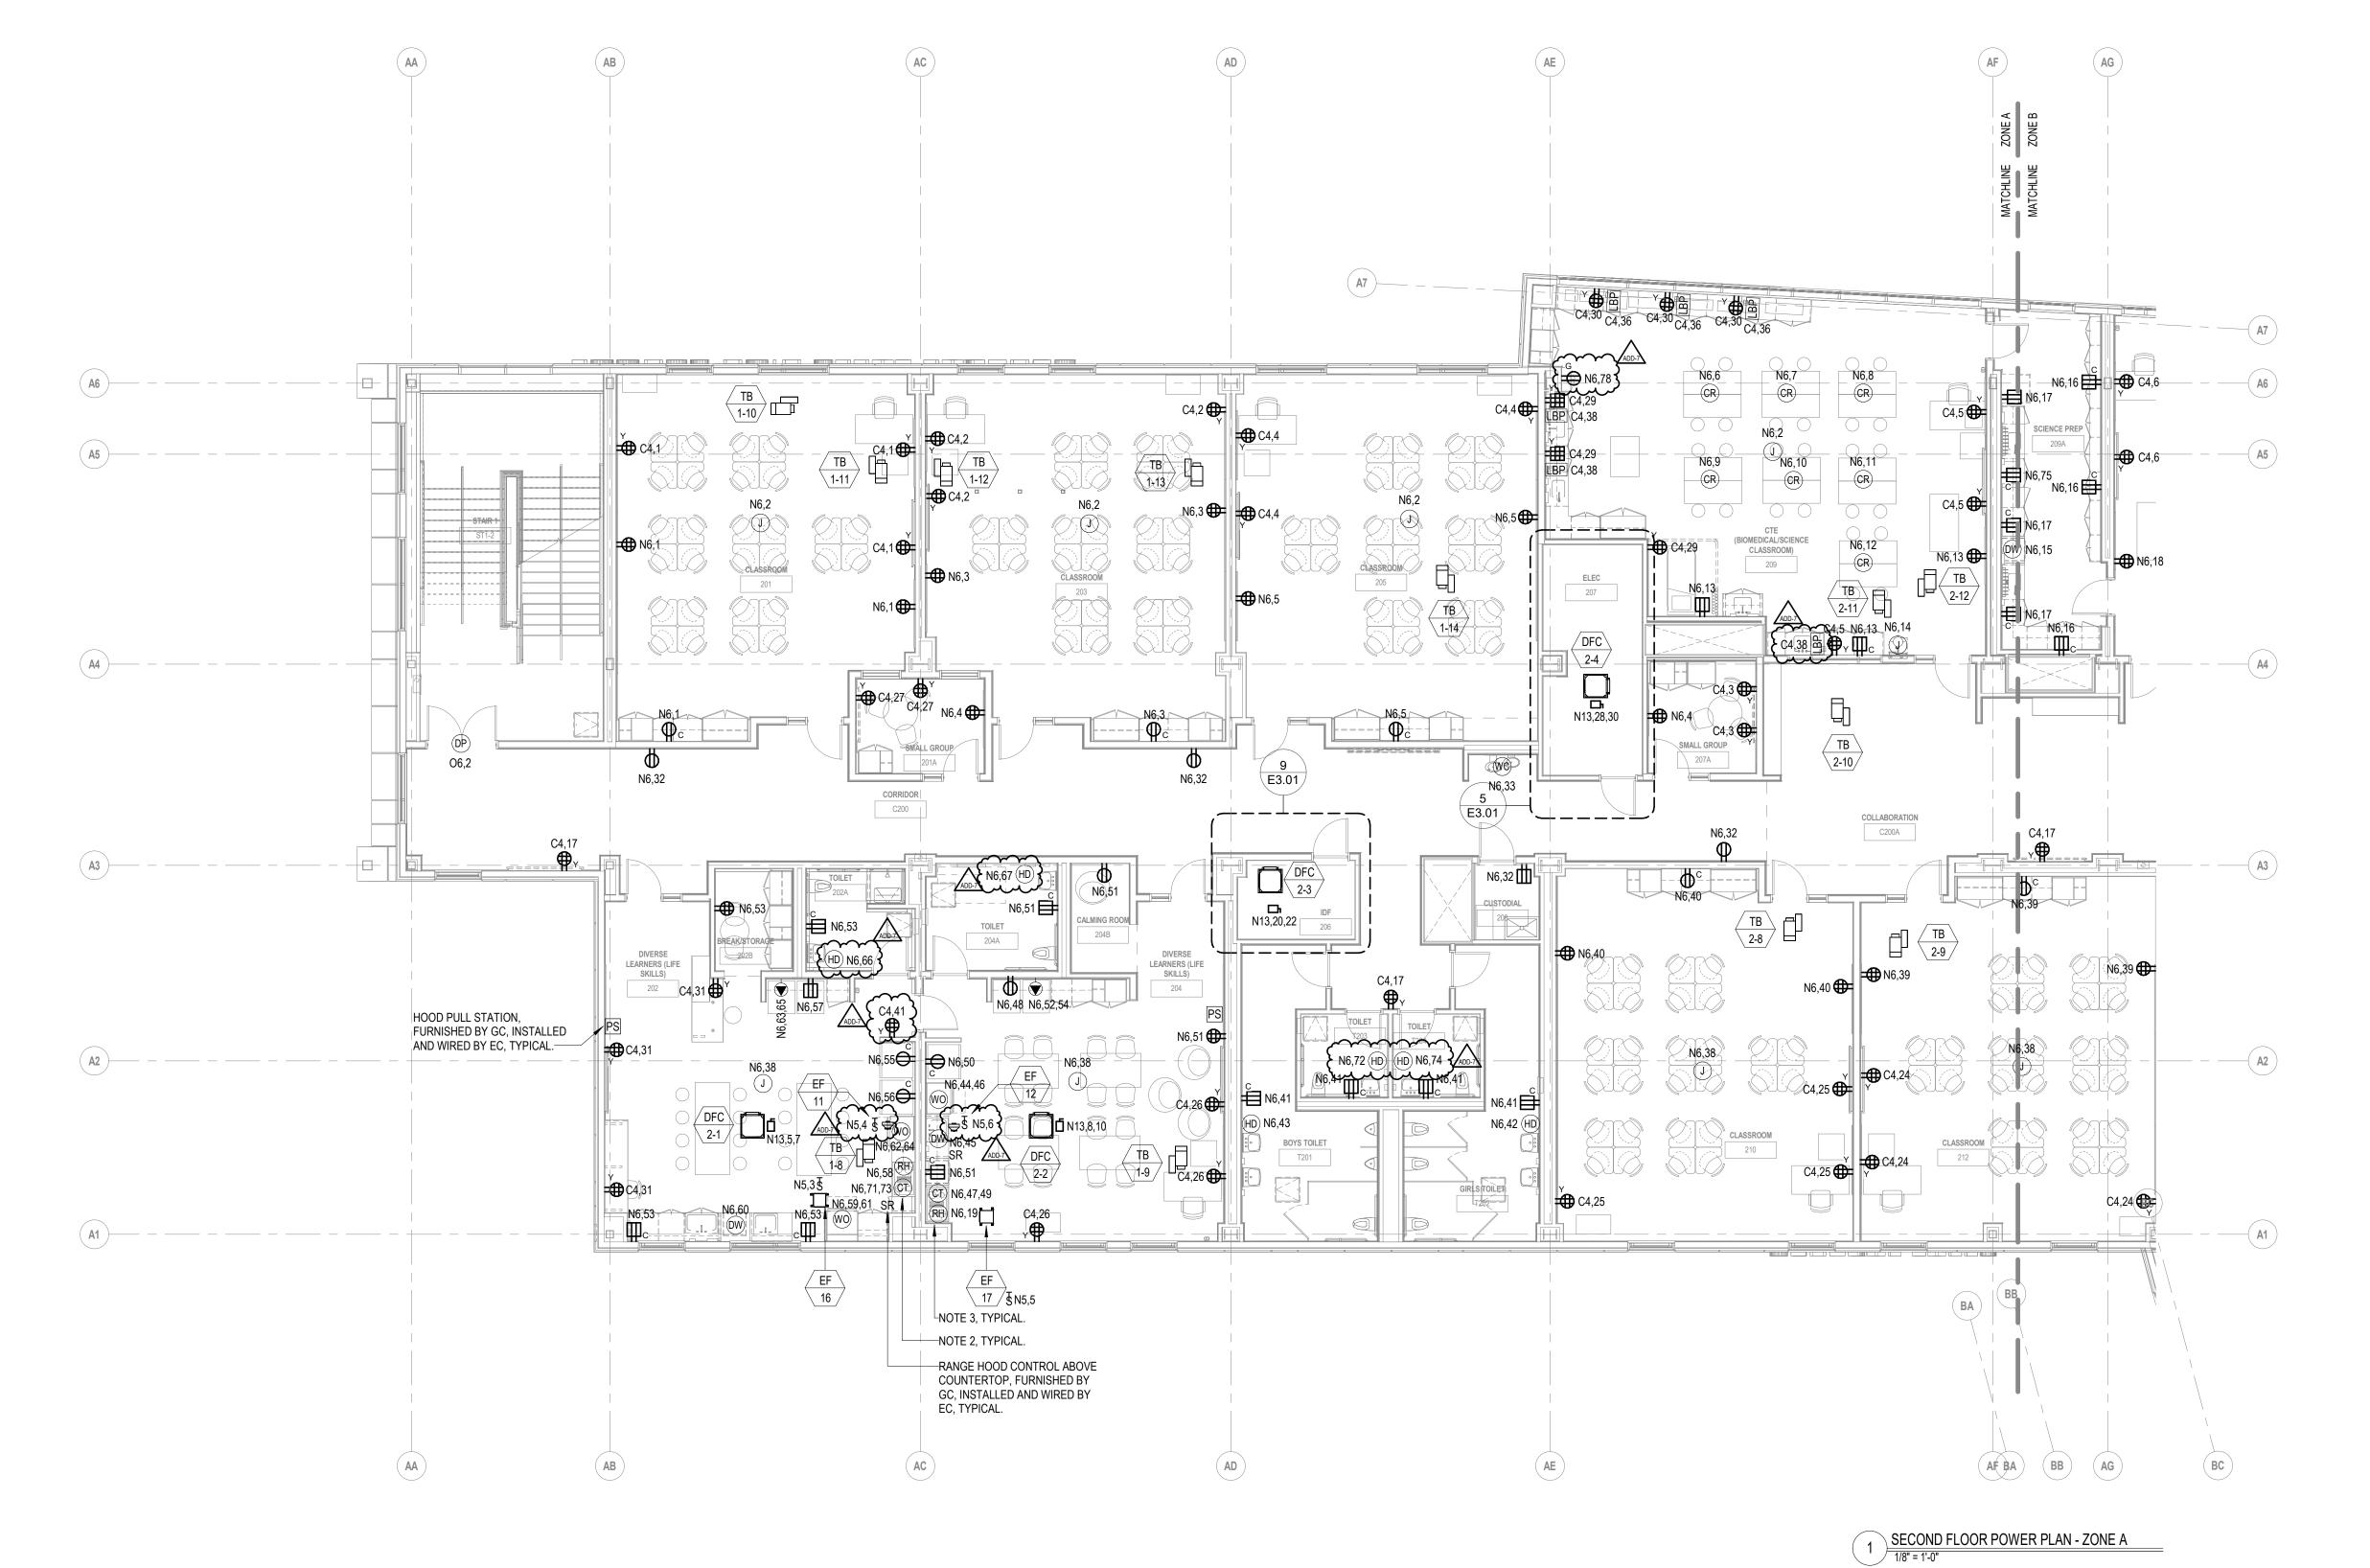

	277Y/480V PANEL	KEY SCHEDULE
KEY	PANEL	BRANCH
E1	EL2-L	EMERGENCY
N16	LP1A-L	NORMAL
N17	LP2C-L	NORMAL
N18	LP2C-SL	NORMAL
N19	LP2C-M	NORMAL
N20	LP2A-L	NORMAL
N21	LP3A-L	NORMAL
N23	LP4A-L	NORMAL
N24	LP4A-M	NORMAL
N25	LP3C-M	NORMAL
N26	LP3C-L	NORMAL
018	OL1A-L	OPTIONAL STANDBY
O19	OL2C-M	OPTIONAL STANDBY
O20	OL2C-L	OPTIONAL STANDBY
021	OL2A-L	OPTIONAL STANDBY
022	OL3A-L	OPTIONAL STANDBY
O23	OL4A-L	OPTIONAL STANDBY
025	OL3C-L	OPTIONAL STANDBY

208Y/120V PANEL KEY SCHEDULE					
<u>KEY</u>	PANEL NAME	BRANCH			
E2	EP2-R	EMERGENCY			
C1	CP1A	NORMAL			
C2	CP1C	NORMAL			
C4	CP2A	NORMAL			
C5	CP2C	NORMAL			
C6	CP3A	NORMAL			
C7	CP3C	NORMAL			
C8	CP4A	NORMAL			
N1	PP1A-R	NORMAL			
N2	PP1A-M	NORMAL			
N3	PP1C-M	NORMAL			
N4	PP1C-R	NORMAL			
N5	PP2A-M	NORMAL			
N6	PP2A-R	NORMAL			
N7	PP2C-M	NORMAL			
N8	PP2C-R	NORMAL			
N10	PP3A-R	NORMAL			
N11	PP3C-M	NORMAL			
N12	PP3C-R	NORMAL			
N13	PP4A-M	NORMAL			
N14	PP4A-R	NORMAL			
N15	KP1B	NORMAL			
N27	PP1A-RBT	NORMAL			
01	OP1A-R	OPTIONAL STANDBY			
02	OP1A-M	OPTIONAL STANDBY			
O3	OP1C-M	OPTIONAL STANDBY			
04	OP1C-R	OPTIONAL STANDBY			
O6	OP2A-R	OPTIONAL STANDBY			
07	OP2C-M	OPTIONAL STANDBY			
08	OP2C-R	OPTIONAL STANDBY			
O10	OP3A-R	OPTIONAL STANDBY			
011	OP3C-L	OPTIONAL STANDBY			
012	OP3C-M	OPTIONAL STANDBY			
013	OP3C-R	OPTIONAL STANDBY			

OPTIONAL STANDBY
OPTIONAL STANDBY
OPTIONAL STANDBY



508.358.0790


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Consulting Engineers

12 Kendrick Road
Wareham, MA 02571
508-295-0050 (T)

508-295-0003 (F) www.griffithandvary.com

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10 HIGGINSON AVE,
NERAL NOTES:

FLECTRICAL SUBCONTRAC

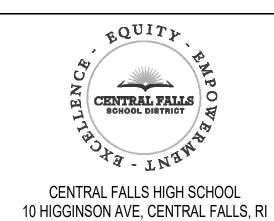ELECTRICAL SUBCONTRACTOR SHALL WIRE ALL TERMINAL BOXES SHOWN ON THIS DRAWING TO N5,1.

RANGE EXHAUST HOOD SHALL BE WIRED SO THAT WHEN THE FIRE SUPPRESSION SYSTEM IS ACTIVATED THE ELECTRIC SUPPLY TO THE COOKTOP LOCATED BELOW THE RANGE EXHAUST HOOD SHALL BE

DISCONNECTED AND THE FIRE ALARM SYSTEM SHALL GO INTO ALARM. PROVIDE 2#12 - 1/2"C. TO PANEL PP2A-R TO ACTIVATE SHUNT TRIP CIRCUIT BREAKER.

PROVIDE WIRING IN 1"C. FROM RANGE EXHAUST HOOD TO ALL ACCESSORIES AS INDICATED ON RANGE EXHAUST HOOD WIRING DIAGRAM.

ADD-7 ADDENDUM 7 1/26/2024

100% CONSTRUCTION DOCUMENTS

KEY PLAN NORTH ARROW

KEYPLAN

A

B

C

DRAWING NAME:

ELECTRICAL
SECOND FLOOR
POWER PLAN -

DRAWN BY:

REVIEWED BY:

SCALE: AS NOTED DRAWING NUMBER:


JOB NO.: 2202.02
DATE: OCTOBER 13, 2023

DRAWING NUMBER:

E2.12A


2 RANGE EXHAUST HOOD WIRING DIAGRAM
Scale: N.T.S

Wiring Diagram: Electric Disconnect

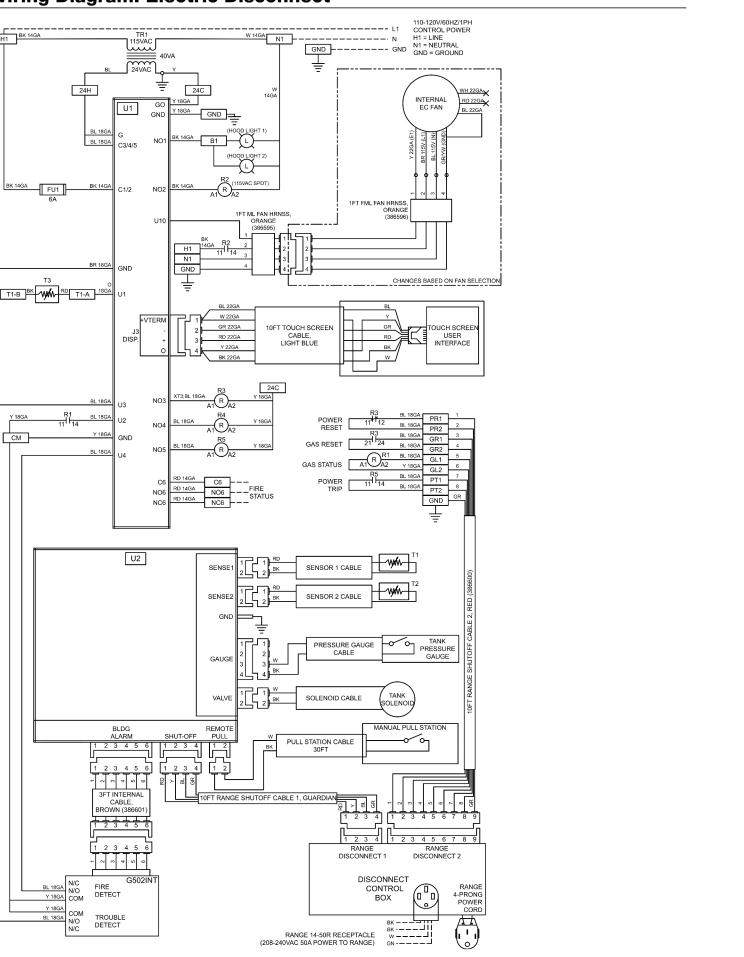

Fire Ready Hood 5

	AF AG AH		AK	AL	AM AN	
	MATCHLINE ZONE A MATCHLINE ZONE B					
(A7)						
A6	N6,16 C C C C C C C C C C C C C C C C C C C	C4,32 C4,40 C4,32 N6,70 C4,40 LBP C4,7	C4,7	C4,10 DIRECTOR OF PATHWAYS C4,11 C4,11	DEAN 1 218	
A5	209A N6,20 N6,21 N6,75 CT N6,16 TO N6,16 TO N6,21 N6,25 N6,24	N6,22 N6,68 C4,33 C4,40 LBP C4,7 C4,40 LBP C4,33 C4,33 C4,39 LBP	STAIR 2	C4,10		
	N6,13 (CR) (CR) N6,18 (CR) N6,18 (CR) N6,18 (CR) N6,18 (CR) N6,16	TB 2-14 213		N6,31 TB C 3-18 C N6,31		
A4 ———	N6,14 N6,14	N6,77 (C4,42)	C4,9 (C4,9 (OF)) (OF) (OF) (OF) (OF) (OF) (OF) (OF	GUIDANCE CORRIDOR C202A TB C4,18 GUIDANCE WAITING ROOM	CIAL WORKER 220 4,12	——————————————————————————————————————
	TB 2-13 (C4,17 (C200A) (C4,17		CORRIDOR	06,1 (DP) N6,27	4,12 GUIDANCE OFFICE 221	$\overline{-}$ $\overline{A3}$
(A3)	N6,39	N6,37 N6,37 N6,37 N6,34 N6,34	G ELEVATOR 1 EL1-2	CAREER CENTER 3-24	N6,28 UIDANCE OFFICE BM 1,13	
A2	N6,38 C4,23	TB 3-14 N6,37 N6,34 N6,34 N6,34	PUMP ROOM 227 C4,34	TB N6,69 N6,30 3-23 N6,29 3-27 GUIDANCE OFFICI	### 13	—(A2)
	C4,22 (C4,23 (C4,23) (C4,23 (C4,23 (C4,23 (C4,23) (C4,23 (BE BF	C4,35— C4,37— N6,31		24,14	B15
A1	C4,24			C4,15 N6,28 C4	P	——————————————————————————————————————
			COL	DRRIDOR .		B14
				DRIDOR C202		B13
B15	AF			3 E6.02 E2,21	AM AM	B12 B11
		C5,3 N8,1	N8.1 STORAGE STORAGE 228C 2-12	08,2 OP	STAIR 3 ST3.2 CIM (HD) 0 0 0 0 0 0 0 0 0 0 0 0 0 0 0 0 0 0 0	B10 B9
	AH	OT/PT 228B	C5,3	N8,33 WS	CUSTODIAL N8,6 ADD-2 C5,4	B8
	B14	C5,2 (C)	DFC 2-13 AD STORAGE 229A	ATHLETIC DIRECTOR CORRIDOR C203		
	B13 BB1 BB	BC BD B9 BE	FITNESS CENTER APE 228 BF	C203	BJ.8K BL	BL.7 BM BN

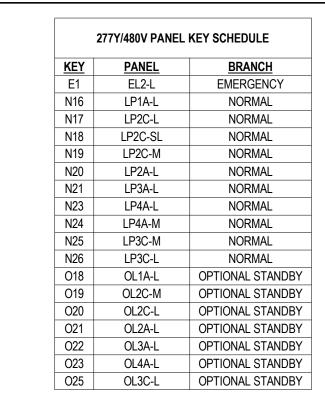

	3
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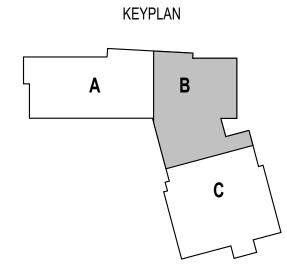
	208Y/120V PANEL	KEY SCHEDULE		
<u>KEY</u>	PANEL NAME	BRANCH		
E2	EP2-R	EMERGENCY		
C1	CP1A	NORMAL		
C2	CP1C	NORMAL		
C4	CP2A	NORMAL		
C5	CP2C	NORMAL		
C6	CP3A	NORMAL		
C7	CP3C	NORMAL		
C8	CP4A	NORMAL		
N1	PP1A-R	NORMAL		
N2	PP1A-M	NORMAL		
N3	PP1C-M	NORMAL		
N4	PP1C-R	NORMAL		
N5	PP2A-M	NORMAL		
N6	PP2A-R	NORMAL		
N7	PP2C-M	NORMAL		
N8	PP2C-R	NORMAL		
N10	PP3A-R	NORMAL		
N11	PP3C-M NORMAL			
N12	PP3C-R	NORMAL		
N13	PP4A-M	NORMAL		
N14	PP4A-R	NORMAL		
N15	KP1B NORMAL			
N27	PP1A-RBT	NORMAL		
01	OP1A-R	OPTIONAL STANDBY		
02	OP1A-M	OPTIONAL STANDBY		
O3	OP1C-M	OPTIONAL STANDBY		
04	OP1C-R	OPTIONAL STANDBY		
O6	OP2A-R	OPTIONAL STANDBY		
07	OP2C-M	OPTIONAL STANDBY		
08	OP2C-R	OPTIONAL STANDBY		
O10	OP3A-R	OPTIONAL STANDBY		
011	OP3C-L	OPTIONAL STANDBY		
012	OP3C-M	OPTIONAL STANDBY		
O13	OP3C-R	OPTIONAL STANDBY		
015	OP4A-R	OPTIONAL STANDBY		
O16	OKP1B	OPTIONAL STANDBY		
017	OMDF	OPTIONAL STANDBY		

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	GENERAL NOTES:
	ELECTRICAL SUBCONTRACTOR SHALL WIRE ALL TERMINAL BOXES SHOWN ON THIS DRAWING TO N5,2.

ADD-7 ADDENDUM 7 1/26/2024

100% CONSTRUCTION DOCUMENTS


KEY PLAN NORTH ARROW




ELECTRICAL
SECOND FLOOR
POWER PLAN 70NF B

		ZON	EΒ
DRAWN	BY:		RBC/JAJ
REVIEW	ED BY:		RCB
SCALE:		AS NOTED	DRAWING NUMBER:
JOB NO	.:	2202.02	F2 12R
DATE:	OCTOE	BER 13, 2023	

1 SECOND FLOOR POWER PLAN - ZONE B
1/8" = 1'-0"

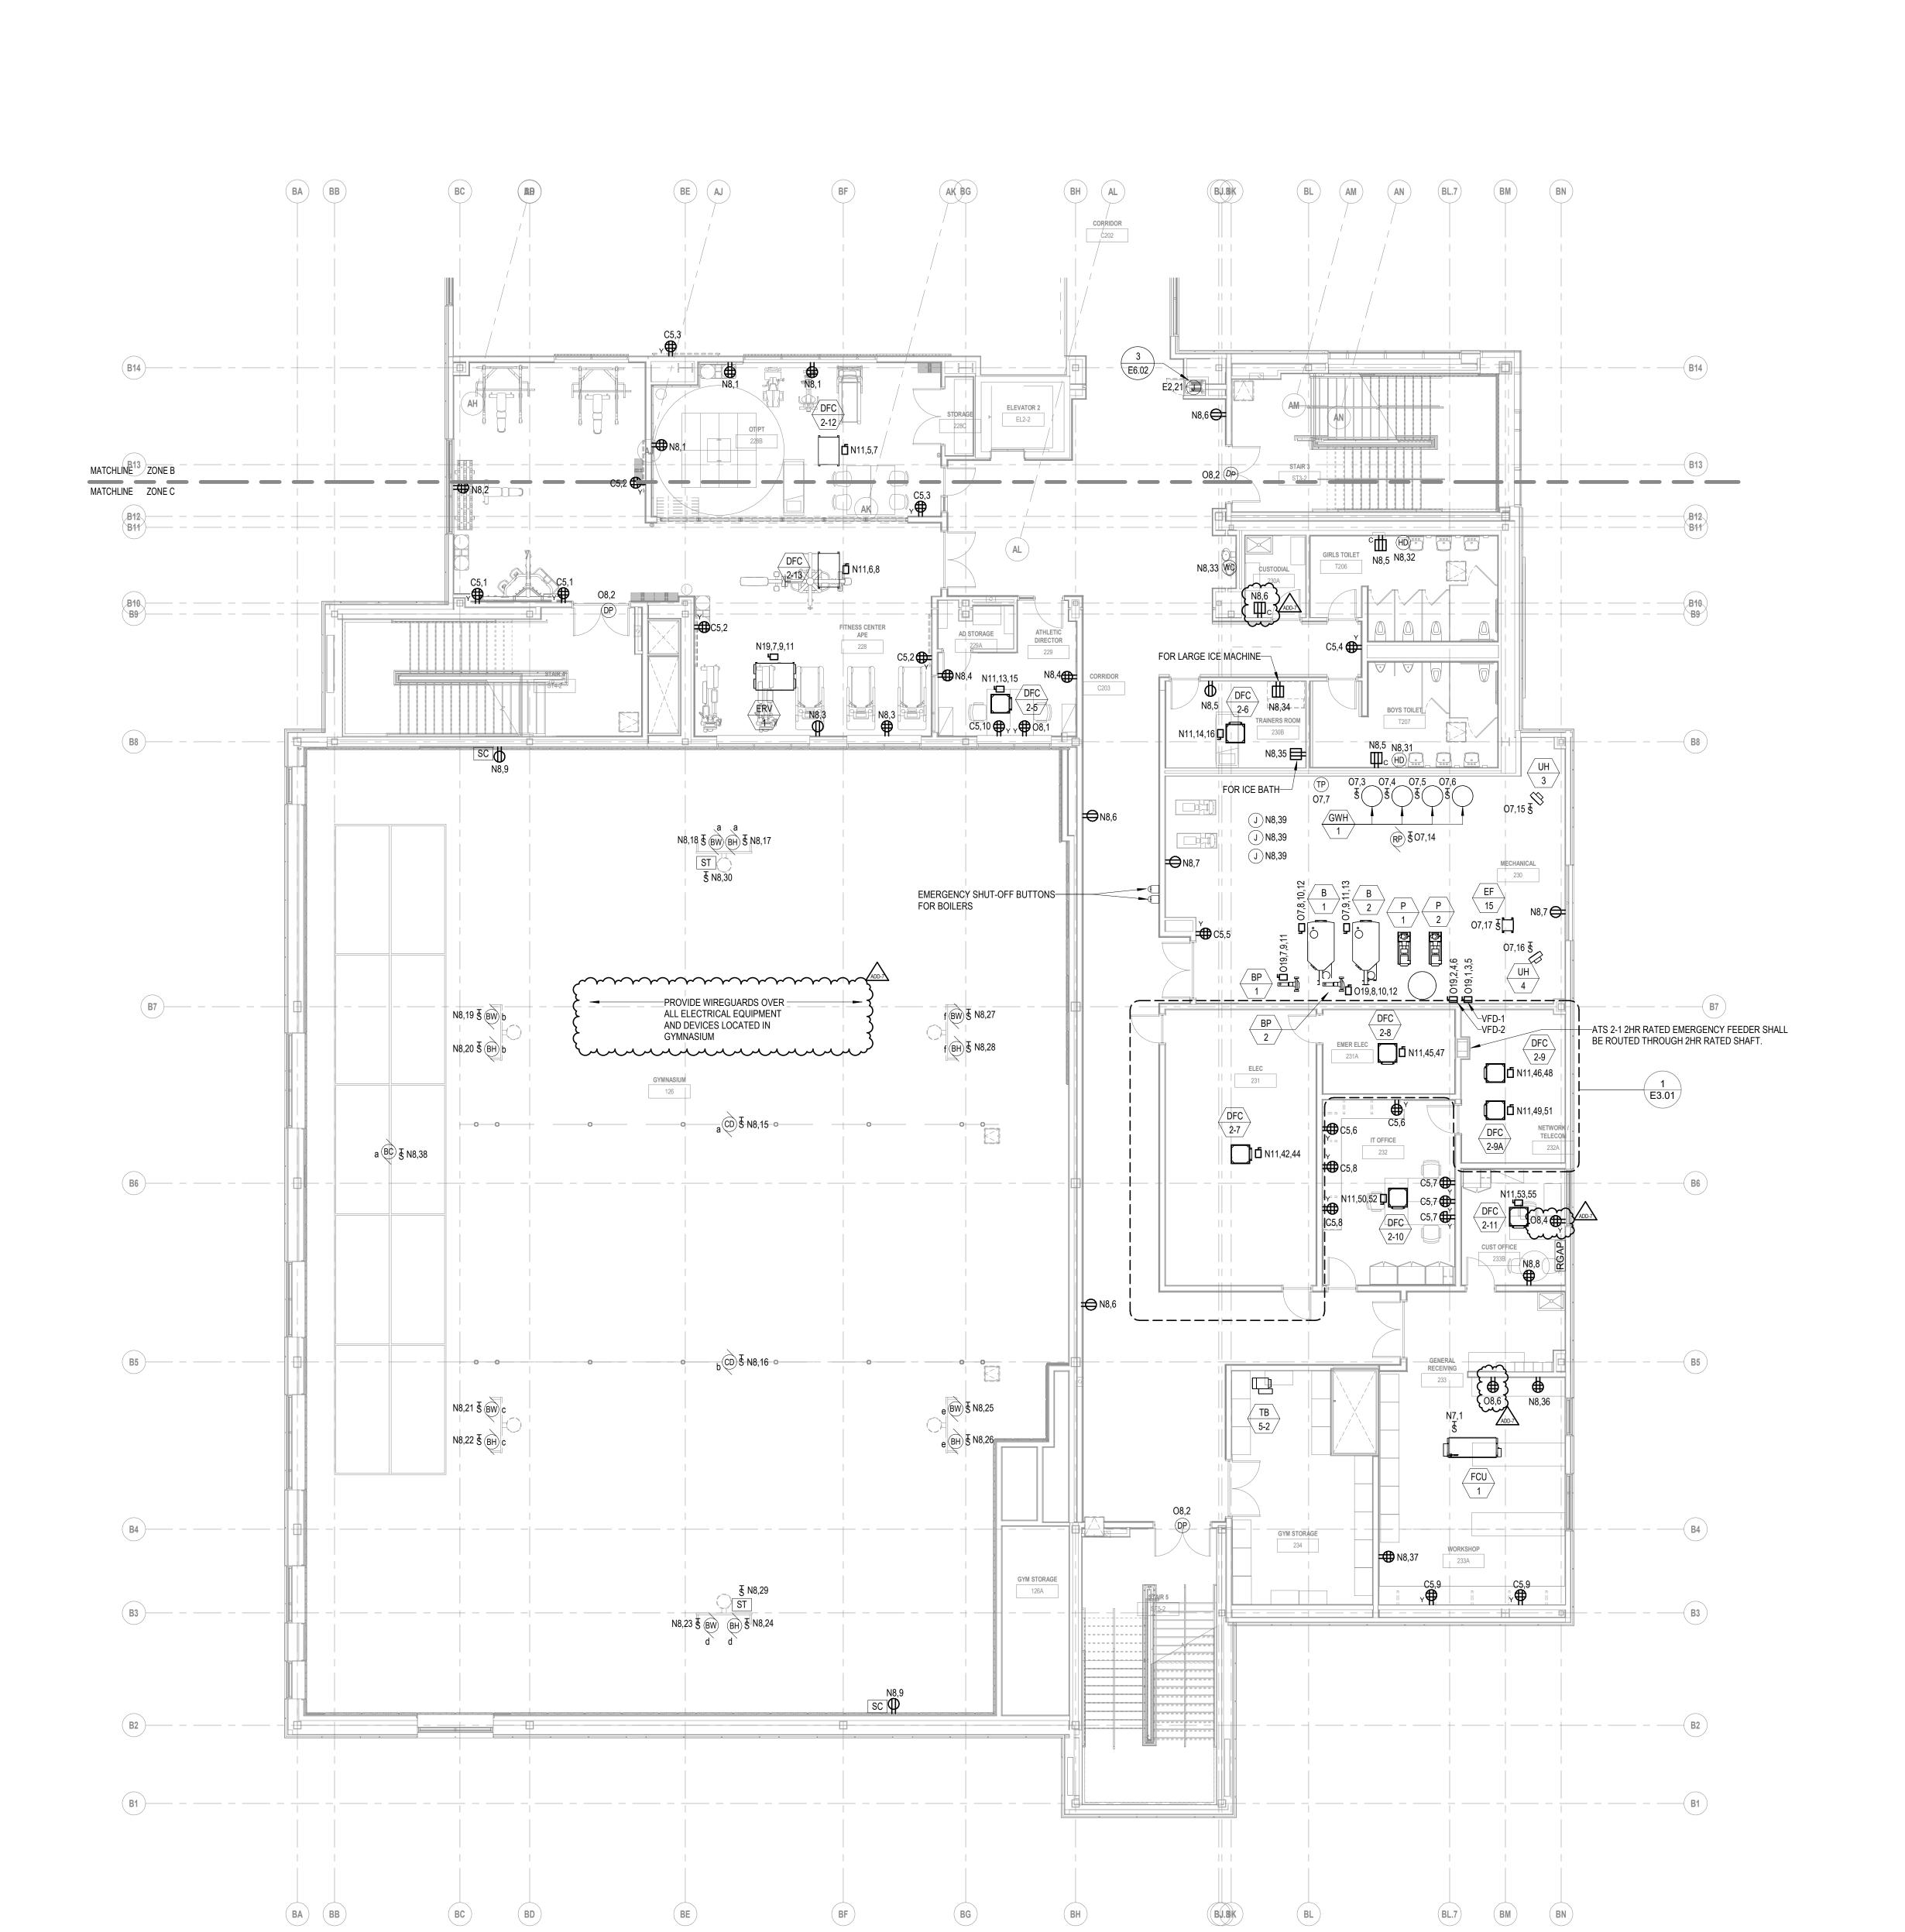

BC

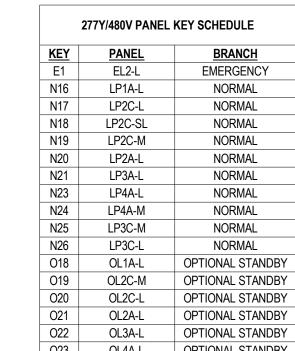

277Y/480V PANEL KEY SCHEDULE			
KEY	PANEL	BRANCH	
E1	EL2-L	EMERGENCY	
N16	LP1A-L	NORMAL	
N17	LP2C-L	NORMAL	
N18	LP2C-SL	NORMAL	
N19	LP2C-M	NORMAL	
N20	LP2A-L	NORMAL	
N21	LP3A-L	NORMAL	
N23	LP4A-L	NORMAL	
N24	LP4A-M	NORMAL	
N25	LP3C-M	NORMAL	
N26	LP3C-L	NORMAL	
O18	OL1A-L	OPTIONAL STANDE	
O19	OL2C-M	OPTIONAL STANDE	
O20	OL2C-L	OPTIONAL STANDE	
O21	OL2A-L	OPTIONAL STANDE	
022	OL3A-L	OPTIONAL STANDE	
023	OL4A-L	OPTIONAL STANDE	
O25	OL3C-L	OPTIONAL STANDE	

208Y/120V PANEL KEY SCHEDULE					
KEY	PANEL NAME	BRANCH			
E2	EP2-R	EMERGENCY			
C1	CP1A	NORMAL			
C2	CP1C	NORMAL			
C4	CP2A	NORMAL			
C5	CP2C	NORMAL			
C6	CP3A	NORMAL			
C7	CP3C	NORMAL			
C8	CP4A	NORMAL			
N1	PP1A-R	NORMAL			
N2	PP1A-M	NORMAL			
N3	PP1C-M	NORMAL			
N4	PP1C-R	NORMAL			
N5	PP2A-M	NORMAL			
N6	PP2A-R	NORMAL			
N7	PP2C-M	NORMAL			
N8	PP2C-R	NORMAL			
N10	PP3A-R	NORMAL			
N11	PP3C-M	NORMAL			
N12	PP3C-R	NORMAL			
N13	PP4A-M	NORMAL			
N14	PP4A-R	NORMAL			
N15	KP1B	NORMAL			
N27	PP1A-RBT	NORMAL			
01	OP1A-R	OPTIONAL STANDE			
02	OP1A-M	OPTIONAL STANDB			
O3	OP1C-M	OPTIONAL STANDB			
04	OP1C-R	OPTIONAL STANDB			
O6	OP2A-R	OPTIONAL STANDB			
07	OP2C-M	OPTIONAL STANDB			
08	OP2C-R	OPTIONAL STANDB			
O10	OP3A-R	OPTIONAL STANDB			
011	OP3C-L	OPTIONAL STANDB			
012	OP3C-M	OPTIONAL STANDE			
013	OP3C-R	OPTIONAL STANDE			
015	OP4A-R	OPTIONAL STANDS			
016	OKP1B	OPTIONAL STANDE			
017	OMDF	OPTIONAL STANDE			

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GENERAL NOTES:

ELECTRICAL SUBCONTRACTOR SHALL WIRE ALL TERMINAL BOXES SHOWN ON THIS DRAWING TO N7,2.

ADDENDUM 6 100% CONSTRUCTION DOCUMENTS KEY PLAN NORTH ARROW |

KEYPLAN

DRAWING NAME: ELECTRICAL SECOND FLOOR POWER PLAN -**ZONE C**

RBC/JAJ DRAWN BY: REVIEWED BY: RCB SCALE: AS NOTED | DRAWING NUMBER: JOB NO.: 2202.02 E2.12C

1 SECOND FLOOR POWER PLAN - ZONE C

BL.7

BJ.BK

BL


	AA	AB	AC	AD	AE	MATCHLINE ZONE A MATCHLINE ZONE B MATCHLINE ZONE B
A6 — — — — — — — — — — — — — — — — — — —		TB 1-17 III	C6,1 C6,2 N10	A7 C6,2 C6,3 TB TB 1-21 N10,2 N10,2 CASSROOM	G N10,72 BP C6,29 C6,26 C6,26 N10,51 N10,2	C6,10 C6,10
A4 — — — — — — —	O10,1	N10.1 C()ASSROOM Side of the control of the contr	C6,1 TB 1-19 N10,1 N10,2 N10,2 N10,4 GROUP A C6,21 A C6,21	₩N10,3 W10,2 N10,2 N10,8 CORRIDOR C3300 CORRIDOR C3300	DFC 307 N13,29,31 N13,29,31	C6,30 C6,24 N10,42 N10,142 N10,142 N10,142 N10,144 N10,144 N10,15
A3 — — — — — — —		C6,20 N10,5	N40	DFC 3-1 N13,21,23	CUSTODIAL STORAGE N40.43	C6,20 CLASSROOM 312
A2 — — — — — — —		C6,5 N10,44		C6,7 MLL 304 N10,6 N10,9 N10,69 N10,99	N10,9 N10,11 N10,40 HD	N10,44 N10,44 C66,11
A1 — — — — — — —			C6,5 C6,6		GIRLS TOTLET T302 T302	C6,12 BC A1
	AA	AB	AC	AD	AE	AF BA BB AG BC

:	277Y/480V PANE	L KEY SCHEDULE
KEY	PANEL	BRANCH
E1	EL2-L	EMERGENCY
N16	LP1A-L	NORMAL
N17	LP2C-L	NORMAL
N18	LP2C-SL	NORMAL
N19	LP2C-M	NORMAL
N20	LP2A-L	NORMAL
N21	LP3A-L	NORMAL
N23	LP4A-L	NORMAL
N24	LP4A-M	NORMAL
N25	LP3C-M	NORMAL
N26	LP3C-L	NORMAL
O18	OL1A-L	OPTIONAL STANDBY
019	OL2C-M	OPTIONAL STANDBY
O20	OL2C-L	OPTIONAL STANDBY
021	OL2A-L	OPTIONAL STANDBY
O22	OL3A-L	OPTIONAL STANDBY
O23	OL4A-L	OPTIONAL STANDBY
O25	OL3C-L	OPTIONAL STANDBY





KEY	PANEL NAME	BRANCH
E2	EP2-R	EMERGENCY
C1	CP1A	NORMAL
C2	CP1C	NORMAL
C4	CP2A	NORMAL
C5	CP2C	NORMAL
C6	CP3A	NORMAL
C7	CP3C	NORMAL
C8	CP4A	NORMAL
N1	PP1A-R	NORMAL
N2	PP1A-M	NORMAL
N3	PP1C-M	NORMAL
N4	PP1C-R	NORMAL
N5	PP2A-M	NORMAL
N6	PP2A-R	NORMAL
N7	PP2C-M	NORMAL
N8	PP2C-R	NORMAL
N10	PP3A-R	NORMAL
N11	PP3C-M	NORMAL
N12	PP3C-R	NORMAL
N13	PP4A-M	NORMAL
N14	PP4A-R	NORMAL
N15	KP1B	NORMAL
N27	PP1A-RBT	NORMAL
01	OP1A-R	OPTIONAL STANDE
02	OP1A-M	OPTIONAL STANDE
O3	OP1C-M	OPTIONAL STANDE
04	OP1C-R	OPTIONAL STANDE
06	OP2A-R	OPTIONAL STANDE
07	OP2C-M	OPTIONAL STANDE
08	OP2C-R	OPTIONAL STANDE
010	OP3A-R	OPTIONAL STANDE
011	OP3C-L	OPTIONAL STANDE
012	OP3C-M	OPTIONAL STANDE
013	OP3C-R	OPTIONAL STANDE
015	OP4A-R	OPTIONAL STANDE
O16	OKP1B	OPTIONAL STANDE
017	OMDF	OPTIONAL STANDE

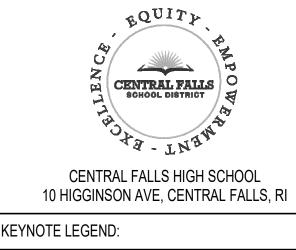

KEYNOTE LEGEND:	
GENERAL NOTES:	


1. ELECTRICAL SUBCONTRACTOR SHALL WIRE ALL TERMINAL BOXES SHOWN ON THIS DRAWING TO N2,1.

ADD-7 ADDENDUM 7 1/26/2024

100% CONSTRUCTION DOCUMENTS

KEY PLAN NORTH ARROW

KEYPLAN

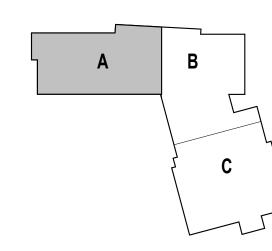

ELECTRICAL

THIRD FLOOR
POWER PLAN ZONE A

		2011	- / \
	DRAWN B	Y :	RBC/JAJ
	REVIEWE	D BY:	RCB
	SCALE:	AS NOTED	DRAWING NUMBER:
	JOB NO.:	2202.02	F2 13A
	DATE: C	OCTOBER 13, 2023	LZ. 10/\

1 THIRD FLOOR POWER PLAN - ZONE A

1/8" = 1'-0"

	MATCHLINE ZONE A MATCHLINE ZONE B MATCHLINE ZONE B	AH	AJ	AK	AL	AM AN	
A7 — — — — — — — — — — — — — — — — — — —	C6,10 N10,14 C C6,13 CR N10,73 C C6,13 CR N10,34	CR (CR) (CR) (CR) (CR) (CR) (CR) (CR) (C	3) LBP 6,25	A7	N10,52 N10,53 CR CR CR J	N10,54 CR C6,16	
A4 ————————————————————————————————————	N10,14 N10,14 COLLABORATION C300A	PHYSICAL SCIENCE 311 ADD-7 N10 ADD-7 N10 N10,8	MEDIA COMMONS 313	C6,18 STAIR 2 C6,8 ODP O10,1	TB 2-22 ART 315 N10,59 CR	N10,58 CR	
A3 — — —		N10,13 N10,19 N10,19 N10,19 N10,19 N10,19	TB C6,14 3-29 MEDIA OFFICE BG ELEVATO C6,19 C6,	CORRIDOR C301	TB N10,60 2-23 CR N10,63 CR N10,63 CR N10,48	N10,61 BM BN N10,62 CR CR	
A1 ————————————————————————————————————	C6,11 C6,12 BC	C6,12 C6,14 TEAC PLAN 31 C6,12 WP N10,18 S N10,18 BE N10,18 S N10,18 WP N10,43	TB 3-30 BF C6,15 N10,20 MOTHERS ROOM 314C N10,20	ART KILN 317B J N10,38 N10,45,47,49	100 111 111	C6,17 (CR) N10,22	B15
B15	BA BB AG		ROOF TERRACE 319	N10,50 P	N10,7 ELEV 2 CTRL ROOM 320	AM AN AN STAIR 3	B13 B12 B11 B10 B9
	B14 B13 B12 BA1 BB	BC BD	AJ B10 B9 BE	N10,50 PF	CORRIDOR C302 BB BB BB	(HD) (HD) (HD) (HD) (HD)	BL.7 BM BN

KEY	PANEL	BRANCH
E1	EL2-L	EMERGENCY
N16	LP1A-L	NORMAL
N17	LP2C-L	NORMAL
N18	LP2C-SL	NORMAL
N19	LP2C-M	NORMAL
N20	LP2A-L	NORMAL
N21	LP3A-L	NORMAL
N23	LP4A-L	NORMAL
N24	LP4A-M	NORMAL
N25	LP3C-M	NORMAL
N26	LP3C-L	NORMAL
O18	OL1A-L	OPTIONAL STANDBY
O19	OL2C-M	OPTIONAL STANDBY
O20	OL2C-L	OPTIONAL STANDBY
O21	OL2A-L	OPTIONAL STANDBY
O22	OL3A-L	OPTIONAL STANDBY
O23	OL4A-L	OPTIONAL STANDBY
O25	OL3C-L	OPTIONAL STANDBY

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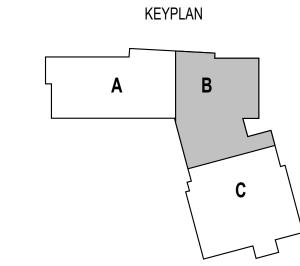
	208Y/120V PANEL	KEY SCHEDULE
KEY	PANEL NAME	BRANCH
E2	EP2-R	EMERGENCY
C1	CP1A	NORMAL
C2	CP1C	NORMAL
C4	CP2A	NORMAL
C5	CP2C	NORMAL
C6	CP3A	NORMAL
C7	CP3C	NORMAL
C8	CP4A	NORMAL
N1	PP1A-R	NORMAL
N2	PP1A-M	NORMAL
N3	PP1C-M	NORMAL
N4	PP1C-R	NORMAL
N5	PP2A-M	NORMAL
N6	PP2A-R	NORMAL
N7	PP2C-M	NORMAL
N8	PP2C-R	NORMAL
N10	PP3A-R	NORMAL
N11	PP3C-M	NORMAL
N12	PP3C-R	NORMAL
N13	PP4A-M	NORMAL
N14	PP4A-R	NORMAL
N15	KP1B	NORMAL
N27	PP1A-RBT	NORMAL
01	OP1A-R	OPTIONAL STANDBY
02	OP1A-M	OPTIONAL STANDBY
O3	OP1C-M	OPTIONAL STANDBY
04	OP1C-R	OPTIONAL STANDBY
06	OP2A-R	OPTIONAL STANDBY
07	OP2C-M	OPTIONAL STANDBY
08	OP2C-R	OPTIONAL STANDBY
010	OP3A-R	OPTIONAL STANDBY
011	OP3C-L	OPTIONAL STANDBY
012	OP3C-M	OPTIONAL STANDBY
013	OP3C-R	OPTIONAL STANDBY
O15	OP4A-R	OPTIONAL STANDBY
O16	OKP1B	OPTIONAL STANDBY
017	OMDF	OPTIONAL STANDBY

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ИAL		-				
ИAL		KEYN	IOTE LEGEND:			
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ИAL	1					
ИAL		GENI	GENERAL NOTES:			
ИAL						
ИAL		1.	ELECTRICAL SUBCONTRACTOR SHALL WIRE ALL			
ИAL			TERMINAL BOXES SHOWN ON THIS DRAWING TO N2,1.			
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ADD-7 ADDENDUM 7 1/26/2024

100% CONSTRUCTION DOCUMENTS


KEY PLAN NORTH ARROW




ELECTRICAL
THIRD FLOOR
POWER PLAN ZONE B

	2011	
DRAWN BY:		RBC/JA
REVIEWED B'	Y:	RCE
SCALE:	AS NOTED	DRAWING NUMBER:
JOB NO.:	2202.02	F2 13R
DATE: OCT	OBER 13, 2023	

1 THIRD FLOOR POWER PLAN - ZONE B
1/8" = 1'-0"

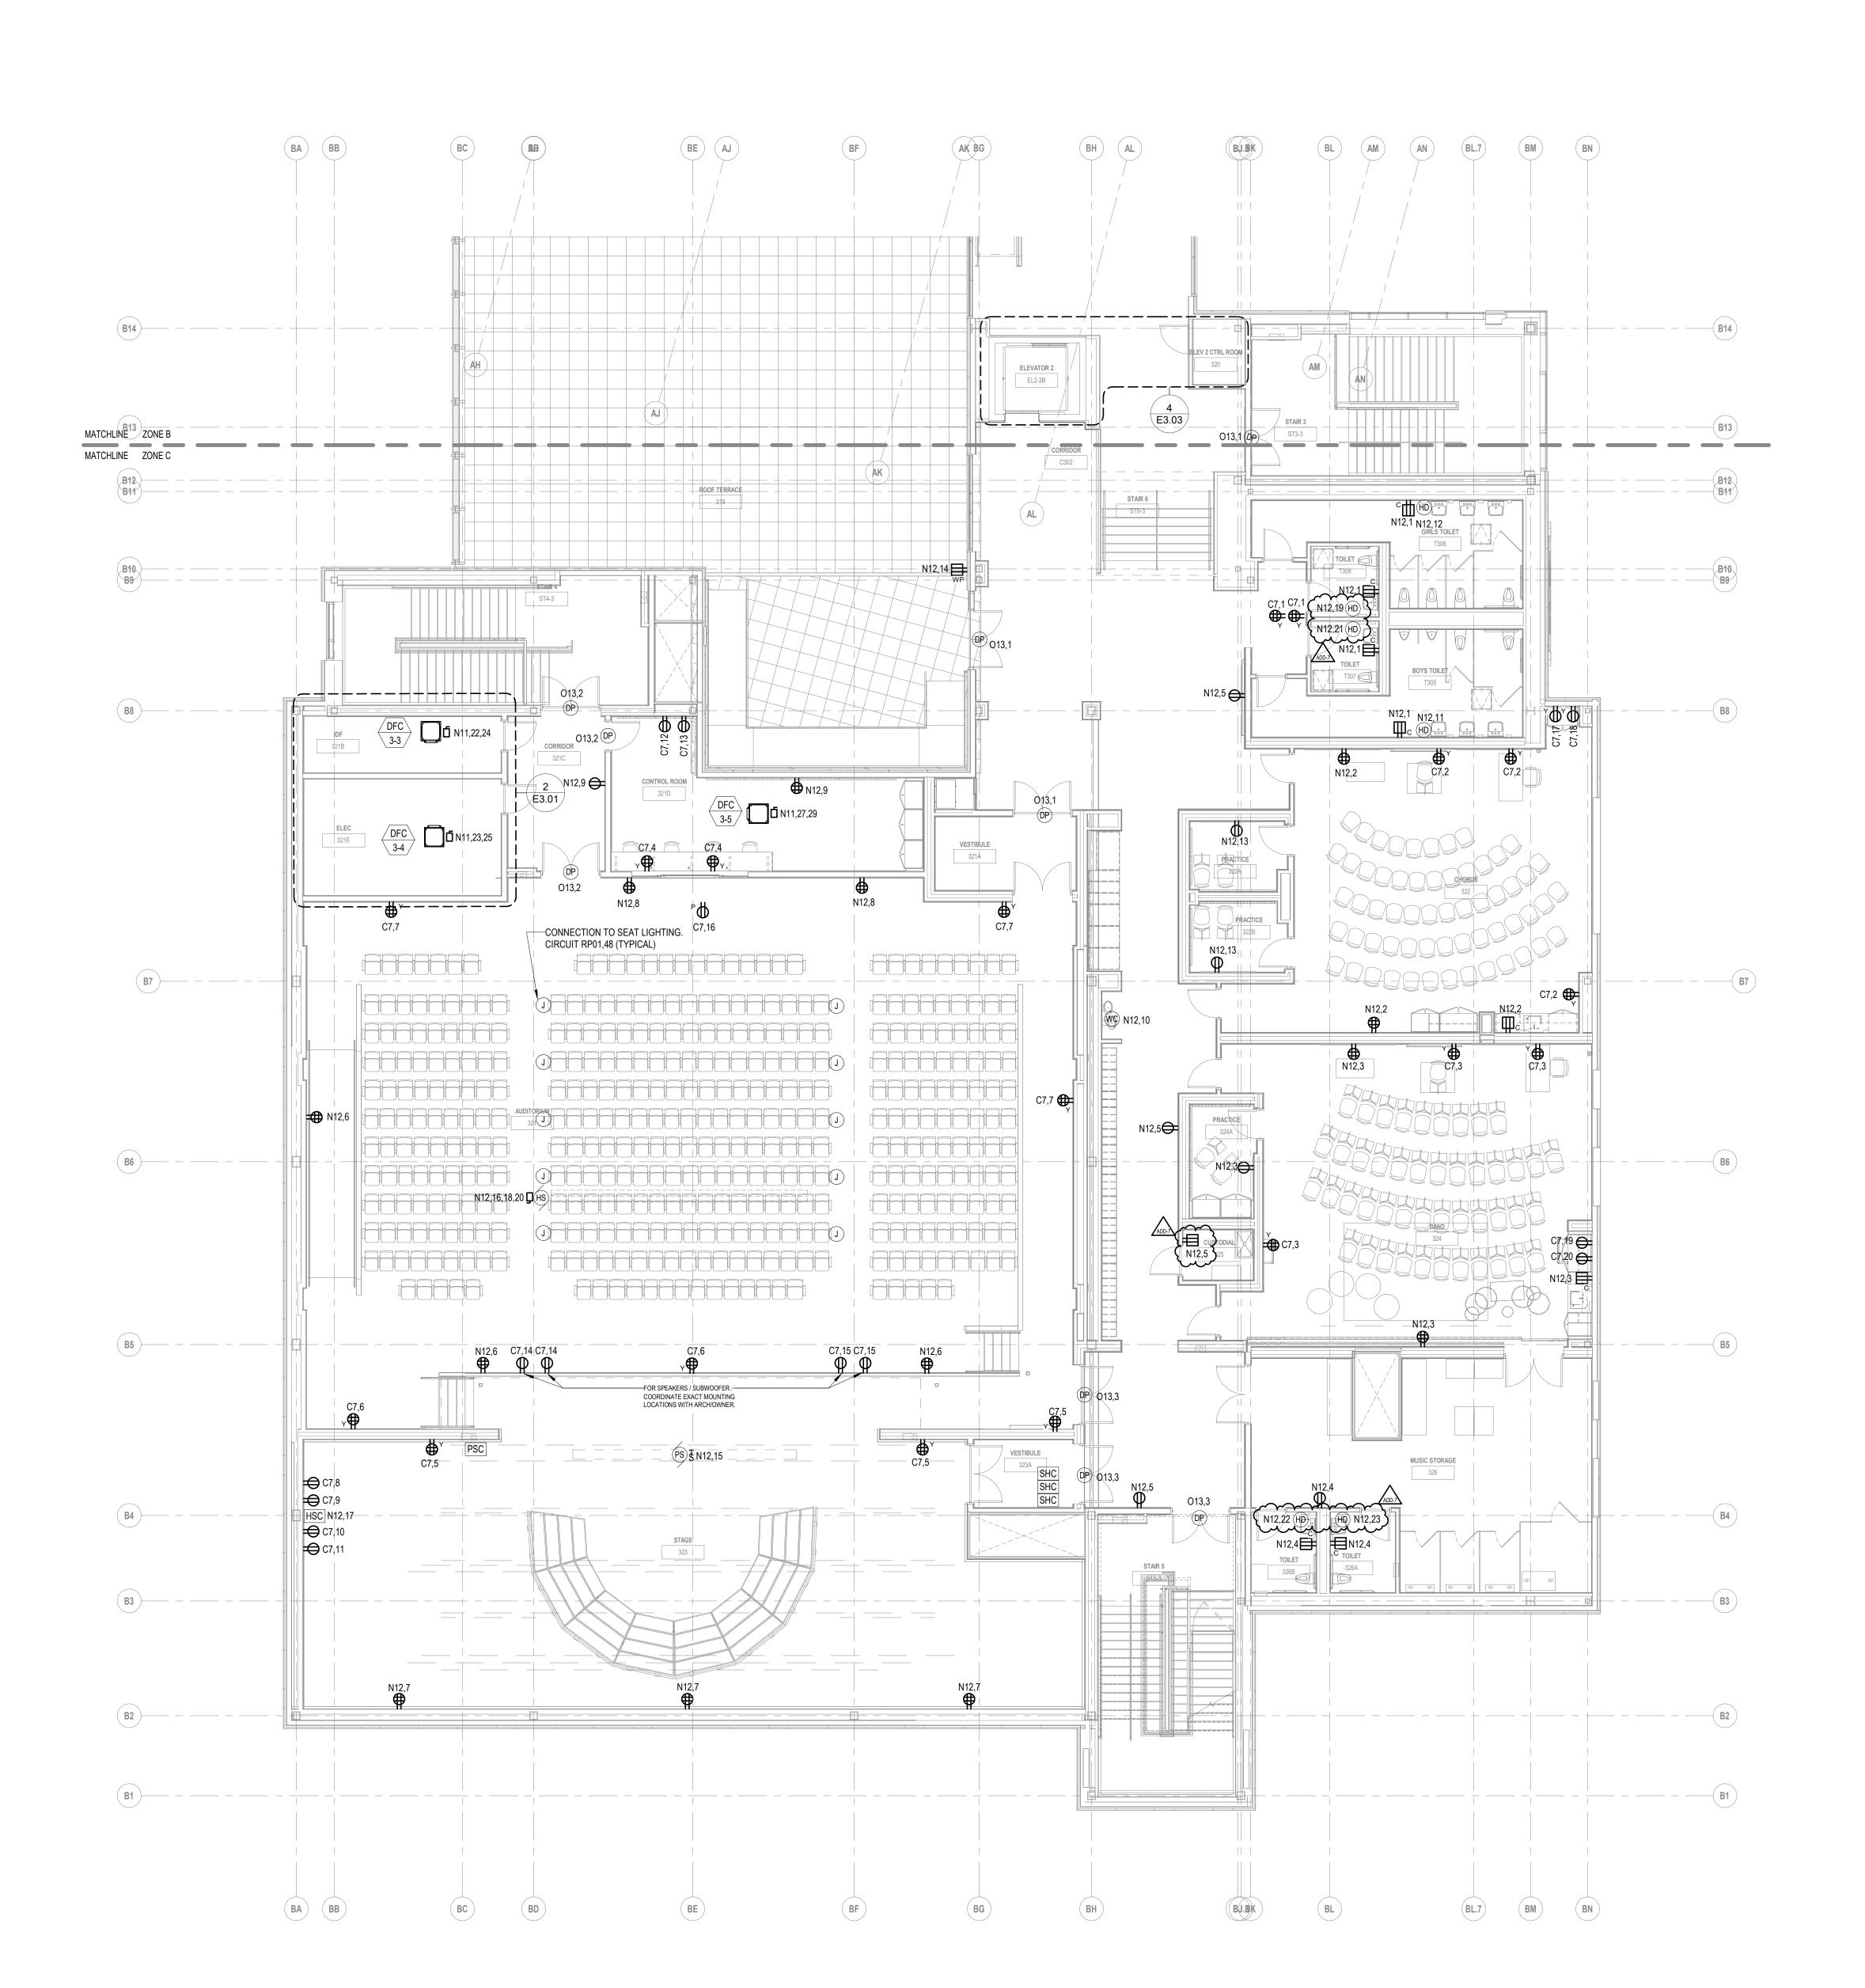

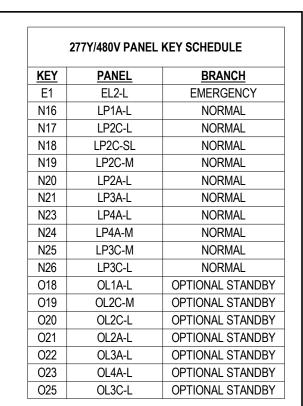





	208Y/120V PANEL	KEY SCHEDULE	
<u>KEY</u>	PANEL NAME	BRANCH	
E2	EP2-R	EMERGENCY	
C1	CP1A	NORMAL	
C2	CP1C	NORMAL	
C4	CP2A	NORMAL	
C5	CP2C	NORMAL	
C6	CP3A	NORMAL	
C7	CP3C	NORMAL	
C8	CP4A	NORMAL	
N1	PP1A-R	NORMAL	
N2	PP1A-M	NORMAL	
N3	PP1C-M	NORMAL	
N4	PP1C-R	NORMAL	
N5	PP2A-M	NORMAL	
N6	PP2A-R	NORMAL	
N7	PP2C-M	NORMAL	
N8	PP2C-R	NORMAL	
N10	PP3A-R	NORMAL	
N11	PP3C-M	NORMAL	
N12	PP3C-R	NORMAL	
N13	PP4A-M	NORMAL	
N14	PP4A-R	NORMAL	
N15	KP1B	NORMAL	
N27	PP1A-RBT	NORMAL	
01	OP1A-R	OPTIONAL STANDBY	
02	OP1A-M	OPTIONAL STANDBY	
O3	OP1C-M	OPTIONAL STANDBY	
04	OP1C-R	OPTIONAL STANDBY	
O6	OP2A-R	OPTIONAL STANDBY	
07	OP2C-M	OPTIONAL STANDBY	
O8	OP2C-R	OPTIONAL STANDBY	
O10	OP3A-R	OPTIONAL STANDBY	
011	OP3C-L	OPTIONAL STANDBY	
012	OP3C-M	OPTIONAL STANDBY	
O13	OP3C-R	OPTIONAL STANDBY	
O15	OP4A-R	OPTIONAL STANDBY	
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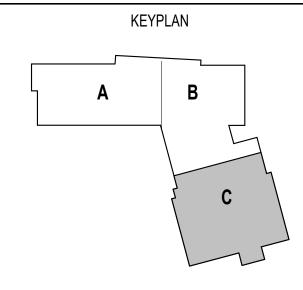
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		KEYNOTE LEGEND:
		GENERAL NOTES:
		ELECTRICAL SUBCONTRACTOR SHALL WIRE ALL TERMINAL BOXES SHOWN ON THIS DRAWING TO N2,1.

O2 OP1A-M OPTIONAL STANDBY
O3 OP1C-M OPTIONAL STANDBY
O4 OP1C-R OPTIONAL STANDBY
O6 OP2A-R OPTIONAL STANDBY
O7 OP2C-M OPTIONAL STANDBY
O8 OP2C-R OPTIONAL STANDBY
O10 OP3A-R OPTIONAL STANDBY
O11 OP3C-L OPTIONAL STANDBY
O12 OP3C-M OPTIONAL STANDBY
O13 OP3C-R OPTIONAL STANDBY
O15 OP4A-R OPTIONAL STANDBY
O16 OKP1B OPTIONAL STANDBY
O17 OMDF OPTIONAL STANDBY

ADD-7 ADDENDUM 7 1/26/2024

100% CONSTRUCTION DOCUMENTS

KEY PLAN NORTH ARROW



DRAWING NAME:

ELECTRICAL

THIRD FLOOR

POWER PLAN
70NF C

	ZONLO					
	DRAWN	BY:		RBC/JAJ		
	REVIEW	ED BY:		RCB		
	SCALE:		AS NOTED	DRAWING NUMBER:		
	JOB NO.	:	2202.02	F2 13C		
	DATE:	OCTOB	ER 13, 2023			

					E1	EL2-L	EMERGENCY
					N16	LP1A-L	NORMAL
					N17	LP2C-L	NORMAL
					N18	LP2C-SL	NORMAL
					N19	LP2C-M	NORMAL
					N20	LP2A-L	NORMAL
					N21	LP3A-L	NORMAL
					N23	LP4A-L	NORMAL
					N24	LP4A-M	NORMAL
					N25	LP3C-M	NORMAL
					N26	LP3C-L	NORMAL
					O18	OL1A-L	OPTIONAL STANDBY
					O19	OL2C-M	OPTIONAL STANDBY
					O20 O21	OL2C-L	OPTIONAL STANDBY
						OL2A-L	OPTIONAL STANDBY
					022	OL3A-L	OPTIONAL STANDBY
					O23 O25	OL4A-L	OPTIONAL STANDBY OPTIONAL STANDBY
					UZ5	OL3C-L	OPTIONAL STANDBY
AC	AD	AE	AF	AG			

	208Y/120V PANEL KEY SCHEDULE					
<u>KEY</u>	PANEL NAME	BRANCH				
E2	EP2-R	EMERGENC				
C1	CP1A	NORMAL				
C2	CP1C	NORMAL				
C4	CP2A	NORMAL				
C5	CP2C	NORMAL				
C6	CP3A	NORMAL				
C7	CP3C	NORMAL				
C8	CP4A	NORMAL				
N1	PP1A-R	NORMAL				
N2	PP1A-M	NORMAL				
N3	PP1C-M	NORMAL				
N4	PP1C-R	NORMAL				
N5	PP2A-M	NORMAL				
N6	PP2A-R	NORMAL				
N7	PP2C-M	NORMAL				
N8	PP2C-R	NORMAL				
N10	PP3A-R	NORMAL				
N11	PP3C-M	NORMAL				
N12	PP3C-R	NORMAL				
N13	PP4A-M	NORMAL				
N14	PP4A-R	NORMAL				
N15	KP1B	NORMAL				
N27	PP1A-RBT	NORMAL				
01	OP1A-R	OPTIONAL STAN				
02	OP1A-M	OPTIONAL STAN				
03	OP1C-M	OPTIONAL STAN				
04	OP1C-R	OPTIONAL STAN				
06	OP2A-R	OPTIONAL STAN				
07	OP2C-M	OPTIONAL STAN				
08	OP2C-R	OPTIONAL STAN				
010	OP3A-R	OPTIONAL STAN				
011	OP3C-L	OPTIONAL STAN				
012	OP3C-M	OPTIONAL STAN				
013	OP3C-R	OPTIONAL STAN				
015	OP4A-R	OPTIONAL STAN				
O16	OKP1B	OPTIONAL STAN				
017	OMDF	OPTIONAL STAN				

277Y/480V PANEL KEY SCHEDULE

	5
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CENTRAL FALLS HIGH SCHOOL 10 HIGGINSON AVE, CENTRAL FALLS, RI
<u> </u>

KEYNOTE LEGEND:

GENERAL NOTES:


1. ELECTRICAL SUBCONTRACTOR SHALL WIRE ALL TERMINAL BOXES SHOWN ON THIS DRAWING TO N2,1.

ADD-7 ADDENDUM 7 1/26/2024

100% CONSTRUCTION DOCUMENTS

KEY PLAN NORTH ARROW

KEYPLAN

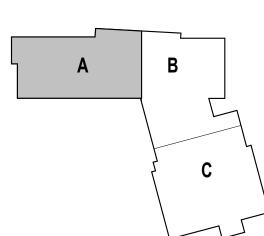

DRAWING NAME:

ELECT


1 FOURTH FLOOR POWER PLAN - ZONE A
1/8" = 1'-0"

ELECTRICAL FOURTH FLOOR POWER PLAN -ZONE A

		ZONI	
	DRAWN BY	··	RBC/JAJ
	REVIEWED	BY:	RCB
	SCALE:	AS NOTED	DRAWING NUMBER:
	JOB NO.:	2202.02	F2.14A
١	DATE: O	CTOBER 13, 2023	

		AB AC I	AD	AE	MATCHLINE ZONE A MATCHLINE ZONE B MATCHLINE ZONE B
A6 — — — — — — — — — — — — — — — — — — —		C8,2 C8,1 C8,3 N14,22	C8,3	C8,24 C8,30 C8,24 C8,30 C8,24 C8,30 C8,24 C8,30 C8,24 C8,30 C8,24 C8,25 N14,44 N14,25 N14,26 C8,25 N14,44 N14,25 CR C8,25 N14,44 N14,25 CR C8,25 N14,26 CR C8,25 N14,26 CR C8,25 CR C8,26 CR C8,27 CR C8,28	N14,8 C8,7 N14,8 C8,7 N14,8 C8,7 N14,8 C8,7 N14,8 C8,8 N14,8 C8,7 N14,8 C8,7 N14,8 C8,7 N14,8 C8,7
A4 — — — — —	STAR 1 STAR 1 ODP O15,1	C8,2 C8,2 C8,2 N14,42 N14,42 N14,42 N14,15	CLASSROOM N14,2 N14,3 TB 1-28	N14,3 (C8,26) (C8,31) (C8,21)	N14,7 (bW) N14,52
A3 — — — — —	1-2	B 24	CORRIDOR C400 DFC 4-1 N14,5	F3.01	C8,21 C8,21 C8,21 C8,16
A2 — — — — —		C8,5 N14,23 CLASSROOM CLASSROOM CLASSROOM CR.5 CR.5	CLASSROOM 404 CRACE C	CTE (COMMUNITY LAW & ADVOCACY) 310 N14,51 HD N14,51 HD GIRLS TOPLET 1802	₩N14,17
A1 — — — —		AB	AD	AE	BA BB AG BC

	AF	(AH)	$\overline{\left(\mathbf{AJ} \right)}$	AK	AL	(AM) (AN)	
	MATCHLINE ZONE A MATCHLINE ZONE B						
(A7)——							
A6	N14,8 C8,8 C8,8	C8,2	C8,28	C8,22	C8,11 Diverse	N14,39	
(A5)	TB C8,7 N14,8 C N14,50	N14,20	C8,29 C8,9 N14,20		(SPEECH) 4 TB 3-41 TB C8,10	CORRIDOR CA01A CORRIDOR CA01A CORRIDOR CA01A	
	N14,7	N14,37 N14,36 CR CHEMISTRY	C8,29 N14,40		3-38 DIVERSE EARNERS N14-CHIEFENCE N14-TI	CORRIDOR C401A N14,12 CMBming RSQN, 12 3-39 21 N14,12	
A4		(015,14) (SV) (114,24) (C8,27 N14,10 C8,27 N14)	2-28 TB 2-33 A3 A	STAIR 2 ST2-4 C8,22 Y	©8,10 WN14,11 D15,1	N14,12 TB 3-37	
	COLLABORATION C400A C8,21	N14,15	TB 2-31 CORRIDOR G401	N14,15	O15,1 DP	3-36 AL WORKER 11 12 11 11 11 11 11 11 11 11 11 11 11	
A3	C8,16	₩N14,18	SMALL GROUP 412A TB C8,18 ELEV 1 CTRL ROOM 416 C8,18	T ELEVATOR 1	N14,39 CHEM STORAGE 418	SRO OFFICE BN SRO OFFICE BN O15,12 O15,12 O15,13	
(A2)		CLASSROOM (NEWCOMERS) CLASSROOM (NEWCOMERS) A12 N14,21	C8,18 C8,17 C8,19	BH	N14,19 BU.BU.BU.BU.BU.BU.BU.BU.BU.BU.BU.BU.BU.B	015,12 0.15,13 N14,13 TB SOQIABUSGEVER	
	C8,16 (C8,16 (C8,16) (C8,16 (C8,16 (C8,16) (C8,16 (C8,16) (C8,16 (C8,16) (C8,16 (C8,16) (C8,16) (C8,16 (C8,16) (TB 2-30	N14,18 N14,19 CTE (TEAC ACADEM ACAD	N14,21	C8,14	G) \	B15
(A1)	BC CO, 10 C	BE		2-34	N14,14	ONERSE 3-33 FARNERS WHAT A STATE OF THE STA	— — — — — — — — — — — — — — — — — — —
	BA BB						
							B14
	AF					AM	B13 B12 B11
(B15)							B10 B9
						T WP	
	B14	AH	AJ	AK	AL		B8

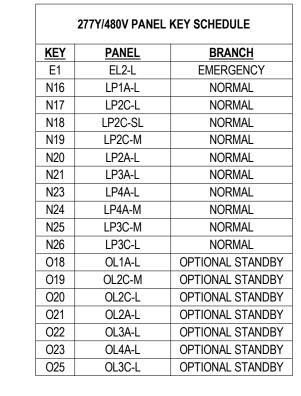

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ELECTRICAL SUBCONTRACTOR SHALL WIRE ALL
TERMINAL BOXES SHOWN ON THIS DRAWING TO N2,1.

KEYNOTE LEGEND:


GENERAL NOTES:

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208Y/120V PANEL KEY SCHEDULE						
<u>KEY</u>	PANEL NAME	<u>BRANCH</u>				
E2	EP2-R	EMERGENCY				
C1	CP1A	NORMAL				
C2	CP1C	NORMAL				
C4	CP2A	NORMAL				
C5	CP2C	NORMAL				
C6	CP3A	NORMAL				
C7	CP3C	NORMAL				
C8	CP4A	NORMAL				
N1	PP1A-R	NORMAL				
N2	PP1A-M	NORMAL				
N3	PP1C-M	NORMAL				
N4	PP1C-R	NORMAL				
N5	PP2A-M	NORMAL				
N6	PP2A-R	NORMAL				
N7	PP2C-M	NORMAL				
N8	PP2C-R	NORMAL				
N10	PP3A-R	NORMAL				
N11	PP3C-M	NORMAL				
N12	PP3C-R	NORMAL				
N13	PP4A-M	NORMAL				
N14	PP4A-R	NORMAL				
N15	KP1B	NORMAL				
N27	PP1A-RBT	NORMAL				
01	OP1A-R	OPTIONAL STANDB				
02	OP1A-M	OPTIONAL STANDB				
03	OP1C-M	OPTIONAL STANDBY				
04	OP1C-R	OPTIONAL STANDBY				
06	OP2A-R	OPTIONAL STANDBY				
07	OP2C-M	OPTIONAL STANDB				
08	OP2C-R	OPTIONAL STANDBY				
010	OP3A-R	OPTIONAL STANDB				
011	OP3C-L	OPTIONAL STANDB				
012	OP3C-M	OPTIONAL STANDB				
013	OP3C-R	OPTIONAL STANDB				
015	OP4A-R	OPTIONAL STANDB				
016	OKP1B	OPTIONAL STANDBY				
017	OMDF	OPTIONAL STANDBY				

C1	CP1A	NORMAL
C2	CP1C	NORMAL
C4	CP2A	NORMAL
C5	CP2C	NORMAL
C6	CP3A	NORMAL
C7	CP3C	NORMAL
C8	CP4A	NORMAL
N1	PP1A-R	NORMAL
N2	PP1A-M	NORMAL
N3	PP1C-M	NORMAL
N4	PP1C-R	NORMAL
N5	PP2A-M	NORMAL
N6	PP2A-R	NORMAL
N7	PP2C-M	NORMAL
N8	PP2C-R	NORMAL
N10	PP3A-R	NORMAL
N11	PP3C-M	NORMAL
N12	PP3C-R	NORMAL
N13	PP4A-M	NORMAL
N14	PP4A-R	NORMAL
N15	KP1B	NORMAL
N27	PP1A-RBT	NORMAL
01	OP1A-R	OPTIONAL STANDBY
02	OP1A-M	OPTIONAL STANDBY
О3	OP1C-M	OPTIONAL STANDBY
04	OP1C-R	OPTIONAL STANDBY
O6	OP2A-R	OPTIONAL STANDBY


100% CONSTRUCTION DOCUMENTS KEY PLAN NORTH ARROW |

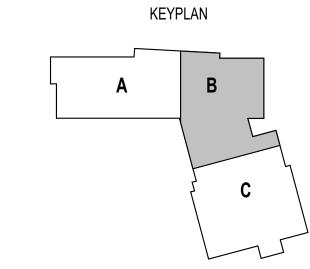


DRAWING NAME: ELECTRICAL FOURTH FLOOR POWER PLAN -

	ZONI	E B
DRAWN BY:		RBC/JAJ
REVIEWED BY:		RCB
SCALE:	AS NOTED	DRAWING NUMBER:
JOB NO.:	2202.02	E2.14B
DATE: OCTO	BER 13, 2023	

1 FOURTH FLOOR POWER PLAN - ZONE B

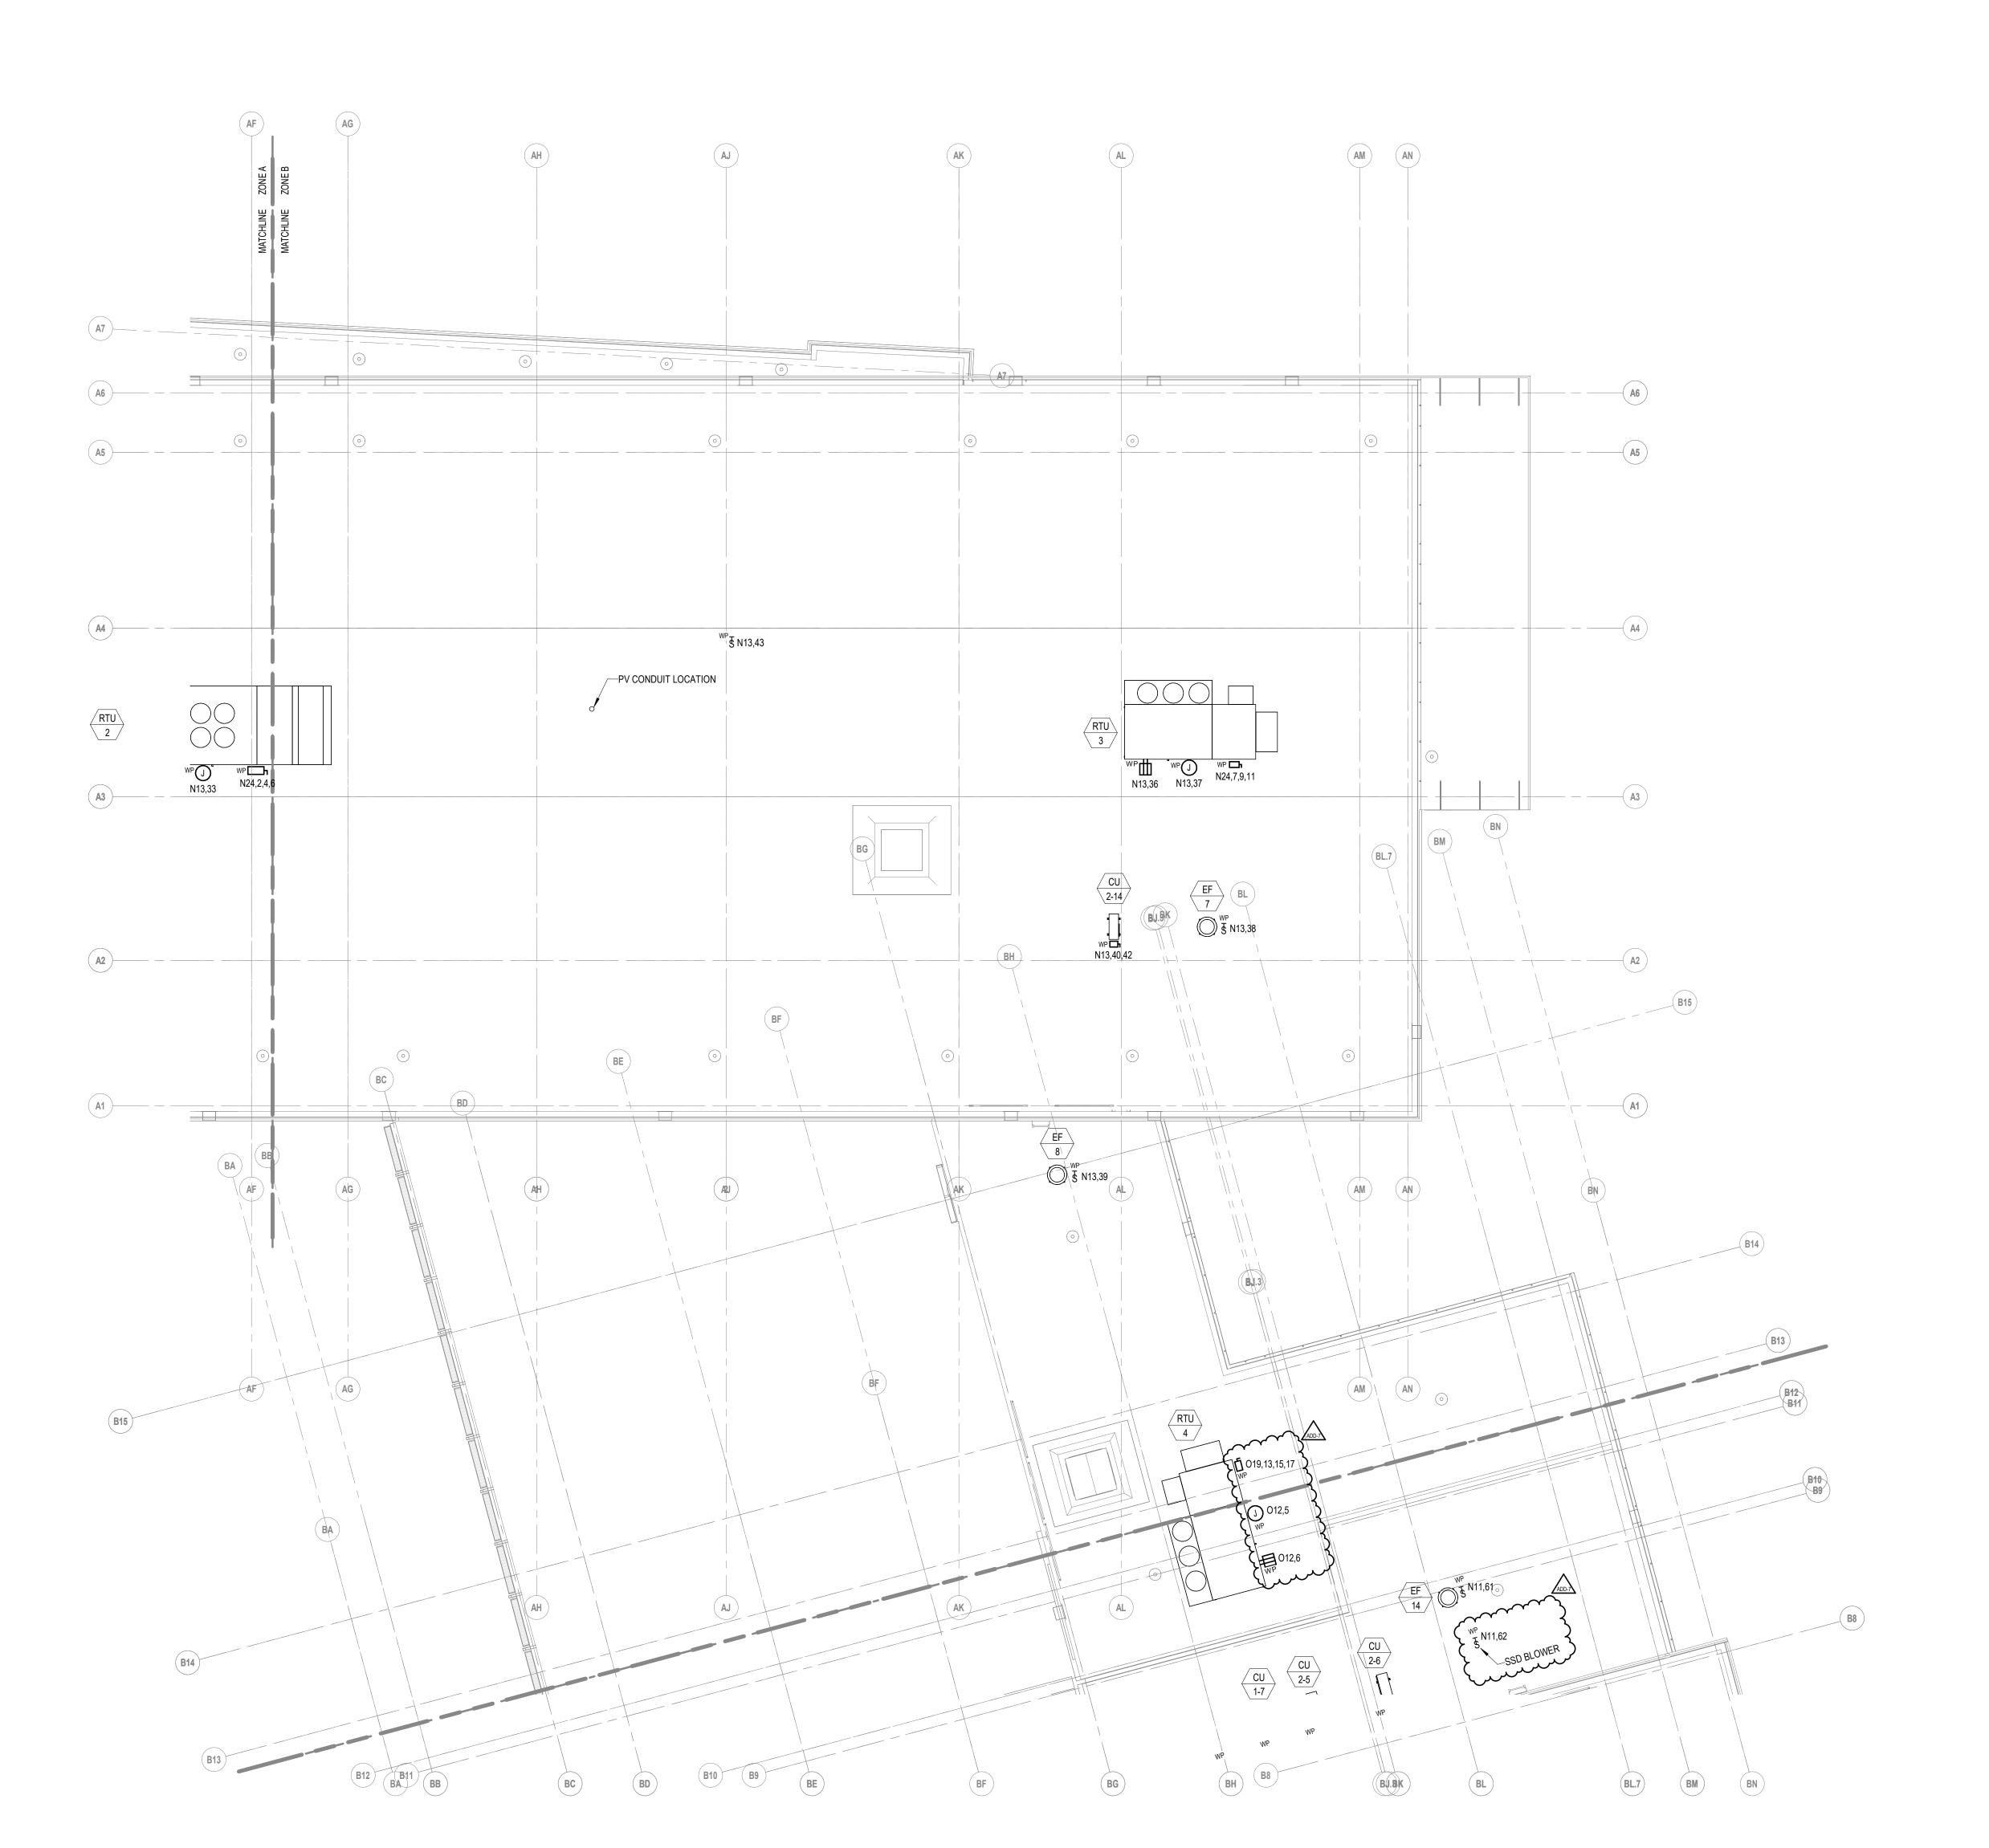

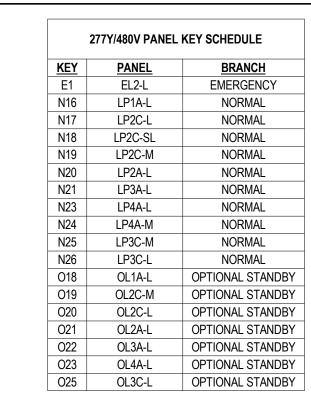

	5
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	208Y/120V PANEL	KEY SCHEDULE
KEY	PANEL NAME	BRANCH
E2	EP2-R	EMERGENCY
C1	CP1A	NORMAL
C2	CP1C	NORMAL
C4	CP2A	NORMAL
C5	CP2C	NORMAL
C6	CP3A	NORMAL
C7	CP3C	NORMAL
C8	CP4A	NORMAL
N1	PP1A-R	NORMAL
N2	PP1A-M	NORMAL
N3	PP1C-M	NORMAL
N4	PP1C-R	NORMAL
N5	PP2A-M	NORMAL
N6	PP2A-R	NORMAL
N7	PP2C-M	NORMAL
N8	PP2C-R	NORMAL
N10	PP3A-R	NORMAL
N11	PP3C-M	NORMAL
N12	PP3C-R	NORMAL
N13	PP4A-M	NORMAL
N14	PP4A-R	NORMAL
N15	KP1B	NORMAL
N27	PP1A-RBT	NORMAL
01	OP1A-R	OPTIONAL STANDBY
02	OP1A-M	OPTIONAL STANDBY
03	OP1C-M	OPTIONAL STANDBY
04	OP1C-R	OPTIONAL STANDBY
O6	OP2A-R	OPTIONAL STANDBY
07	OP2C-M	OPTIONAL STANDBY
08	OP2C-R	OPTIONAL STANDBY
O10	OP3A-R	OPTIONAL STANDBY
011	OP3C-L	OPTIONAL STANDBY
012	OP3C-M	OPTIONAL STANDBY
013	OP3C-R	OPTIONAL STANDBY
015	OP4A-R	OPTIONAL STANDBY
O16	OKP1B	OPTIONAL STANDBY
017	OMDF	OPTIONAL STANDBY

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	KEYNOTE LEGEND:
	GENERAL NOTES

PROVIDE WIRING AS REQUIRED PER APPROVED MECHANICAL SHOP DRAWINGS VIA 1"C, FROM THE TERMINAL BLOCK OF CONDENSING UNITS TO THE TERMINAL BLOCK OF ASSOCIATED SPLIT TYPE AIR CONDITIONERS.

ADD-7 ADDENDUM 7 1/26/2024

100% CONSTRUCTION DOCUMENTS

KEY PLAN NORTH ARROW

KEYPLAN

A

B

C


DRAWING NAME:

ELECTRICAL ROOF POWER PLAN - ZONE B

DRAWN BY:		RBC/JAJ
REVIEWED E	BY:	RCB
SCALE:	AS NOTED	DRAWING NUMBER:
JOB NO.:	2202.02	F2 15R
DATE: OC	TOBER 13, 2023	LZ. 10D

1 ROOF PLAN POWER PLAN - ZONE B

B14	BA /		BF /	RTU	BJ.3) / / / / / / / / / / / / / / / / / / /	BN
	AH	AJ		4	AM AN O	
MATCHLINE ZONE C B12 B11			AK	AL WP	12,5	
B10 B9					EF WP N11,61	
B8 —	DD. N11,17,19,21	016,13	FREEZER CONDENSING UNIT. N TO BE DETERMINED. REFER //ING E3.02 FOR ELECTRICAL MENTS. I COOLER CONDENSING UNIT. N TO BE DETERMINED. REFER	CU 2-12 CU 1-6 CU 1-7 CU 2-5 CU 1-7 C	CU 2-6	
	N11,22,24 WP UI	016,4,6,8 TO DRAW REQUIRE	COOLER CONDENSING UNIT. N TO BE DETERMINED. REFER VING E3.02 FOR ELECTRICAL MENTS.			
	N11,23,25 WP U N11,26 CU 3-4	WP □ J WP N25,2,4,6 N11,30	RTU 7	RTU 5 N11,35 WP N11,35 WP N11,34 J N11,34 J N25,8,10,12 D		
B7			<u> </u>	N11,31 N23,8, 10, 12 J		
		PV CONDUIT LOCATION			PV CONDUIT LOCATION CU 2-9 N11,49,51	1,45,47
B6 ————————————————————————————————————			· · · · · · · · · · · · · · · · · · ·	RTU 8	N11,36 WP O12,8 N11,36 WP N11 WP CU 2-7	,42,44
				EF 10	WP	
B5 B5					CU 2-11 CU 2-10	0
				N11,54,56 CU 1-9	N11,37 WP N11,40 J RTU 9	
B4 B4	WP	WP	SH) B E2,6	N11,58,60 N11,57,59 \$\frac{WP}{\text{\$\text{\$N11,64}}}		
B3	\$\\\\\\\\\\\\\\\\\\\\\\\\\\\\\\\\\\\\\	SH) \$ E2,5		CU 1-11 (CU 1-10)		
B2						
B1						

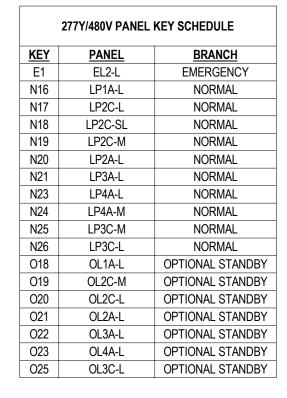

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MECHANICAL SHOP DRAWINGS VIA 1"C, FROM THE TERMINAL BLOCK OF CONDENSING UNITS TO THE TERMINAL BLOCK OF ASSOCIATED SPLIT TYPE AIR

KEYNOTE LEGEND:

GENERAL NOTES


CONDITIONERS.

KEY	PANEL NAME	BRANCH
E2	EP2-R	EMERGENCY
C1	CP1A	NORMAL
C2	CP1C	NORMAL
C4	CP2A	NORMAL
C5	CP2C	NORMAL
C6	CP3A	NORMAL
C7	CP3C	NORMAL
C8	CP4A	NORMAL
N1	PP1A-R	NORMAL
N2	PP1A-M	NORMAL
N3	PP1C-M	NORMAL
N4	PP1C-R	NORMAL
N5	PP2A-M	NORMAL
N6	PP2A-R	NORMAL
N7	PP2C-M	NORMAL
N8	PP2C-R	NORMAL
N10	PP3A-R	NORMAL
N11	PP3C-M	NORMAL
N12	PP3C-R	NORMAL
N13	PP4A-M	NORMAL
N14	PP4A-R	NORMAL
N15	KP1B	NORMAL
N27	PP1A-RBT	NORMAL
01	OP1A-R	OPTIONAL STANDB
02	OP1A-M	OPTIONAL STANDB
O3	OP1C-M	OPTIONAL STANDB
04	OP1C-R	OPTIONAL STANDB
O6	OP2A-R	OPTIONAL STANDB
07	OP2C-M	OPTIONAL STANDB
08	OP2C-R	OPTIONAL STANDB
010	OP3A-R	OPTIONAL STANDB
011	OP3C-L	OPTIONAL STANDB
012	OP3C-M	OPTIONAL STANDB
O13	OP3C-R	OPTIONAL STANDB
015	OP4A-R	OPTIONAL STANDB
016	OKP1B	OPTIONAL STANDBY
017	OMDF	OPTIONAL STANDBY

ADD-7 ADDENDUM 7 1/26/2024

100% CONSTRUCTION DOCUMENTS

KEY PLAN NORTH ARROW

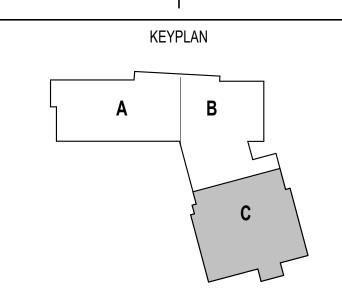


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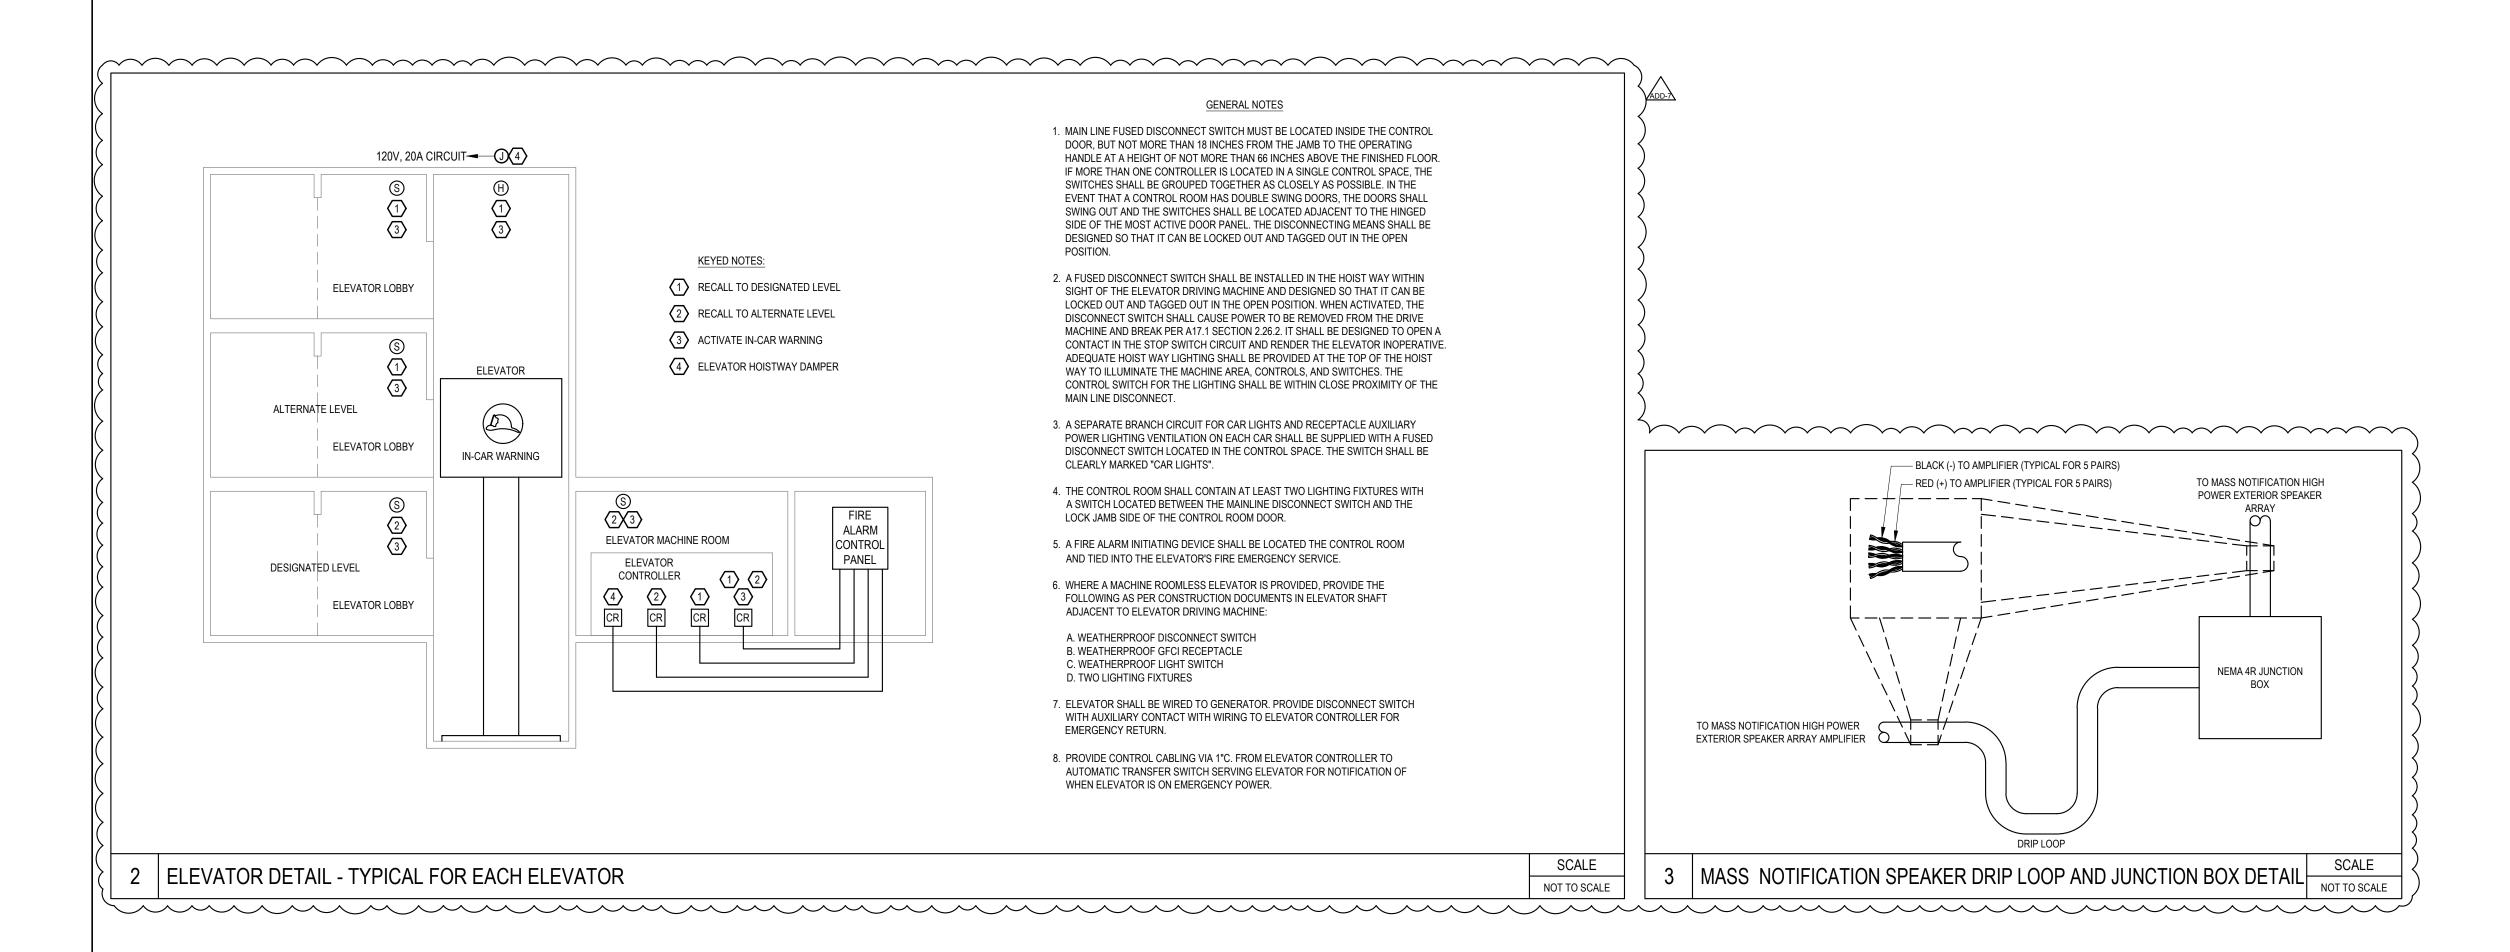
ELECTRICAL ROOF POWER PLAN - ZONE C

DRAWN BY: RBC/JA.	J
REVIEWED BY: RCE	-
SCALE: AS NOTED DRAWING NUMBER:	_
JOB NO.: 2202.02 F2 15C	
DATE: OCTOBER 13, 2023	

1 ROOF PLAN POWER PLAN - ZONE C

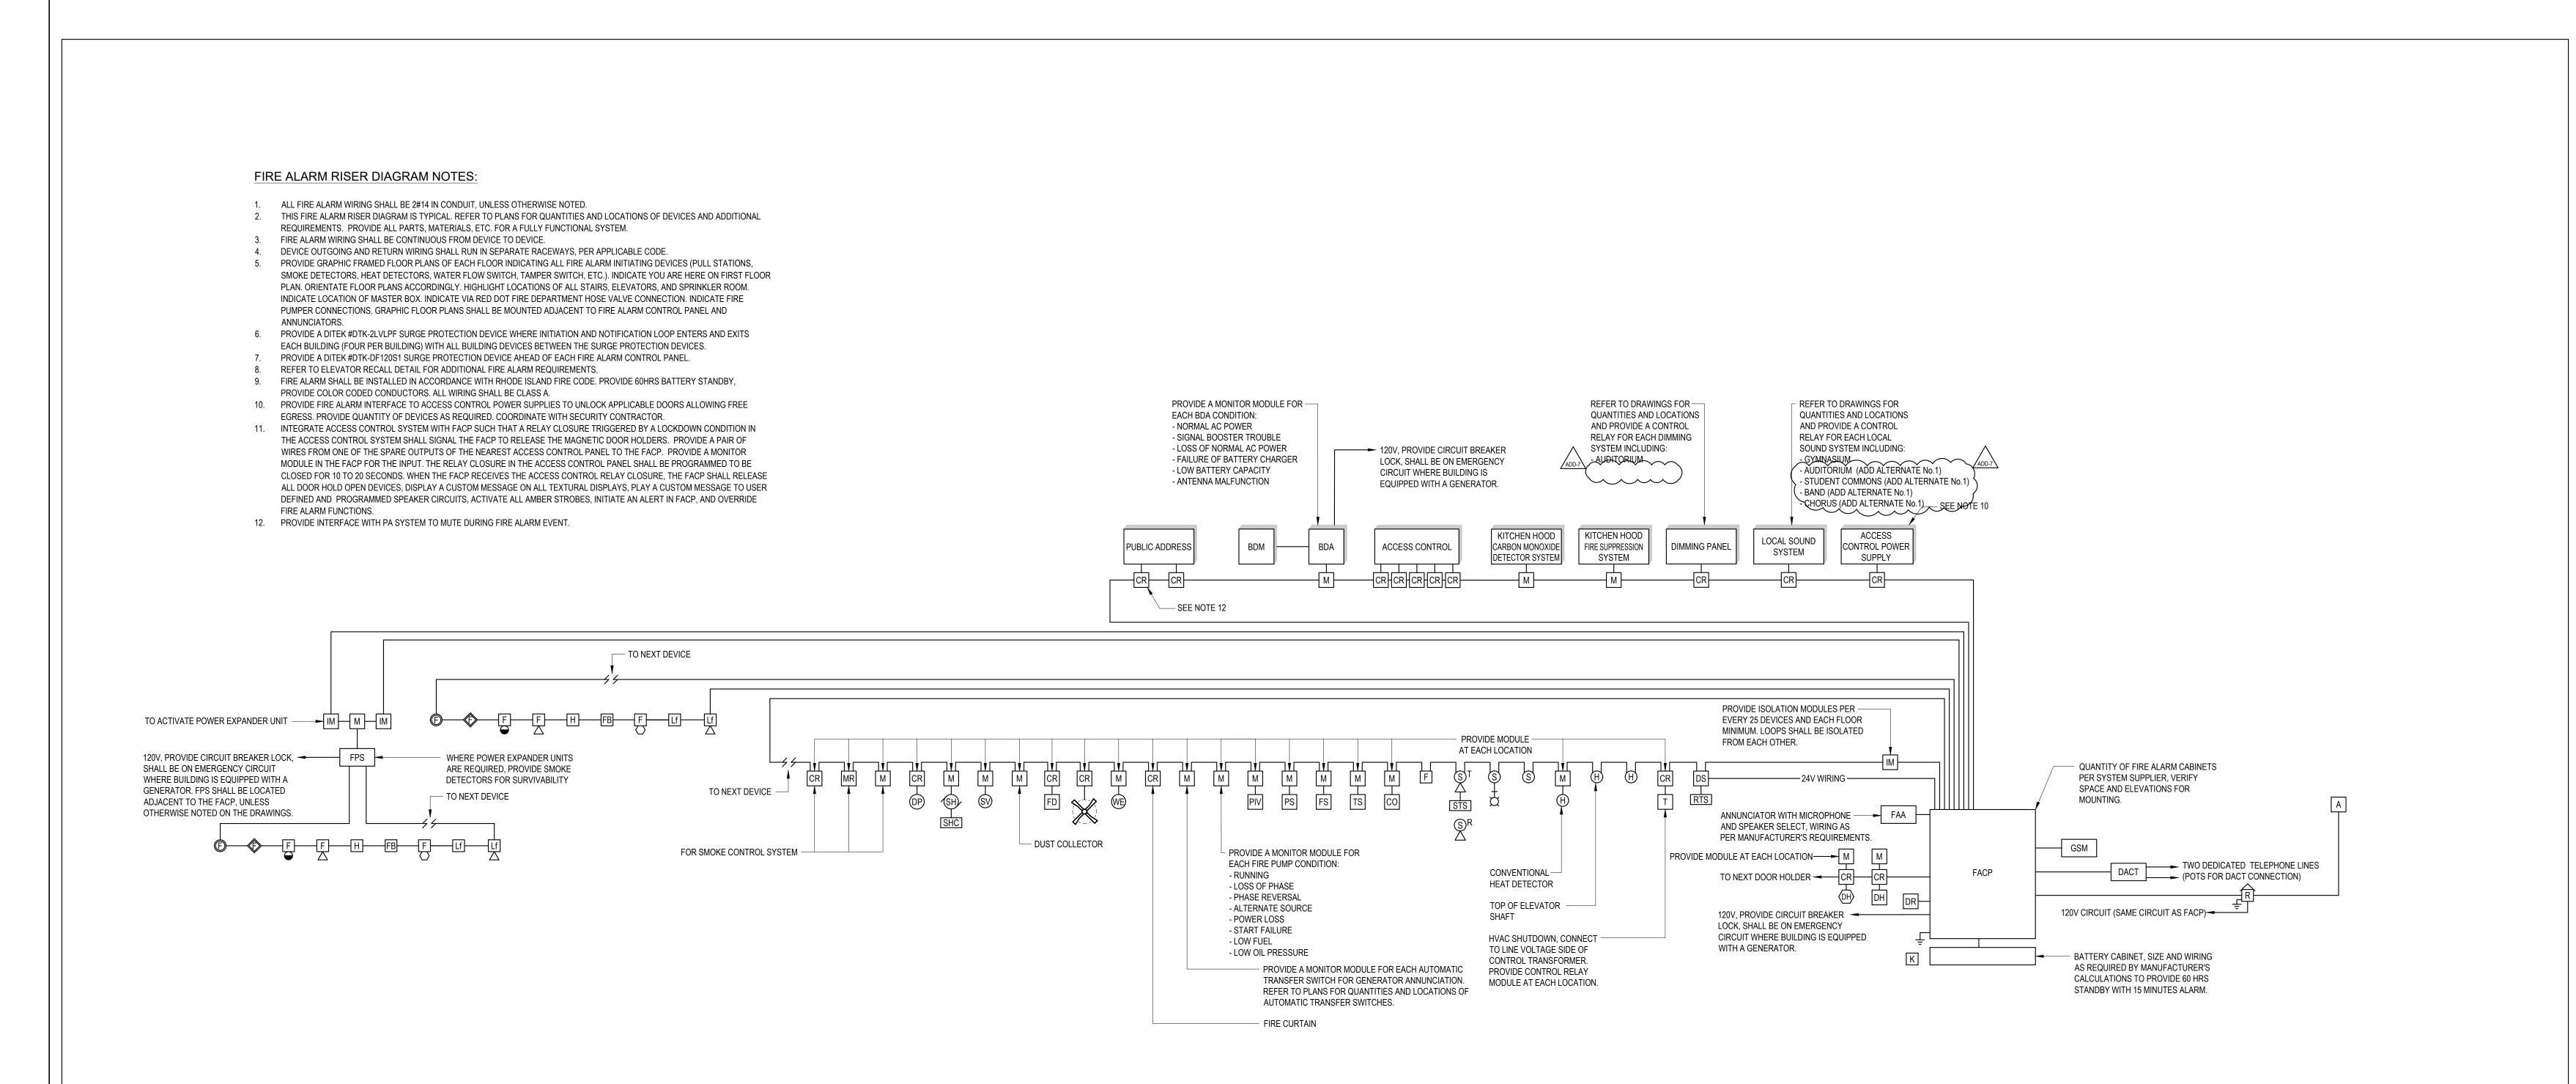

SCALE FIRE ALARM SYSTEM RISER DIAGRAM NOT TO SCALE





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KEYNOTE LEGEND:

ADDENDUM 7 **100% CONSTRUCTION DOCUMENTS** KEY PLAN NORTH ARROW

KEYPLAN

DRAWING NAME: ELECTRICAL FIRE ALARM

DRAWN BY: REVIEWED BY: NONE | DRAWING NUMBER:

LED LIGHTING FIXTURE SCHEDULE (1 OF 2)

TYPICAL LIGHTING NOTES

MOUNTING ABBREVIATIONS, "R" = RECESSED IN CEILING, "S" = SURFACE, "W" = WALL, "P" = PENDANT, "GR" = GROUND, "U" = UNIVERSAL.

LIGHTING FIXTURES SHALL BE FURNISHED COMPLETE WITH ALL HARDWARE, LAMPS, HANGERS, ACCESSORIES, ETC. FOR A COMPLETE AND PROPER INSTALLATION. VERIFY ROOM SURFACE CONSTRUCTION/FINISH TYPES PRIOR TO THE RELEASE OF ANY LIGHTING FIXTURES TO ENSURE PROPER MOUNTING PROVISIONS AND FIXTURES FITTINGS. REFER TO ARCHITECTURAL DRAWINGS/ELEVATIONS.

3. VERIFY ALL LIGHTING FIXTURE MOUNTING HEIGHTS AND LOCATIONS WITH ARCHITECTURAL DRAWINGS/ELEVATIONS PRIOR TO THE START OF ROUGHING. PENDANT FIXTURES SHALL BE MINIMUM 19" FROM TOP OF FIXTURE TO CEILING UNLESS OTHERWISE NOTED.

4. ALL LAMPS, BALLASTS, LED SOURCES, DRIVERS, AND CONTROLS SHALL MEET THE LATEST UTILITY CO. INCENTIVE REQUIREMENTS. REFER TO THE LATEST PROGRAM REQUIREMENTS DOCUMENTATION AND COORDINATE WITH UTILITY CO. TO ENSURE COMPLIANCE.

5. EXIT SIGNS SHALL BE TYPICALLY MOUNTED ON CEILINGS WHERE VISIBLE OR ON WALL WHERE CEILING MOUNTING IS NOT PRACTICAL. PRIOR TO ROUGHING COORDINATE WITH ARCHITECTURAL DRAWINGS/ELEVATIONS FOR SPECIFIC MOUNTING DIRECTION AND FOR LOCATION.

- 6. LIGHTING FIXTURES TO BE CONTROLLED BY DAYLIGHT HARVESTING SYSTEM SHALL BE PROVIDED WITH 0-10 VOLT DIMMING DRIVERS.
 7. WHEN SUBMITTING TO ENGINEER FOR REVIEW THE LIGHTING FIXTURE SUBMITTALS SHALL CONSIST OF THE FOLLOWING: LIGHTING FIXTURE CUT SHEET, LIGHTING FIXTURE BALLAST/DRIVER CUT SHEET, AND LIGHTING FIXTURE LAMP/LED CUT SHEET FOR EACH FIXTURE. GROUPED CUT
- SHEETS WILL NOT BE ALLOWED. WHEN SUBMITTING ON LED PRODUCTS PROVIDE LIGHTING FACTS, LM-79, AND LM-80 TEST REPORTS FOR REVIEW.

 8. THE MANUFACTURER'S AND CATALOG NUMBERS IDENTIFIED IN THIS LIGHTING FIXTURE SCHEDULE ARE INTENDED TO ESTABLISH A GENERAL LEVEL OF QUALITY, CONFIGURATION, MATERIALS, AND APPEARANCE REQUIRED. THIS IS NOT A PROPRIETARY SPECIFICATION AND IT SHOULD BE NOTED THAT "OR EQUAL" APPLIES TO ALL LIGHTING FIXTURES DENOTED HEREIN. IT IS UNDERSTOOD THAT ALL MANUFACTURER'S WILL HAVE MINOR VARIATIONS IN CONFIGURATION, APPEARANCE, AND PRODUCT SPECIFICATIONS AND SUCH MINOR VARIATIONS SHALL NOT ELIMINATE SUCH

MANUFACTURER'S AS AN APPROVED EQUAL.
9. CONNECT EMERGENCY BATTERY UNITS AND EXIT SIGNS WITH BACK-UP BATTERY TO NEAREST UNSWITCHED LIGHTING CIRCUIT FOR CHARGING OF EMERGENCY BATTERIES IN UNITS.

10. PROVIDE TWO ADDITIONAL WIRES TO DIMMING RACK IN ADDITION TO POWER WIRING WHERE 0.10 VOLT DIMMING DRIVERS ARE SPECIFIED FOR CONTROL

11. AS REQUIRED BY LEED VERSION 4, INTERIOR LIGHTING, OPTION 2, LIGHTING QUALITY, LIGHTING FIXTURES SHALL HAVE A LUMINANCE OF LESS THAN 2,500 CANDELA/METER SQUARED BETWEEN 45 AND 90 DEGREES FROM NADIR.

(13. AS REQUIRED BY LEED VERS	SION 4, INTERIOR LIGHTING, OPTION 2, LIGHTING QUALITY, SION 4, INTERIOR LIGHTING, OPTION 2, LIGHTING QUALITY,	LIGHTING FIXT	TURES SHALL F	HAVE A MINIM	IUM RATED I	IFF (OR I 70 F	OR LED SOU	RCES) OF AT LEAST 24 000 HOURS	
TYPE MANUFACTURER	CATALOG NUMBER	VOLTAGE			TOTAL LUMENS	COLOR TEMP.	DIMMING (%)	DESCRIPTION/REMARKS	COLOR/ FINISH
A4 CORELITE CONTINUA	CTA-F-7525-50L835-1D-UNV-STD-CBA-AC48-XX-4	UNV	Р	38	5061	3500K	0-10V (1%)	4' LINEAR PENDANT, 75% UP, 25% DOWN INDIRECT/DIRECT LIGHTING FIXTURE, WITH TIR OPTICS, AND ADJUSTABLE AIRCRAFT CABLE SUSPENSION.	СВА
A4L CORELITE CONTINUA	CTA-F-7525-40L835-1D-UNV-STD-CBA-AC48-XX-4	UNV	Р	30	3993	3500K	0-10V (1%)	4' LINEAR PENDANT, 75% UP, 25% DOWN INDIRECT/DIRECT LIGHTING FIXTURE, WITH TIR OPTICS, AND ADJUSTABLE AIRCRAFT CABLE SUSPENSION.	СВА
A6 CORELITE CONTINUA	CTA-F-7525-50L835-1D-UNV-STD-CBA-AC48-XX-6	UNV	Р	30	3993	3500K	0-10V (1%)	6' LINEAR PENDANT, 75% UP, 25% DOWN INDIRECT/DIRECT LIGHTING FIXTURE, WITH TIR OPTICS, AND ADJUSTABLE AIRCRAFT CABLE SUSPENSION.	Х
A8 CORELITE CONTINUA	CTA-F-7525-50L835-1D-UNV-STD-CBA-AC48-XX-8	UNV	Р	76	10122	3500K	0-10V (1%)	8' LINEAR PENDANT, 75% UP, 25% DOWN INDIRECT/DIRECT LIGHTING FIXTURE, WITH TIR OPTICS, AND ADJUSTABLE AIRCRAFT CABLE SUSPENSION.	х
A8L CORELITE CONTINUA	CTA-F-7525-40L835-1D-UNV-STD-CBA-AC48-XX-8	UNV	Р	60	7986	3500K	0-10V (1%)	8' LINEAR PENDANT, 75% UP, 25% DOWN INDIRECT/DIRECT LIGHTING FIXTURE, WITH TIR OPTICS, AND ADJUSTABLE AIRCRAFT CABLE SUSPENSION.	Х
DR1 COOPER HALO	HC410D010-HM40525835-41WDH	UNV	R	10	1000	3500K	0-10V (1%)	4" ROUND 75 DEGREE WIDE BEAM DOWNLIGHT, SEMI-SPECULAR CLEAR REFLECTOR AND FLANGE.	СВА
DR05 COOPER HALO	HC410D010-HM40525835-41WDH	UNV	R	6.1	500	3500K	0-10V (1%)	4" ROUND 75 DEGREE WIDE BEAM DOWNLIGHT, SEMI-SPECULAR CLEAR REFLECTOR AND FLANGE.	СВА
DS4- 05 COOPER PORTFOLIO	LDSQ4C-05-9035-D010-SQ1H	UNV	R	7.8	500	3500K	0-10V (1%)	4" SQUARE DOWNLIGHT, MEDIUM DISTRIBUTION, SEMI-SPECULAR CLEAR REFLECTOR WITH FLANGE. 90 CRI.	СВА
DS4- 1W COOPER PORTFOLIO	LDSQ4C-10-9035-D010-SQ1H	UNV	R	10.5	1000	3500K	0-10V (1%)	4" SQUARE DOWNLIGHT, WIDE DISTRIBUTION, SEMI-SPECULAR CLEAR REFLECTOR WITH FLANGE. 90 CRI.	СВА
DS4- 2M COOPER PORTFOLIO	LDSQ4C-20-9035-D010-SQ1H	UNV	R	22.6	2000	3500K	0-10V (1%)	4" SQUARE DOWNLIGHT, MEDIUM DISTRIBUTION, SEMI-SPECULAR CLEAR REFLECTOR WITH FLANGE. 90 CRI.	СВА
DS4- 3M COOPER PORTFOLIO	LDSQ4C-20-9035-D010-SQ1H	UNV	R	34	3000	3500K	0-10V (1%)	4" SQUARE DOWNLIGHT, MEDIUM DISTRIBUTION, SEMI-SPECULAR CLEAR REFLECTOR WITH FLANGE. 90 CRI.	СВА
FP22L COOPER METALUX	22FP2135C	UNV	R	20.7	2205	3500K	0-10V (1%)	2' X 2', RECESSED, GRID, EDGE LIT FLAT PANEL.	СВА
FP24H COOPER METALUX	24FP6435C	UNV	R	60.3	6091	3500K	0-10V (1%)	2' X 4', RECESSED, GRID, EDGE LIT FLAT PANEL.	СВА
FP24L COOPER METALUX	24FP3135C	UNV	R	29.3	3533	3500K	0-10V (1%)	2' X 4', RECESSED, GRID, EDGE LIT FLAT PANEL.	СВА
FPK COOPER FAIL-SAFE	FSP-22-42-35-CA125	UNV	R	38.3	4330	3500K	0-10V (1%)	2' X 2', RECESSED, GRID, SEALED FLAT PANEL LIGHTING FIXTURE, .125" ACRYLIC LENS, WET LOCATION RATED.	СВА
IND4 COOPER METALUX	4SNLED-LD5-37SL-LW-UNV-L835-CD1-U	UNV	U	31	3812	3500K	0-10V (1%)	2.75" WIDE, 4' STRIP, FULL FROST WIDE DIFFUSE MATTE ACRYLIC LENS, SURFACE MOUNT OR CHAIN HUNG.	СВА
LG4 COOPER NEORAY	S122DR-S675D835-XXX4F0-1-UDD-F-W	UNV	R	27.2	2700	3500K	0-10V (1%)	2" X 4' RECESSED, GRID, LINEAR, DIRECT LIGHTING FIXTURE, WITH FLUSH DIFFUSER.	СВА
LG4L COOPER NEORAY	S122DR-S290D835-XXX4F0-1-UDD-F-W	UNV	R	12	1160	3500K	0-10V (1%)	2" X 4' RECESSED, GRID, LINEAR, DIRECT LIGHTING FIXTURE, WITH FLUSH DIFFUSER.	СВА
LG4VH COOPER NEORAY	S122DR-S865D835-XXX4F0-1-UDD-F-W	UNV	R	35.6	3460	3500K	0-10V (1%)	2" X 4' RECESSED, GRID, LINEAR, DIRECT LIGHTING FIXTURE, WITH FLUSH DIFFUSER.	СВА
LG6H COOPER NEORAY	S122DR-S675D835-XXX4F0-1-UDD-F-W	UNV	R	40.8	4050	3500K	0-10V (1%)	2" X 6' RECESSED, GRID, LINEAR, DIRECT LIGHTING FIXTURE, WITH FLUSH DIFFUSER.	СВА
LG6M COOPER NEORAY	S122DR-S485D835XXX6F0-1-UDD-F-W	UNV	R	28.8	2910	3500K	0-10V (1%)	2" X 6' RECESSED, GRID, LINEAR, DIRECT LIGHTING FIXTURE, WITH FLUSH DIFFUSER.	СВА
LG8L COOPER NEORAY	S122DR-S290D835XXX8F0-1-UDD-F-W	UNV	R	24	2320	3500K	0-10V (1%)	2" X 8' RECESSED, GRID, LINEAR, DIRECT LIGHTING FIXTURE, WITH FLUSH DIFFUSER.	СВА
LG8M COOPER NEORAY	S122DR-S675D835-XXX8F0-1-UDD-F-W	UNV	R	54.4	5400	3500K	0-10V (1%)	2" X 8' RECESSED, GRID, LINEAR, DIRECT LIGHTING FIXTURE, WITH FLUSH DIFFUSER.	СВА
LG12 COOPER NEORAY	S122DR-S675D835XXX12F0-1-UDD-F-W	UNV	R	81.6	8100	3500K	0-10V (1%)	2" X 12' RECESSED, GRID, LINEAR, DIRECT LIGHTING FIXTURE, WITH FLUSH DIFFUSER.	СВА
LG14 COOPER NEORAY	S122DR-S290D835XXX14F0-1-UDD-F-W	UNV	R	42	4060	3500K	0-10V (1%)	2" X 14' RECESSED, GRID, LINEAR, DIRECT LIGHTING FIXTURE, WITH FLUSH DIFFUSER.	СВА
LP4VH COOPER NEORAY	S122DP-C865D935-C10-XX-CBA-4F0-1-UDD-F-CBA	UNV	Р	35.2	3460	3500K	0-10V (1%)	2" X 4' PENDANT, LINEAR, DIRECT LIGHTING FIXTURE, WITH FLUSH DIFFUSER. 90 CRI.	СВА
LP6H COOPER NEORAY	S122DP-C675D935-C10-XX-CBA-4F0-1-UDD-F-CBA	UNV	Р	40.2	4050	3500K	0-10V (1%)	2" X 6' PENDANT, LINEAR, DIRECT LIGHTING FIXTURE, WITH FLUSH DIFFUSER. 90 CRI.	СВА
LP8H COOPER NEORAY	S122DP-C675D835-C4-XX-CBA-8F0-1-UDD-F-CBA	UNV	Р	53.6	5400	3500K	0-10V (1%)	2" X 8' PENDANT, LINEAR, DIRECT LIGHTING FIXTURE, WITH FLUSH DIFFUSER.	СВА
LP12H COOPER NEORAY	S122DP-C675D835-C4-XX-CBA-12F0-1-UDD-F-CBA	UNV	Р	80.4	8100	3500K	0-10V (1%)	2" X 12' PENDANT, LINEAR, DIRECT LIGHTING FIXTURE, WITH FLUSH DIFFUSER.	СВА
LR2 COOPER NEORAY	S122DR-S675D835-XXX2F0-1-UDD-F-W	UNV	R	12.1	1350	3500K	0-10V (1%)	2" X 2' RECESSED, GYPSUM BOARD MOUNT, LINEAR, DIRECT LIGHTING FIXTURE, WITH FLUSH DIFFUSER.	СВА
LR4 COOPER NEORAY	S122DR-S675D835-XXX4F0-1-UDD-F-W	UNV	R	24.2	2700	3500K	0-10V (1%)	2" X 4' RECESSED, GYPSUM BOARD CEILING MOUNT, LINEAR, DIRECT LIGHTING FIXTURE, WITH FLUSH DIFFUSER.	СВА
LR4M COOPER NEORAY	S122DR-S675D935-XXX4F0-1-UDD-F-W	UNV	R	24.2	2700	3500K	0-10V (1%)	2" X 4' RECESSED, GYPSUM BOARD CEILING MOUNT, LINEAR, DIRECT LIGHTING FIXTURE, WITH FLUSH DIFFUSER. 90 CRI.	СВА
LR6 COOPER NEORAY	S122DR-S675D835-XXX6F0-1-UDD-F-W	UNV	R	40.8	4050	3500K	0-10V (1%)	2" X 6' RECESSED, GYPSUM BOARD CEILING MOUNT, LINEAR, DIRECT LIGHTING FIXTURE, WITH FLUSH DIFFUSER.	СВА
LR6L COOPER NEORAY	S122DR-S290D835-XXX6F0-1-UDD-F-W	UNV	R	18	1740	3500K	0-10V (1%)	2" X 6' RECESSED, GYPSUM BOARD CEILING MOUNT, LINEAR, DIRECT LIGHTING FIXTURE, WITH FLUSH DIFFUSER.	СВА
LR8 COOPER NEORAY	S122DR-S675D835-XXX8F0-1-UDD-F-W	UNV	R	54.4	5400	3500K	0-10V (1%)	2" X 8' RECESSED, GYPSUM BOARD CEILING MOUNT, LINEAR, DIRECT LIGHTING FIXTURE, WITH FLUSH DIFFUSER.	СВА
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LED LIGHTING FIXTURE SCHEDULE (2 OF 2)

	LED LIGHTING FIXTURE SCHEDULE (2 OF 2)									
TYPE MANUF	ACTURER	CATALOG NUMBER	VOLTAGE	MOUNTING	WATTAGE	TOTAL LUMENS	COLOR TEMP.	DIMMING (%)	DESCRIPTION/REMARKS	COLOR/ FINISH
LR8L COOPER NEG	ORAY	S122DR-S290D835-XXX8F0-1-UDD-F-W	UNV	R	24	2320	3500K		2" X 8' RECESSED, GYPSUM BOARD CEILING MOUNT, LINEAR, DIRECT LIGHTING FIXTURE, WITH FLUSH DIFFUSER.	СВА
LR10L COOPER NE	ORAY	S122DR-S290D835-XXX10F0-1-UDD-F-W	UNV	R	30	2900	3500K	0-10V (1%)	2" X 10' RECESSED, GYPSUM BOARD CEILING MOUNT, LINEAR, DIRECT LIGHTING FIXTURE, WITH FLUSH DIFFUSER.	СВА
LR12 COOPER NEG	ORAY	S122DR-S675D835-XXX12F0-1-UDD-F-W	UNV	R	80.4	8100	3500K	0-10V (1%)	2" X 12' RECESSED, GYPSUM BOARD CEILING MOUNT, LINEAR, DIRECT LIGHTING FIXTURE, WITH FLUSH DIFFUSER.	СВА
LR12L COOPER NEG	ORAY	S122DR-S290D835-XXX12F0-1-UDD-F-W	UNV	R	36	3480	3500K	0-10V (1%)	2" X 12' RECESSED, GYPSUM BOARD CEILING MOUNT, LINEAR, DIRECT LIGHTING FIXTURE, WITH FLUSH DIFFUSER.	СВА
LR20L COOPER NEG	ORAY	S122DR-S290D835-XXX20F0-1-UDD-F-W	UNV	R	60	5800	3500K	0-10V (1%)	2" X 20' RECESSED, GYPSUM BOARD CEILING MOUNT, LINEAR, DIRECT LIGHTING FIXTURE, WITH FLUSH DIFFUSER.	СВА
LR22L COOPER NEG	ORAY	S122DR-S290D835-XXX22F0-1-UDD-F-W	UNV	R	66	6380	3500K	0-10V (1%)	2" X 22' RECESSED, GYPSUM BOARD CEILING MOUNT, LINEAR, DIRECT LIGHTING FIXTURE, WITH FLUSH DIFFUSER.	СВА
LR24L COOPER NEG	ORAY	S122DR-S290D835-XXX24F0-1-UDD-F-W	UNV	R	72	6960	3500K	0-10V (1%)	2" X 24' RECESSED, GYPSUM BOARD CEILING MOUNT, LINEAR, DIRECT LIGHTING FIXTURE, WITH FLUSH DIFFUSER.	СВА
LR28L COOPER NEG	ORAY	S122DR-S290D835-XXX28F0-1-UDD-F-W	UNV	R	84	8120	3500K	0-10V (1%)	2" X 28' RECESSED, GYPSUM BOARD CEILING MOUNT, LINEAR, DIRECT LIGHTING FIXTURE, WITH FLUSH DIFFUSER.	СВА
LR30L COOPER NEG	ORAY	S122DR-S290D835-XXX30F0-1-UDD-F-W	UNV	R	90	8700	3500K		2" X 30' RECESSED, GYPSUM BOARD CEILING MOUNT, LINEAR, DIRECT LIGHTING FIXTURE, WITH FLUSH DIFFUSER.	СВА
LR32L COOPER NEG	ORAY	S122DR-S290D835-XXX32F0-1-UDD-F-W	UNV	R	96	9280	3500K	0-10V (1%)	2" X 32' RECESSED, GYPSUM BOARD CEILING MOUNT, LINEAR, DIRECT LIGHTING FIXTURE, WITH FLUSH DIFFUSER.	СВА
LR36L COOPER NEG	ORAY	S122DR-S290D835-XXX36F0-1-UDD-F-W	UNV	R	108	10440	3500K		2" X 36' RECESSED, GYPSUM BOARD CEILING MOUNT, LINEAR, DIRECT LIGHTING FIXTURE, WITH FLUSH DIFFUSER.	СВА
LR66 COOPER NEG	ORAY	S123RDR-S1000D835-XXX66F0-1-UDD-F-W	UNV	R	587.4	66000	3500K	0-10V (1%)	3" X 66' RECESSED, GYPSUM BOARD CEILING MOUNT, LINEAR, DIRECT LIGHTING FIXTURE, WITH REGRESSED DIFFUSER.	СВА
LR74 COOPER NEG	ORAY	S123RDR-S1000D835-XXX74F0-1-UDD-F-W	UNV	R	658.6	74000	3500K	0-10V (1%)	3" X 74' RECESSED, GYPSUM BOARD CEILING MOUNT, LINEAR, DIRECT LIGHTING FIXTURE, WITH REGRESSED DIFFUSER.	СВА
R5 ALW LIGHTIN	NG	MR1.5-D5-SS-MIN/80/3500-0/10V/1%-LENS-MIN/80/3500K- 0/10V/1%-LENS-CBA-UNV	UNV	Р	116	7950	3500K	0-10V (1%)	5' DIAMETER RING DIRECT/INDIRECT PENDANT LIGHTING FIXTURE, 1.5" WALL, ACRYLIC LENS.	СВА
SQ4 ALW LIGHTIN	NG	LS2PD-4-HI/90/3500-0/10V/1%-EXT/R-CBA-UNV	UNV	Р	72.2	8000	3500K	0-10V (1%)	4' X 4' SQUARE, DIRECT PENDANT LIGHTING FIXTURE, FULLY ILLUMINATED MITERED CORNERS. 2" WIDTH, ACRYLIC LENS.	Х
VM1 COOPER ME	TALUX	24CZ2-40-UNV-L835-CD1-U	UNV	R	31.6	4000	3500K	0-10V (1%)	2' X 4' VOLUMETRIC LIGHTING FIXTURE WITH FROSTED ACRYLIC LENS, RECESSED, GRID.	Х
VM2 COOPER ME	TALUX	24CZ2-55-UNV-L835-CD1-U	UNV	R	43	5500	3500K	0-10V (1%)	2' X 4' VOLUMETRIC LIGHTING FIXTURE WITH FROSTED ACRYLIC LENS, RECESSED, GRID.	Х
VP EATON ALL-F	PRO	VT1730	UNV	S	17.7	1450	3500K	-	WEATHERPROOF, JELLY JAR, DIE CAST ALUMINUM HOUSING AND GUARD, VAPORTIGHT LIGHTING FIXTURE, WITH FROSTED GLASS.	-
WM1 LIGMAN LIGH	HTING	UGI-31641-10W-T4-W30-CBA-120/277V-DIM	UNV	W	10	820	3000K	ELV/TRIAC	8" LENGTH X 4.3" DEEP RECTANGULAR EXTERIOR LIGHTING FIXTURE.	СВА
WP1 NLS LIGHTING	IG	NV-W-T4-16L-1-30K8-UNV-WM-CBA-FSP-20	UNV	W	56	5970	3000K	0-10V	EXTERIOR WALL PACK LIGHTING FIXTURE, WITH INTEGRAL MOTION SENSOR AND PHOTOCELL.	СВА
SIGNTEX INC	0	CRSBB-1RMBA-XX-TW-DG	UNV	U	-	-	-	-	SINGLE FACE EDGE LIT EXIT SIGN, WITH RED LETTERS ON MIRROR BACKGROUND, BRUSHED ALUMINUM HOUSING, AND ARROWS AS INDICATED ON PLAN, UNIVERSAL, FIELD CONVERTIBLE. "E" INDICATES TOP OF EXIT SIGN SHALL BE 18" ABOVE FINISHED FLOOR.	-
SIGNTEX INC	0	CRSBB-2RMBA-XX-TW-DG	UNV	U	-	-	-		DOUBLE FACE EDGE LIT EXIT SIGN, WITH RED LETTERS ON MIRROR BACKGROUND, BRUSHED ALUMINUM HOUSING, AND ARROWS AS INDICATED ON PLAN, UNIVERSAL, FIELD CONVERTIBLE.	-
SIGNTEX INC		CAE-BB-1RMBA-XX-TW-DG	UNV	U	-	-	-	-	SINGLE FACE EDGE LIT EXIT SIGN, WITH RED LETTERS ON MIRROR BACKGROUND, BRUSHED ALUMINUM HOUSING, AND ARROWS AS INDICATED ON PLAN, UNIVERSAL, FIELD CONVERTIBLE, INTERNATIONAL HANIDCAP SYMBOL. "WG" INDICATES PROVIDE WIREGUARD. SEE NOTE 9.	-
SIGNTEX INC		RPR-NB-1-R-BA-TW-PF1	UNV	U	-	-	-	-	SINGLE FACE VANDAL RESISTANT EXIT SIGN, WITH RED LETTERS, BRUSHED ALUMINUM HOUSING AND FACE, POLYCARBONATE LENS, AND ARROWS AS INDICATED ON PLAN, UNIVERSAL, FIELD CONVERTIBLE. SEE NOTE 9.	-
SIGNTEX INC	<u> </u>	BPW-NB-1-R-W	UNV	U	-	-	-		SINGLE FACE WET LOCATION EXIT SIGN, WITH RED LETTERS , THERMOPLASTIC, UNIVERSAL, REFER TO NOTE #9.	-
										

LED SITE LIGHTING FIXTURE SCHEDULE

NOTES:

1. LIGHTING FIXTURES SHALL BE FURNISHED COMPLETE WITH ALL HARDWARE, LAMPS, HANGERS, ACCESSORIES, ETC. FOR A COMPLETE AND PROPER INSTALLATION.

MOTION IS DETECTED FOR THE DURATION PERIOD, AFTER WHICH THE LIGHTING FIXTURE RETURNS TO LOW. DURATION PERIOD IS SET AT FACTORY TO 15 MINUTES.

1. LIGHTING FIXTURES SHALL BE FURNISHED COMPLETE WITH ALL HARDWARE, LAMPS, HANGERS, ACCESSORIES, ETC. FOR A COMPLETE AND PROPER INSTALLATION.

2. THE MANUFACTURER'S AND CATALOG NUMBERS IDENTIFIED IN THIS LIGHTING FIXTURE SCHEDULE ARE INTENDED TO ESTABLISH A GENERAL LEVEL OF QUALITY, CONFIGURATION, MATERIALS, AND APPEARANCE REQUIRED. THIS IS NOT A PROPRIETARY SPECIFICATION AND IT SHOULD BE NOTED THAT "OR EQUAL" APPLIES TO ALL LIGHTING FIXTURES DENOTED HEREIN. IT IS UNDERSTOOD THAT ALL MANUFACTURER'S AS AN APPEARANCE, AND PRODUCT SPECIFICATIONS AND SUCH MINOR VARIATIONS SHALL NOT ELIMINATE SUCH MANUFACTURER'S AS AN APPEARANCE, AND PRODUCT SPECIFICATIONS AND SUCH MINOR VARIATIONS SHALL NOT ELIMINATE SUCH MANUFACTURER'S AS AN APPEARANCE, AND PRODUCT SPECIFICATIONS AND SUCH MINOR VARIATIONS SHALL NOT ELIMINATE SUCH MANUFACTURER'S AS AN APPEARANCE, AND PRODUCT SPECIFICATIONS AND SUCH MINOR VARIATIONS SHALL NOT ELIMINATE SUCH MANUFACTURER'S AS AN APPEARANCE, AND PRODUCT SPECIFICATIONS AND SUCH MINOR VARIATIONS SHALL NOT ELIMINATE SUCH MANUFACTURER'S AS AN APPEARANCE, AND PRODUCT SPECIFICATIONS AND SUCH MINOR VARIATIONS SHALL NOT ELIMINATE SUCH MANUFACTURER'S AS AN APPEARANCE, AND PRODUCT SPECIFICATIONS AND SUCH MINOR VARIATIONS SHALL NOT ELIMINATE SUCH MANUFACTURER'S AS AN APPEARANCE AND PRODUCT SPECIFICATIONS AND SUCH MINOR VARIATIONS SHALL NOT ELIMINATE SUCH MANUFACTURER'S AS AN APPEARANCE AND PRODUCT SPECIFICATIONS AND SUCH MINOR VARIATIONS SHALL NOT ELIMINATE SUCH MANUFACTURER'S AS AN APPEARANCE AND PRODUCT SPECIFICATIONS AND SUCH MINOR VARIATIONS AND SUC

APPROVED EQUAL.

3. LIGHTING FIXTURES SHALL CONFORM TO THE REQUIREMENTS OF THE ELECTRIC UTILITY CO. REBATE PROGRAM, WHERE APPLICABLE.

4. MOUNTING ABBREVIATIONS, "RW" = RECESSED IN WALL, "S/W" = SURFACE/WALL, "P" = POLE, "G" = GROUND, PT = POST TOP.

5. REFER TO TECHNOLOGY DRAWINGS. COORDINATE EXACT MOUNTING LOCATION AND ORIENTATION OF ALL CAMERAS AND ASSOCIATED MOUNTING ARMS WITH ARCHITECT/ ENGINEER PRIOR TO INSTALLATION.
6. POLE LENGTH SHALL BE AS REQUIRED SO THAT BOTTOM OF LIGHTING FIXTURE IS AT 30' ABOVE FINISHED GRADE, TAKING INTO ACCOUNT LIGHTING FIXTURE, ARM, POLE, POLE BASE, AND CONCRETE POLE BASE. PROVIDE ELEVATION INCLUDING ALL DIMENSIONS DURING SUBMITTAL PHASE FOR REVIEW.
7. POLE LENGTH SHALL BE AS REQUIRED SO THAT BOTTOM OF LIGHTING FIXTURE IS AT 12' ABOVE FINISHED GRADE, TAKING INTO ACCOUNT LIGHTING FIXTURE, ARM, POLE, POLE BASE, AND CONCRETE POLE BASE. PROVIDE ELEVATION INCLUDING ALL DIMENSIONS DURING SUBMITTAL PHASE FOR REVIEW.
8. LIGHTING FIXTURE WILL DIM TO 50% POWER, 50% LIGHT OUTPUT, PER DIMMING PROFILE. IF MOTION IS DETECTED DURING THE TIME THAT THE LIGHTING FIXTURE IS OPERATING AT 50%, THE LIGHTING FIXTURE GOES TO 100% POWER AND LIGHT OUTPUT. THE LIGHTING FIXTURE REMAINS ON HIGH UNTIL NO

TYPE	MANUFACTURER	CATALOG NUMBER	VOLTAGE	MOUNTING	WATTAGE	TOTAL LUMENS	COLOR TEMP.	DIMMING (%)	BUG	DISTRIBUTION TYPE	DESCRIPTION/REMARKS	COLOR/ FINISH
SL1-T3 NL	S LIGHTING	VSS-1-T3-32L-1-30K7-UNV-CBA-PC-FSP-20-RPA5	UNV	Р	106	10600	3000K	0-10V	B2 U0 G2	III	SINGLE HEAD PARKING/ROAD SITE LIGHTING FIXTURE, PHOTOCELL, ARM, ON 20'-0" (SEE NOTE 6), 6" ROUND STEEL POLE. COLOR/FINISH BY ARCHITECT. PROVIDE INTEGRAL MOTION SENSOR (SEE NOTE 8). PROVIDE WITH 3" X 5" HANDHOLE.	СВА
SL1-T4 NL	S LIGHTING	VSS-1-T4-32L-1-30K7-UNV-CBA-PC-FSP-20-RPA5	UNV	Р	106	10812	3000K	0-10V	B2 U0 G2	IV	SINGLE HEAD PARKING/ROAD SITE LIGHTING FIXTURE, PHOTOCELL, ARM, ON 20'-0" (SEE NOTE 6), 6" ROUND STEEL POLE. COLOR/FINISH BY ARCHITECT. PROVIDE INTEGRAL MOTION SENSOR (SEE NOTE 8). PROVIDE WITH 3" X 5" HANDHOLE.	СВА
SL1-T4C NL	S LIGHTING	VSS-1-T4-32L-1-30K7-UNV-CBA-PC-FSP-20-RPA5	UNV	Р	106	10812	3000K	0-10V	B2 U0 G2	IV	SINGLE HEAD PARKING/ROAD SITE LIGHTING FIXTURE, PHOTOCELL, ARM, AND CAMERA(S) ON 20'-0" (SEE NOTE 6), 6" ROUND STEEL POLE. COLOR/FINISH BY ARCHITECT. PROVIDE INTEGRAL MOTION SENSOR (SEE NOTE 8). PROVIDE WITH 3" X 5" HANDHOLE.	СВА
SLP-T4 NL	S LIGHTING	HRZ-1-T4-32L-1-30K7-UNV-PTXXX-CBA-PC-FSP-20	UNV	Р	106	10715	3000K	0-10V	B2 U0 G2	IV	SINGLE HEAD POST TOP PATHWAY SITE LIGHTING FIXTURE, PHOTOCELL, ON 12'-0" (SEE NOTE 7), 4" ROUND STEEL POLE. COLOR/FINISH BY ARCHITECT. PROVIDE INTEGRAL MOTION SENSOR (SEE NOTE 8). PROVIDE WITH 3" X 5" HANDHOLE.	СВА
SLP-T5 NL	S LIGHTING	HRZ-1-T5-32L-1-30K7-UNV-PTXXX-CBA-PC-FSP-20	UNV	Р	106	11130	3000K	0-10V	B4 U0 G2	V	SINGLE HEAD POST TOP PATHWAY SITE LIGHTING FIXTURE, PHOTOCELL, ON 12'-0" (SEE NOTE 7), 4" ROUND STEEL POLE. COLOR/FINISH BY ARCHITECT. PROVIDE INTEGRAL MOTION SENSOR (SEE NOTE 8). PROVIDE WITH 3" X 5" HANDHOLE.	СВА
SLB NL	S LIGHTING	SSD-3-6R-COG45-16L-35-30K7-UNV-AB-CBA-VRB	UNV	G	17	945	3000K	0-10V	B1 U3 G1	V	36" BOLLARD LIGHTING FIXTURE, VANDAL RESISTANT, ROUND BASE WITH ROUND TOP, LOUVERED ACRYLIC LENS WITH 45 DEGREE CUTOFF GRILL.	СВА
SLF NL	S LIGHTING	NV-F1-55-16L-20W-30K8-UNV-KM-ECL	UNV	Р	20	1740	3000K	0-10V	-	-	TOP OF FLAG POLE, DARK SKY FRIENDLY, 6"X7" LIGHTING FIXTURE, WITH KNUCKLE MOUNT, EGG CRATE LOUVER. TWO TYPE SLF LIGHTING FIXTURES SHALL BE MOUNTED AT THE TOP OF EACH FLAG POLE DIRECTLY MOUNTED TO THE FLAG POLE.	СВА



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CENTRAL FALLS SCHOOL DISTRICT

CENTRAL FALLS HIGH SCHOOL

10 HIGGINSON AVE, CENTRAL FALLS, RI

KEYNOTE LEGEND:

KEYPLAN

ADDENDUM 7

100% CONSTRUCTION DOCUMENTS

KEY PLAN NORTH ARROW I

ELECTRICAL LIGHTING FIXTURE


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REVIEWED BY:

SCALE:

NONE DRAWING NUMBER:



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KEYNOTE LEGEND:

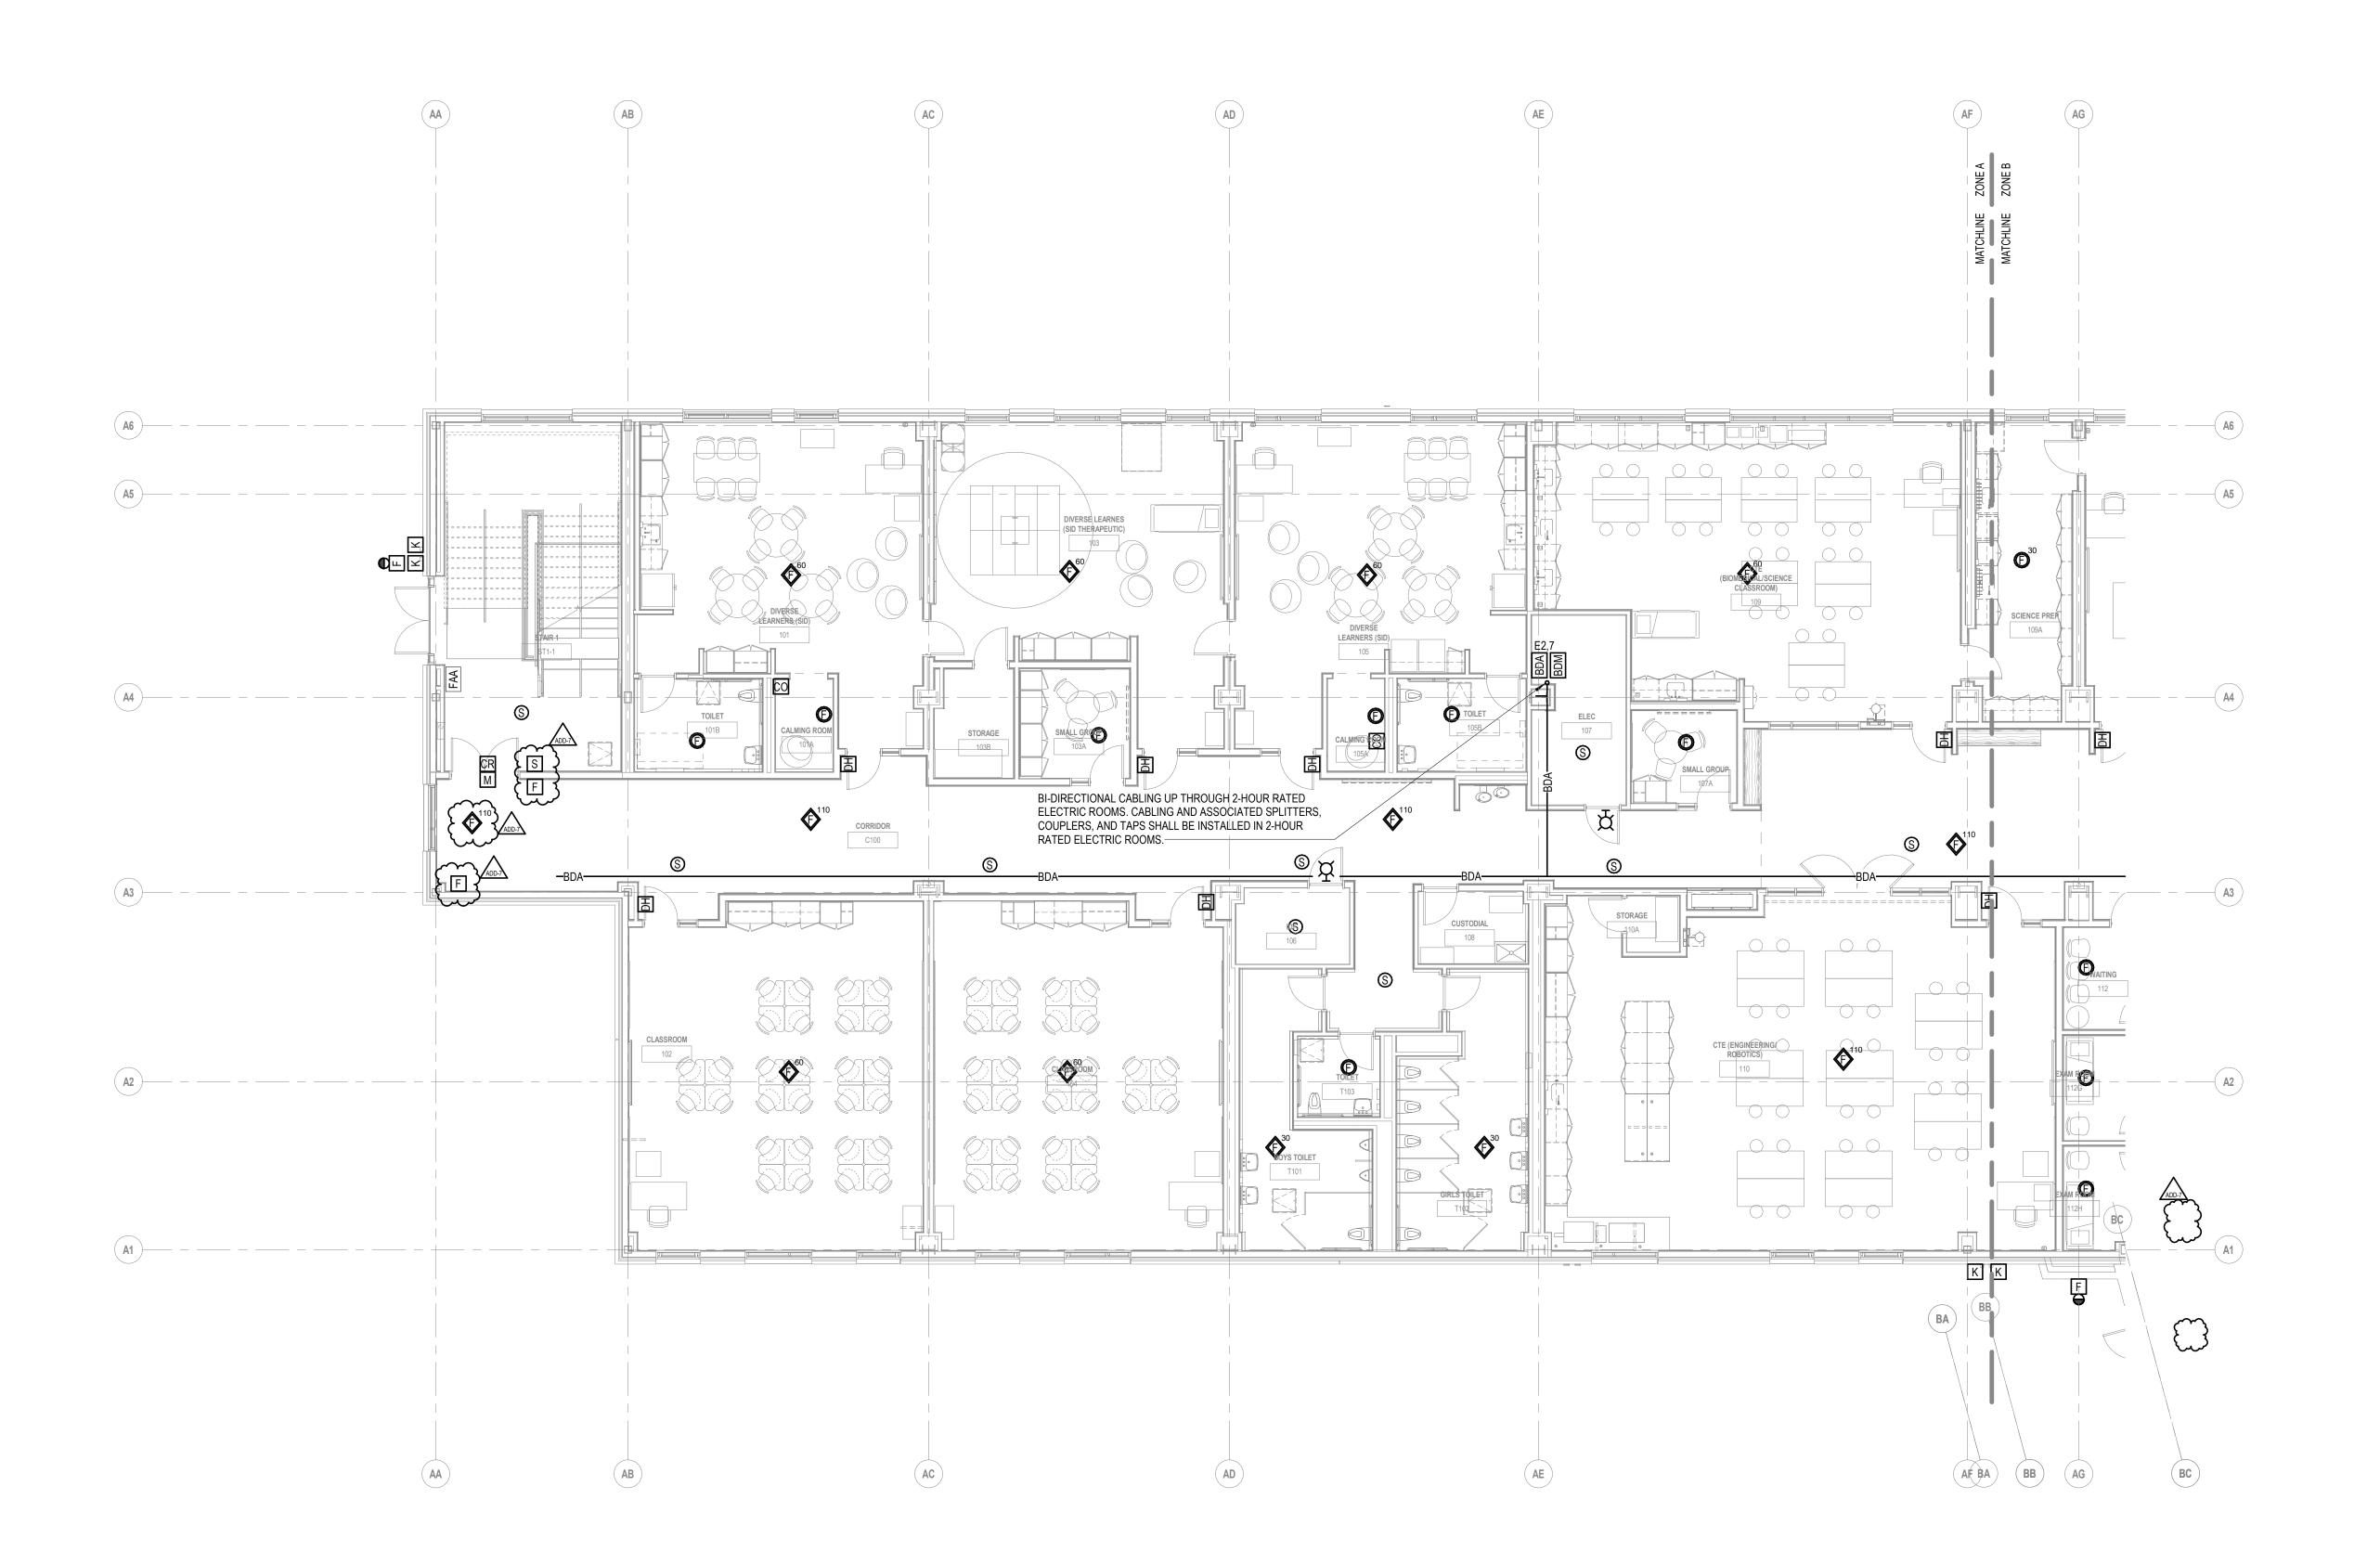
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ADD-7 ADDENDUM 7 1/26/2024

100% CONSTRUCTION DOCUMENTS

KEY PLAN NORTH ARROW

KEYPLAN

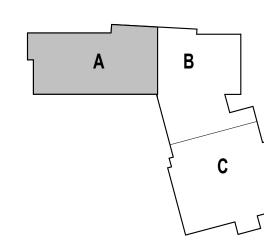

ELECTRICAL
FIRST FLOOR FIRE
ALARM PLAN ZONE A

DRAWN BY:

REVIEWED BY:

SCALE:

AS NOTED DRAWING NUMBER:

JOB NO.:

2202.02
DATE: OCTOBER 13, 2023

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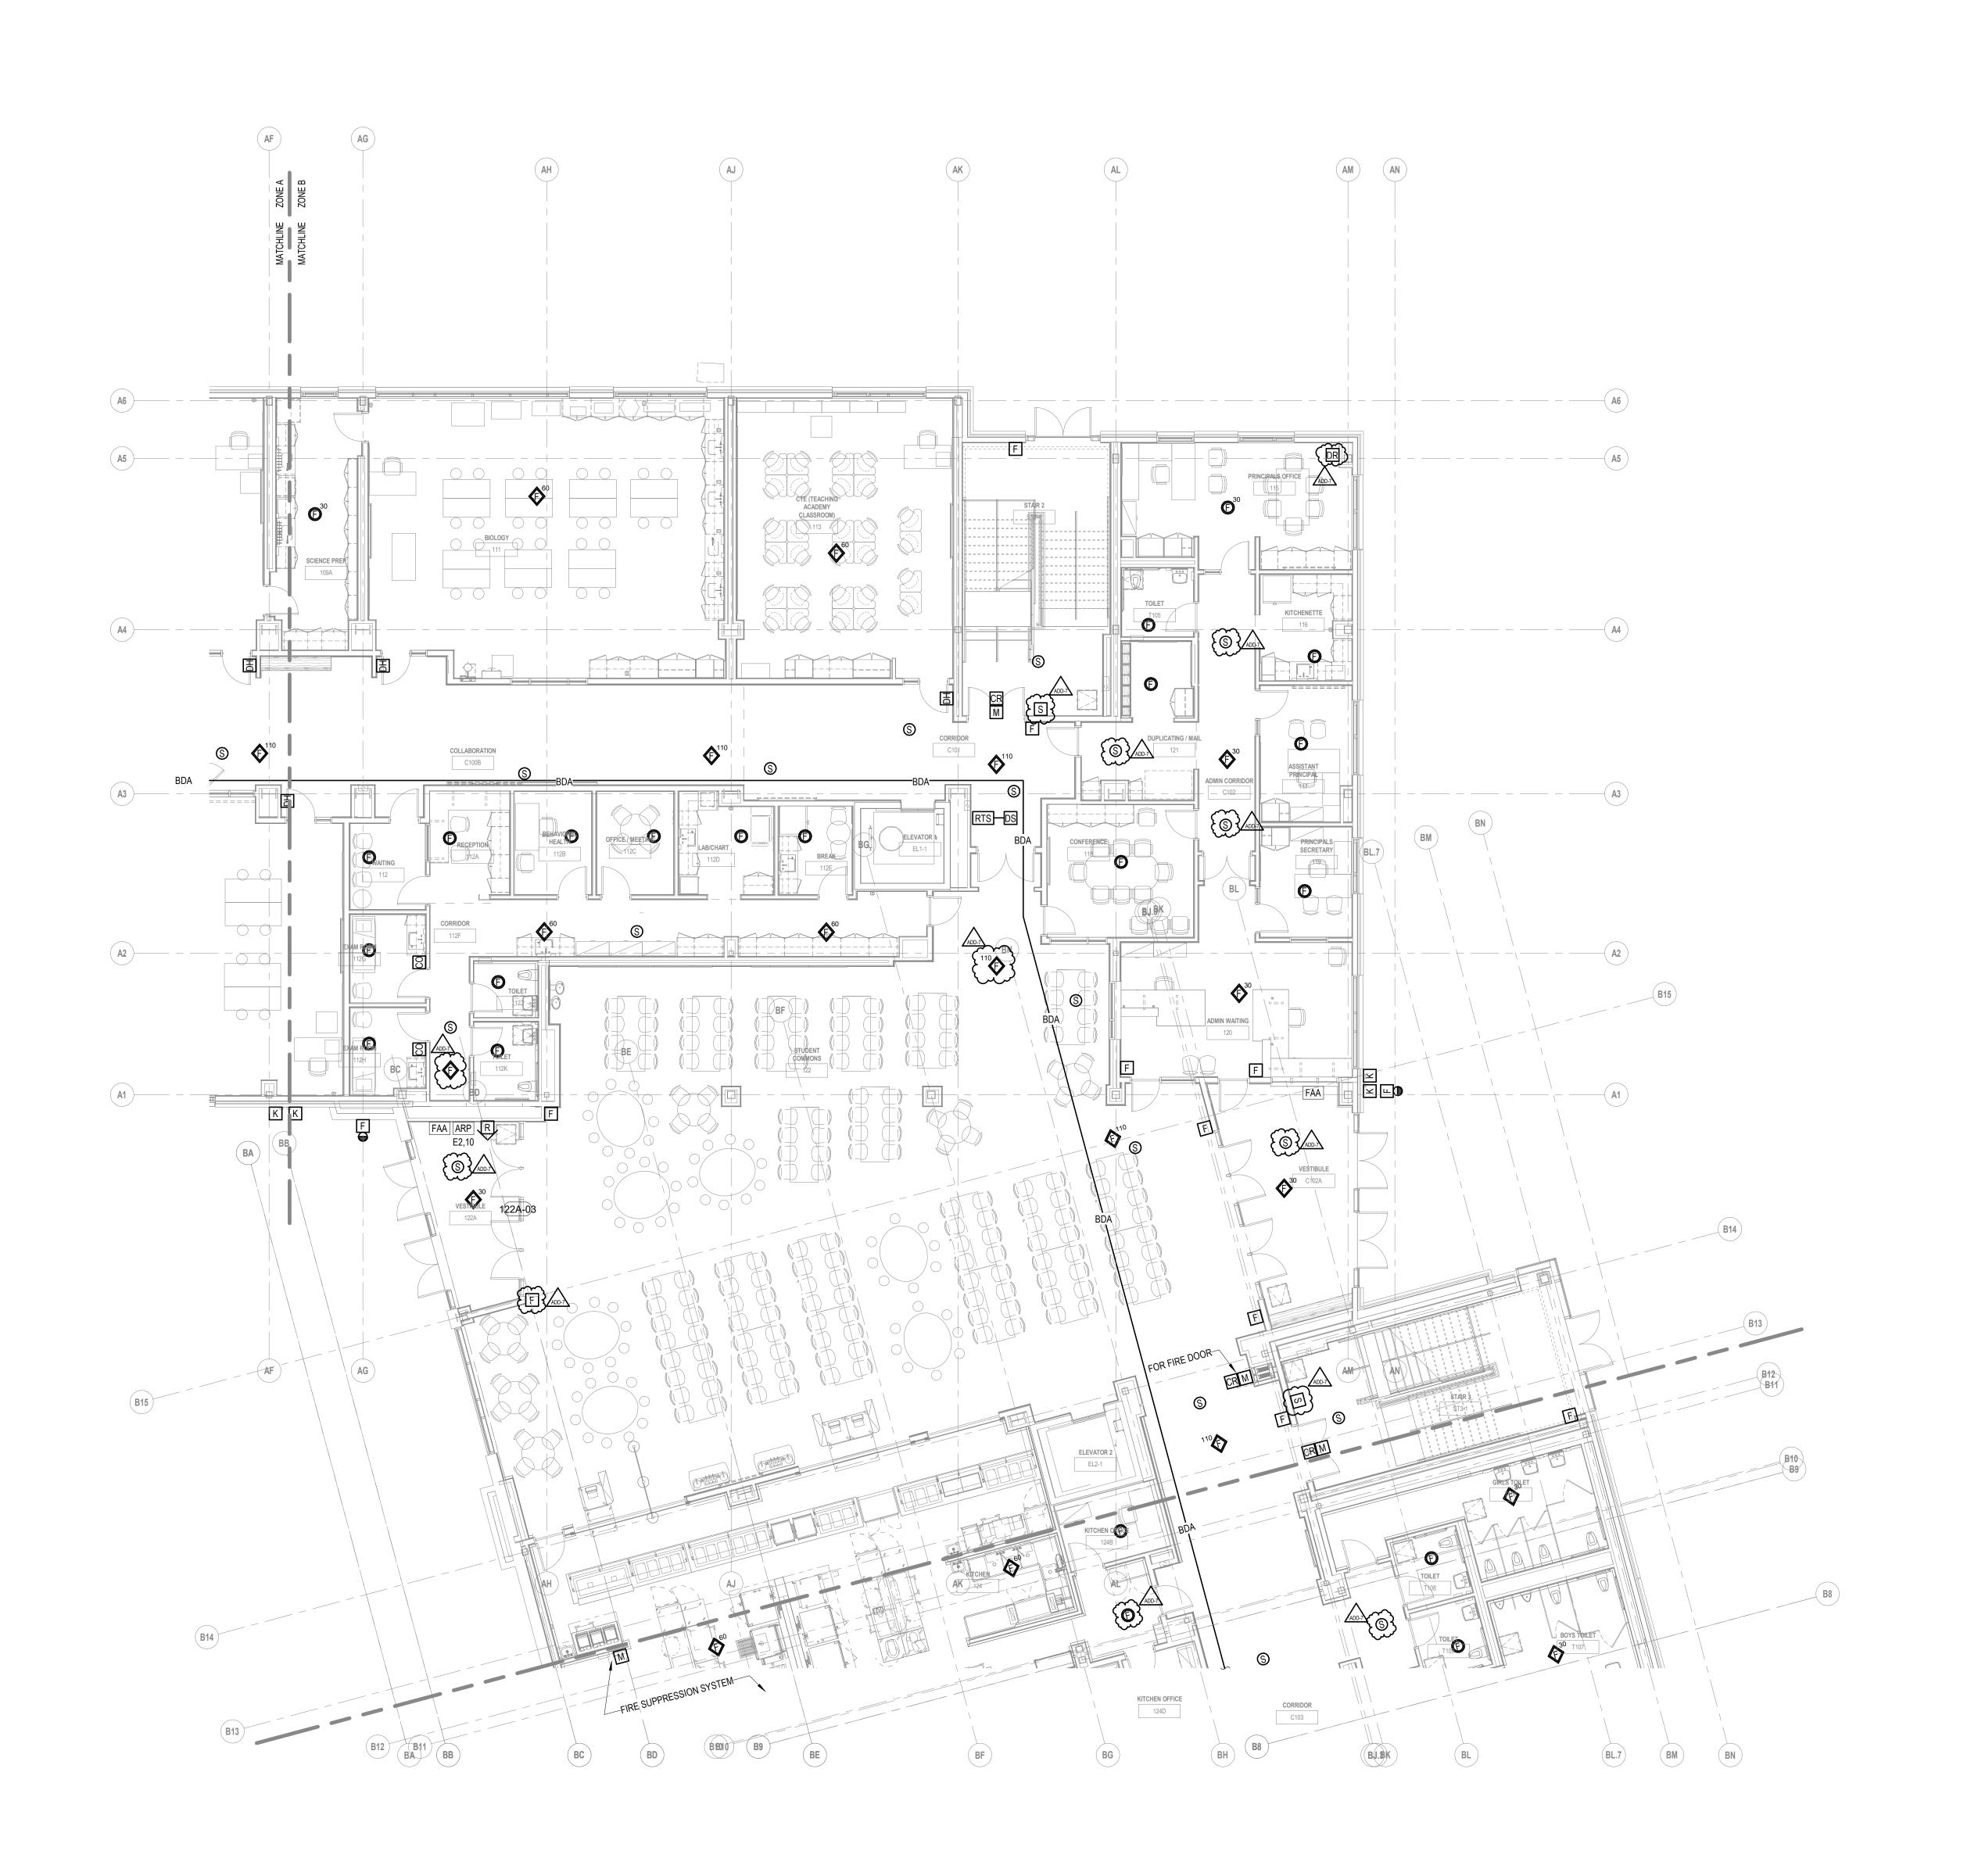
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AS NOTED DRAWING NUMBER:

JOB NO.:

2202.02
DATE: OCTOBER 13, 2023

1 FIRST FLOOR FIRE ALARM PLAN - ZONE A




Framingham, MA 01701

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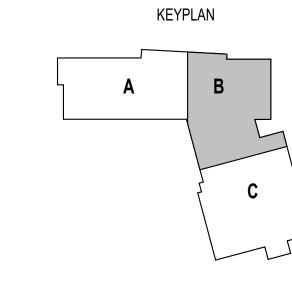
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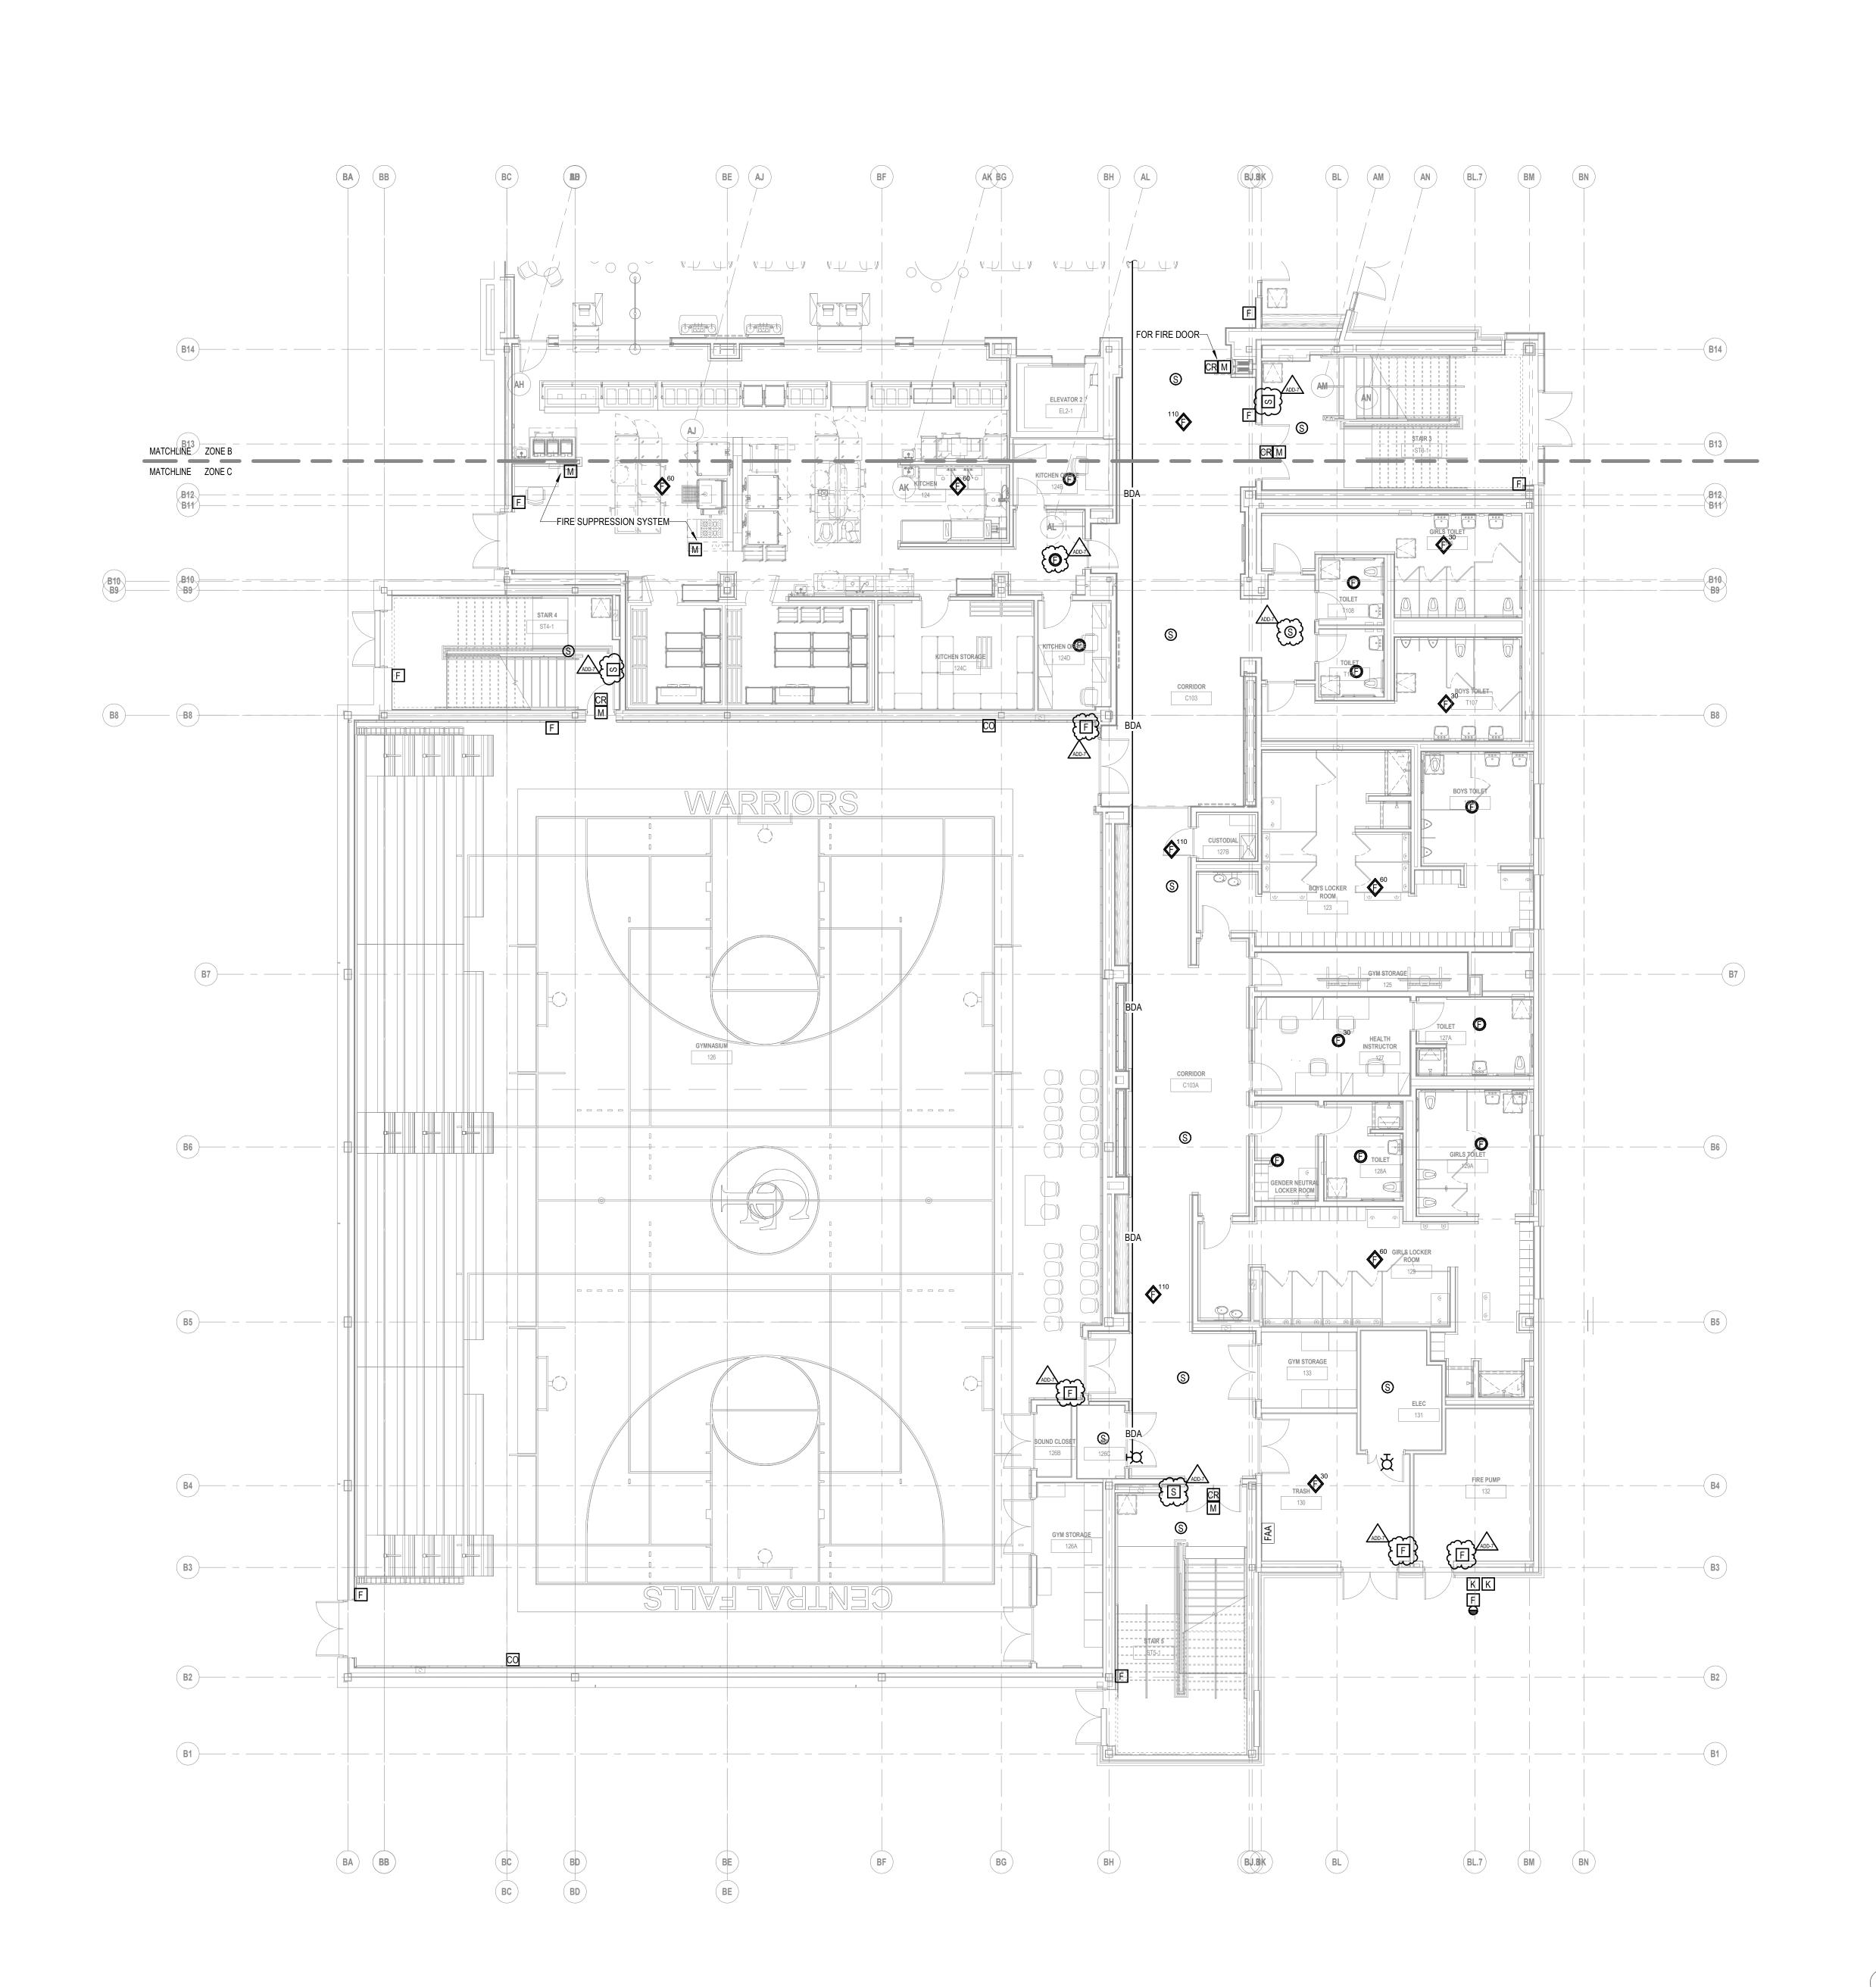
100% CONSTRUCTION DOCUMENTS KEY PLAN NORTH ARROW



DRAWING NAME: ELECTRICAL FIRST FLOOR FIRE ALARM PLAN -ZONE B

DRAWN BY: REVIEWED BY: SCALE: AS NOTED | DRAWING NUMBER: JOB NO.: 2202.02 EF3.11B

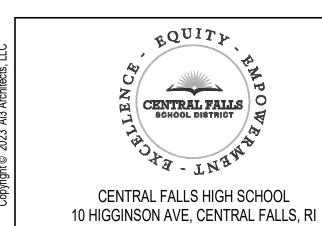1 FIRST FLOOR FIRE ALARM PLAN - ZONE B





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KEYNOTE LEGEND:

100% CONSTRUCTION DOCUMENTS KEY PLAN NORTH ARROW


KEYPLAN

DRAWING NAME: ELECTRICAL FIRST FLOOR FIRE ALARM PLAN -ZONE C

DRAWN BY: RBC/JAJ REVIEWED BY:

JOB NO.: 2202.02 EF3.11C

1 FIRST FLOOR FIRE ALARM PLAN - ZONE C SCALE: AS NOTED | DRAWING NUMBER:

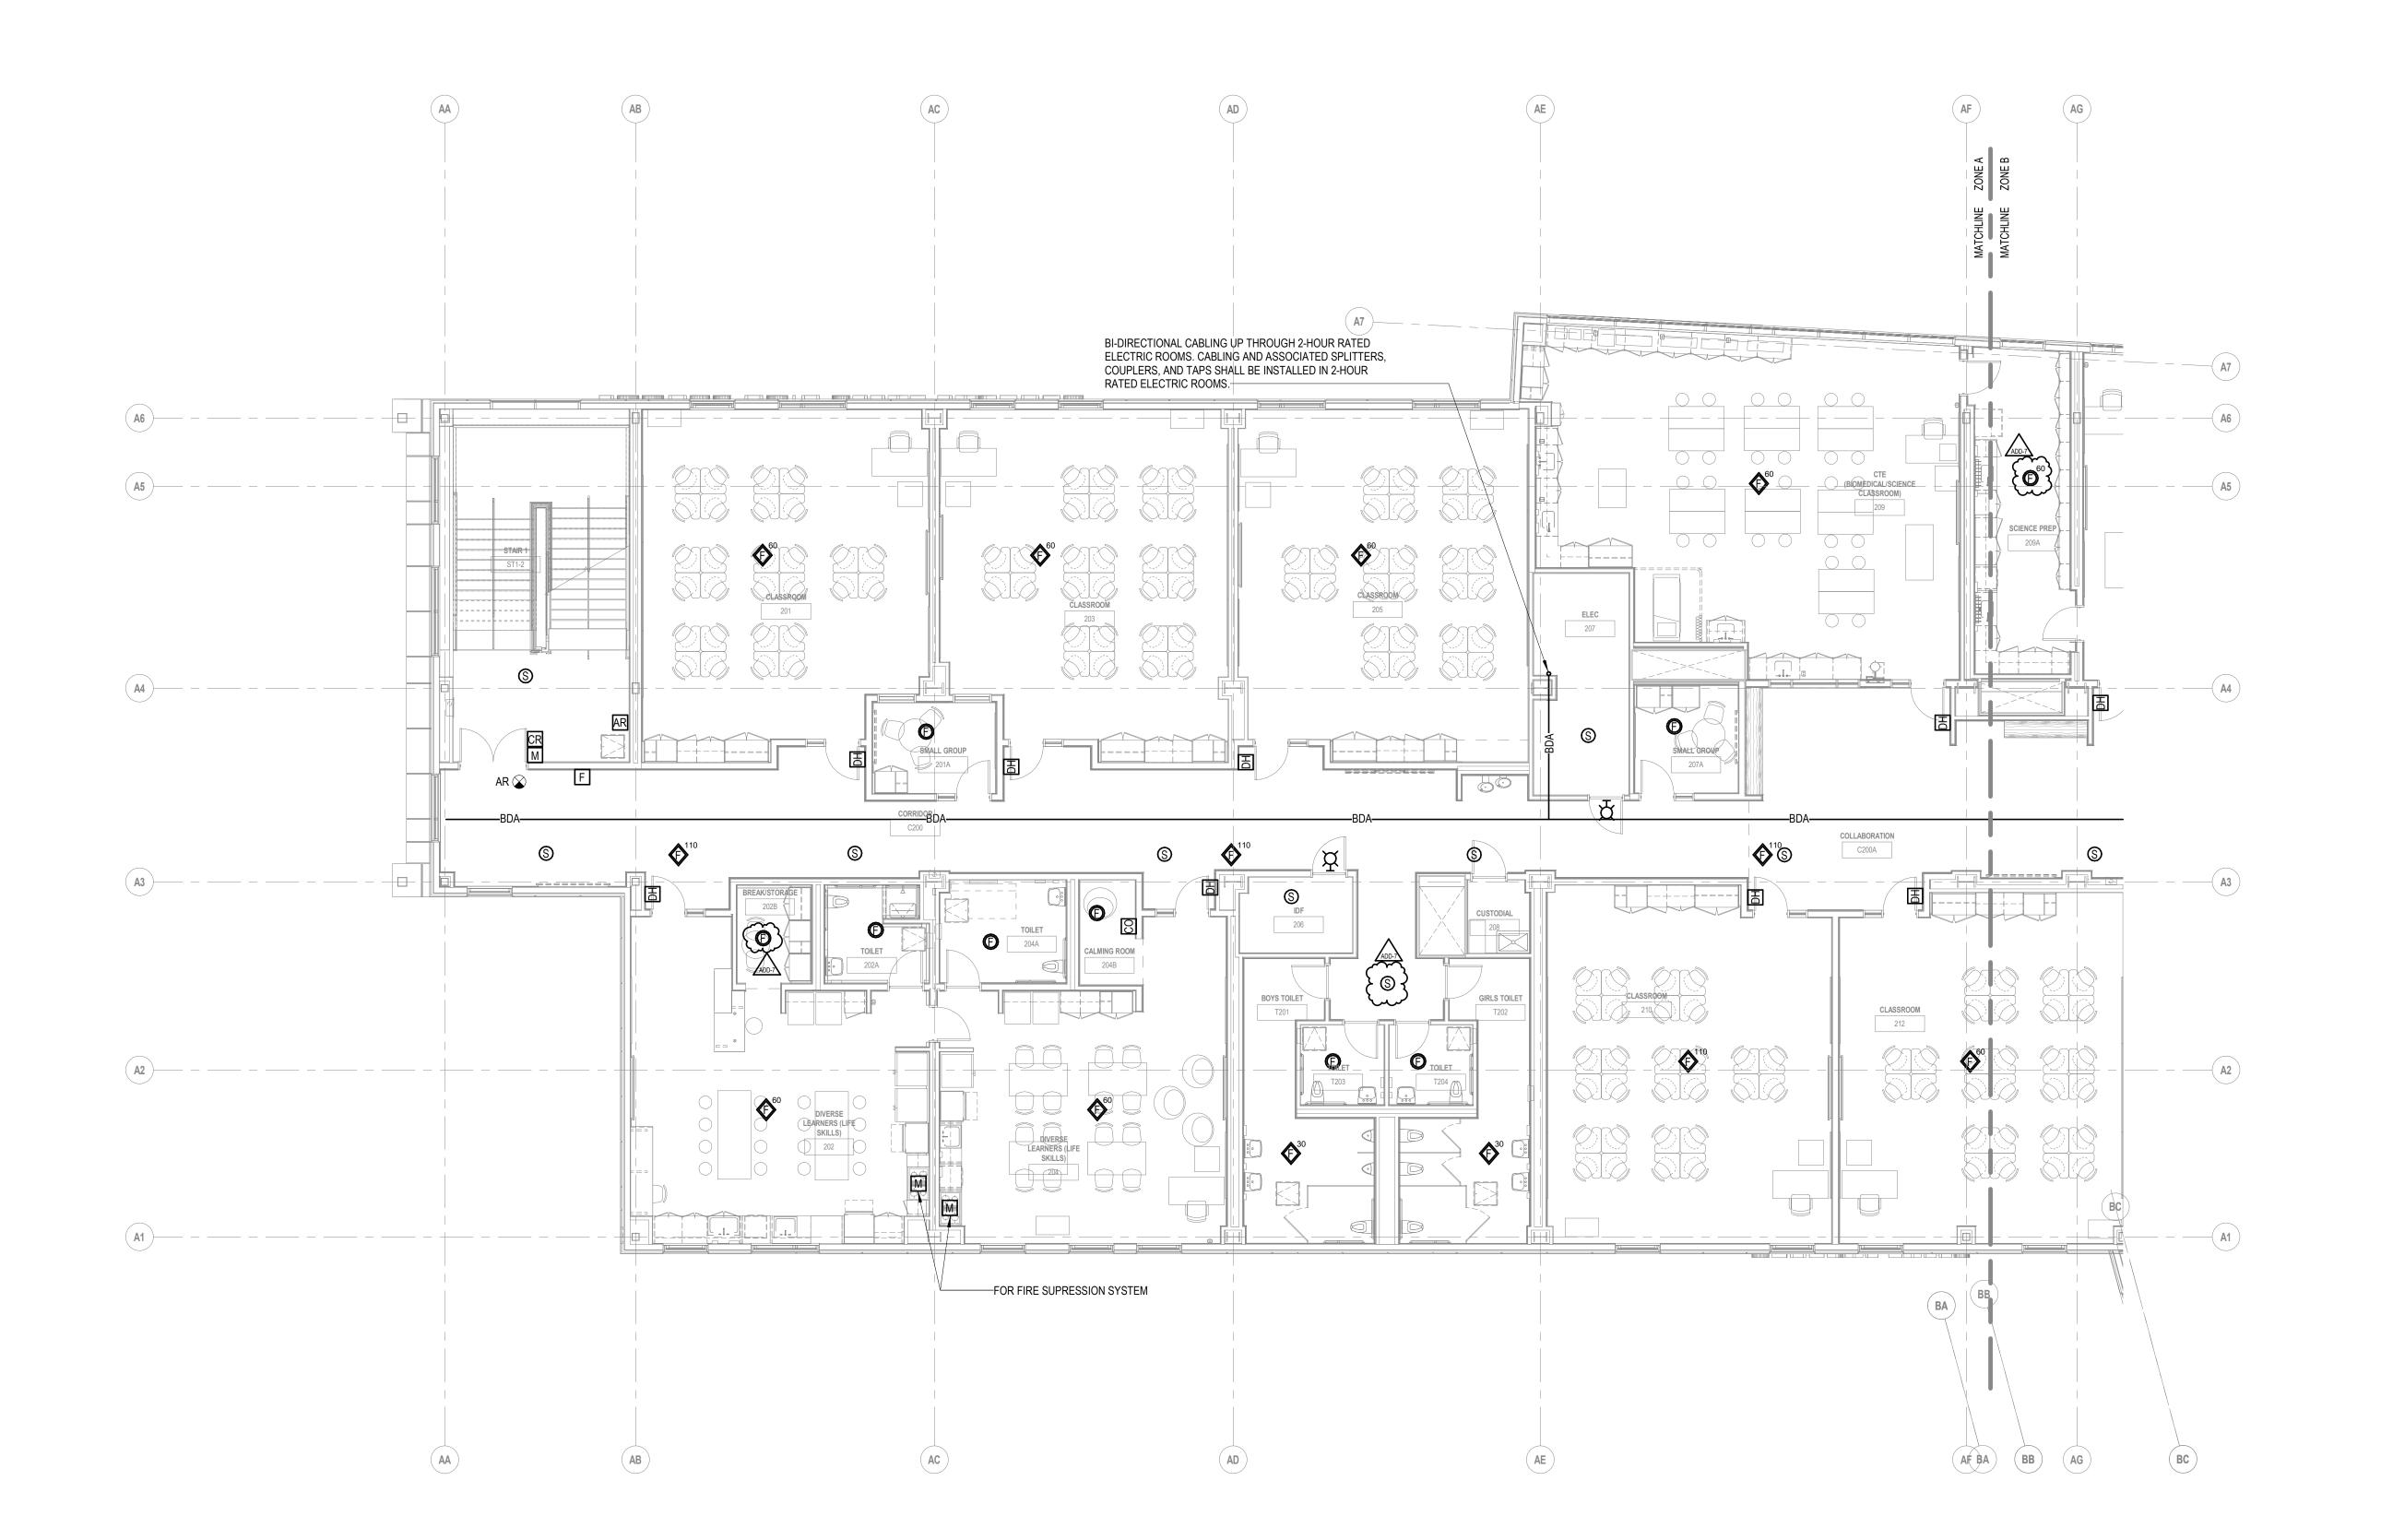

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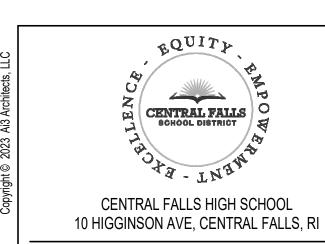
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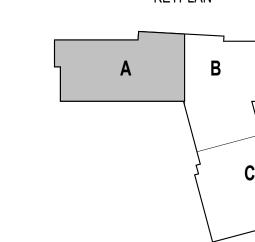
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ADD-7 ADDENDUM 7 1/26/2024

100% CONSTRUCTION DOCUMENTS

KEY PLAN NORTH ARROW

KEYPLAN



ELECTRICAL
SECOND FLOOR
FIRE ALARM PLAN
- ZONE A

DRAWN BY:

REVIEWED BY:

SCALE:

AS NOTED | DRAWING NUMBER:

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1 SECOND FLOOR FIRE ALARM PLAN - ZONE A



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KEY PLAN NORTH ARROW

KEYPLAN

A

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ELECTRICAL
SECOND FLOOR
FIRE ALARM PLAN

- ZONE B


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SCALE: AS NOTED DRAWING NUMBER:

JOB NO.: 2202.02
DATE: OCTOBER 13, 2023 EF3.12B

1 SECOND FLOOR FIRE ALARM PLAN - ZONE B
1/8" = 1'-0"




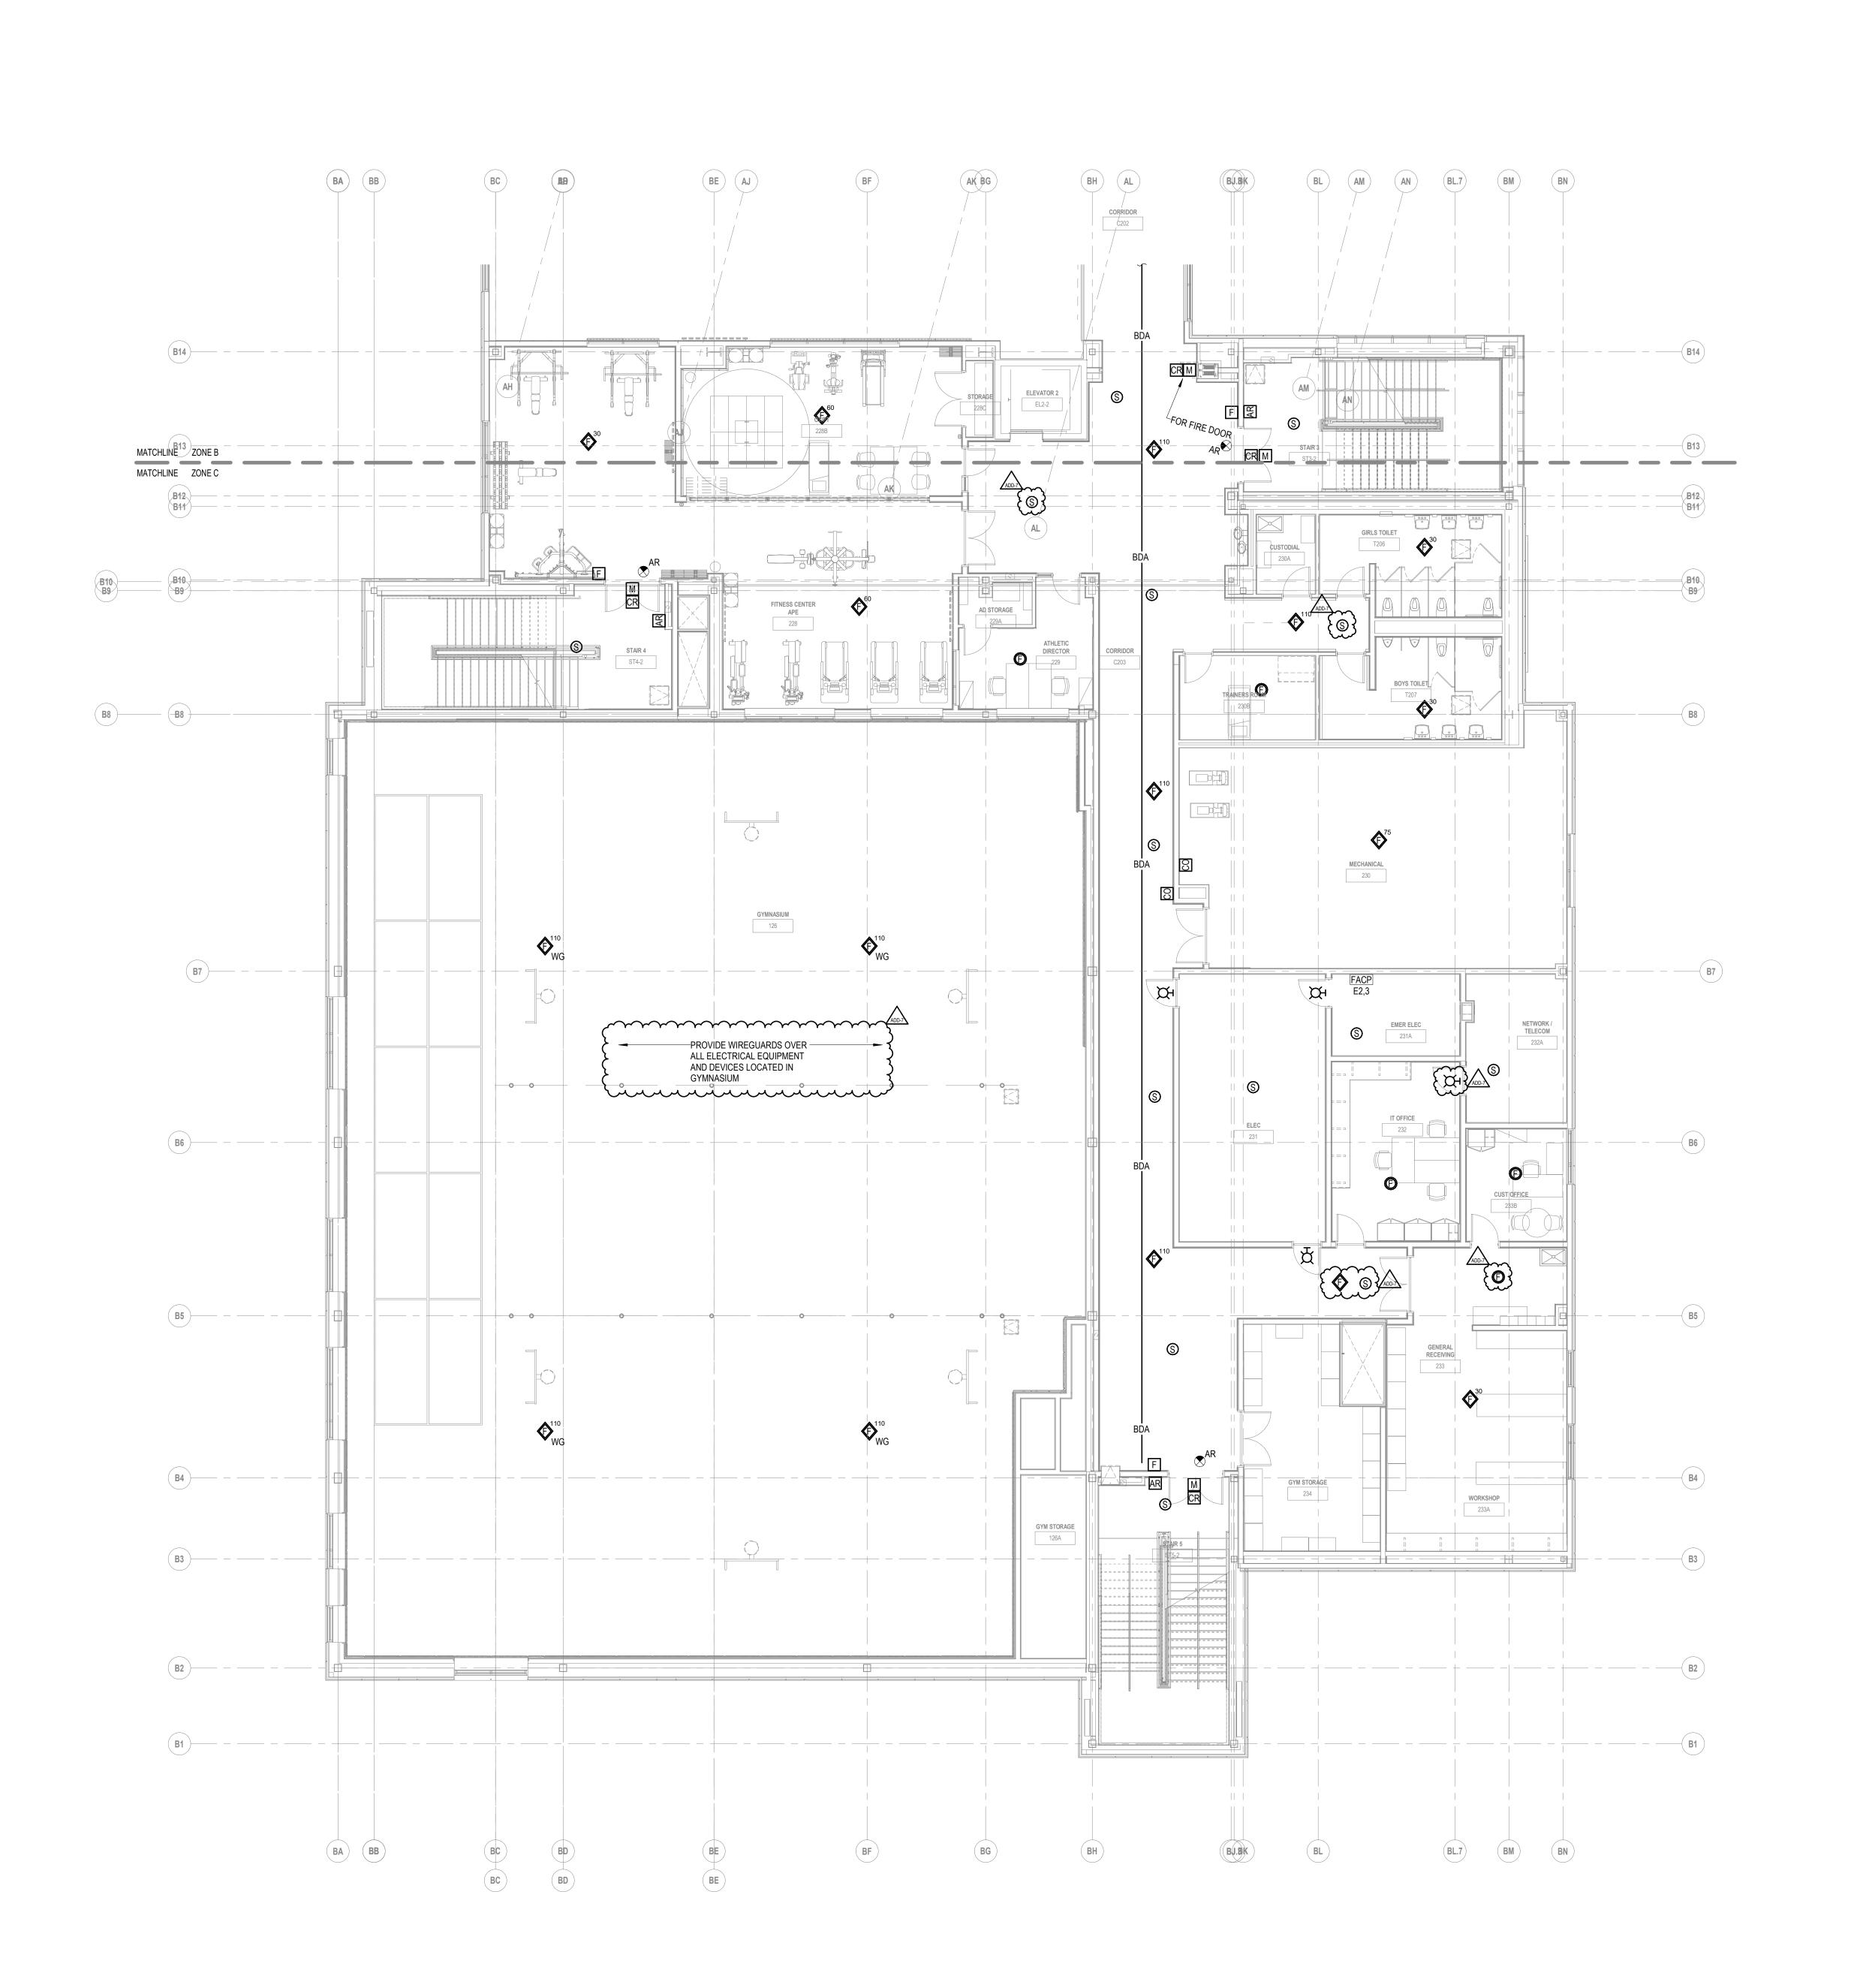

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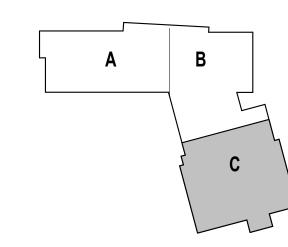
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KEYNOTE LEGEND:

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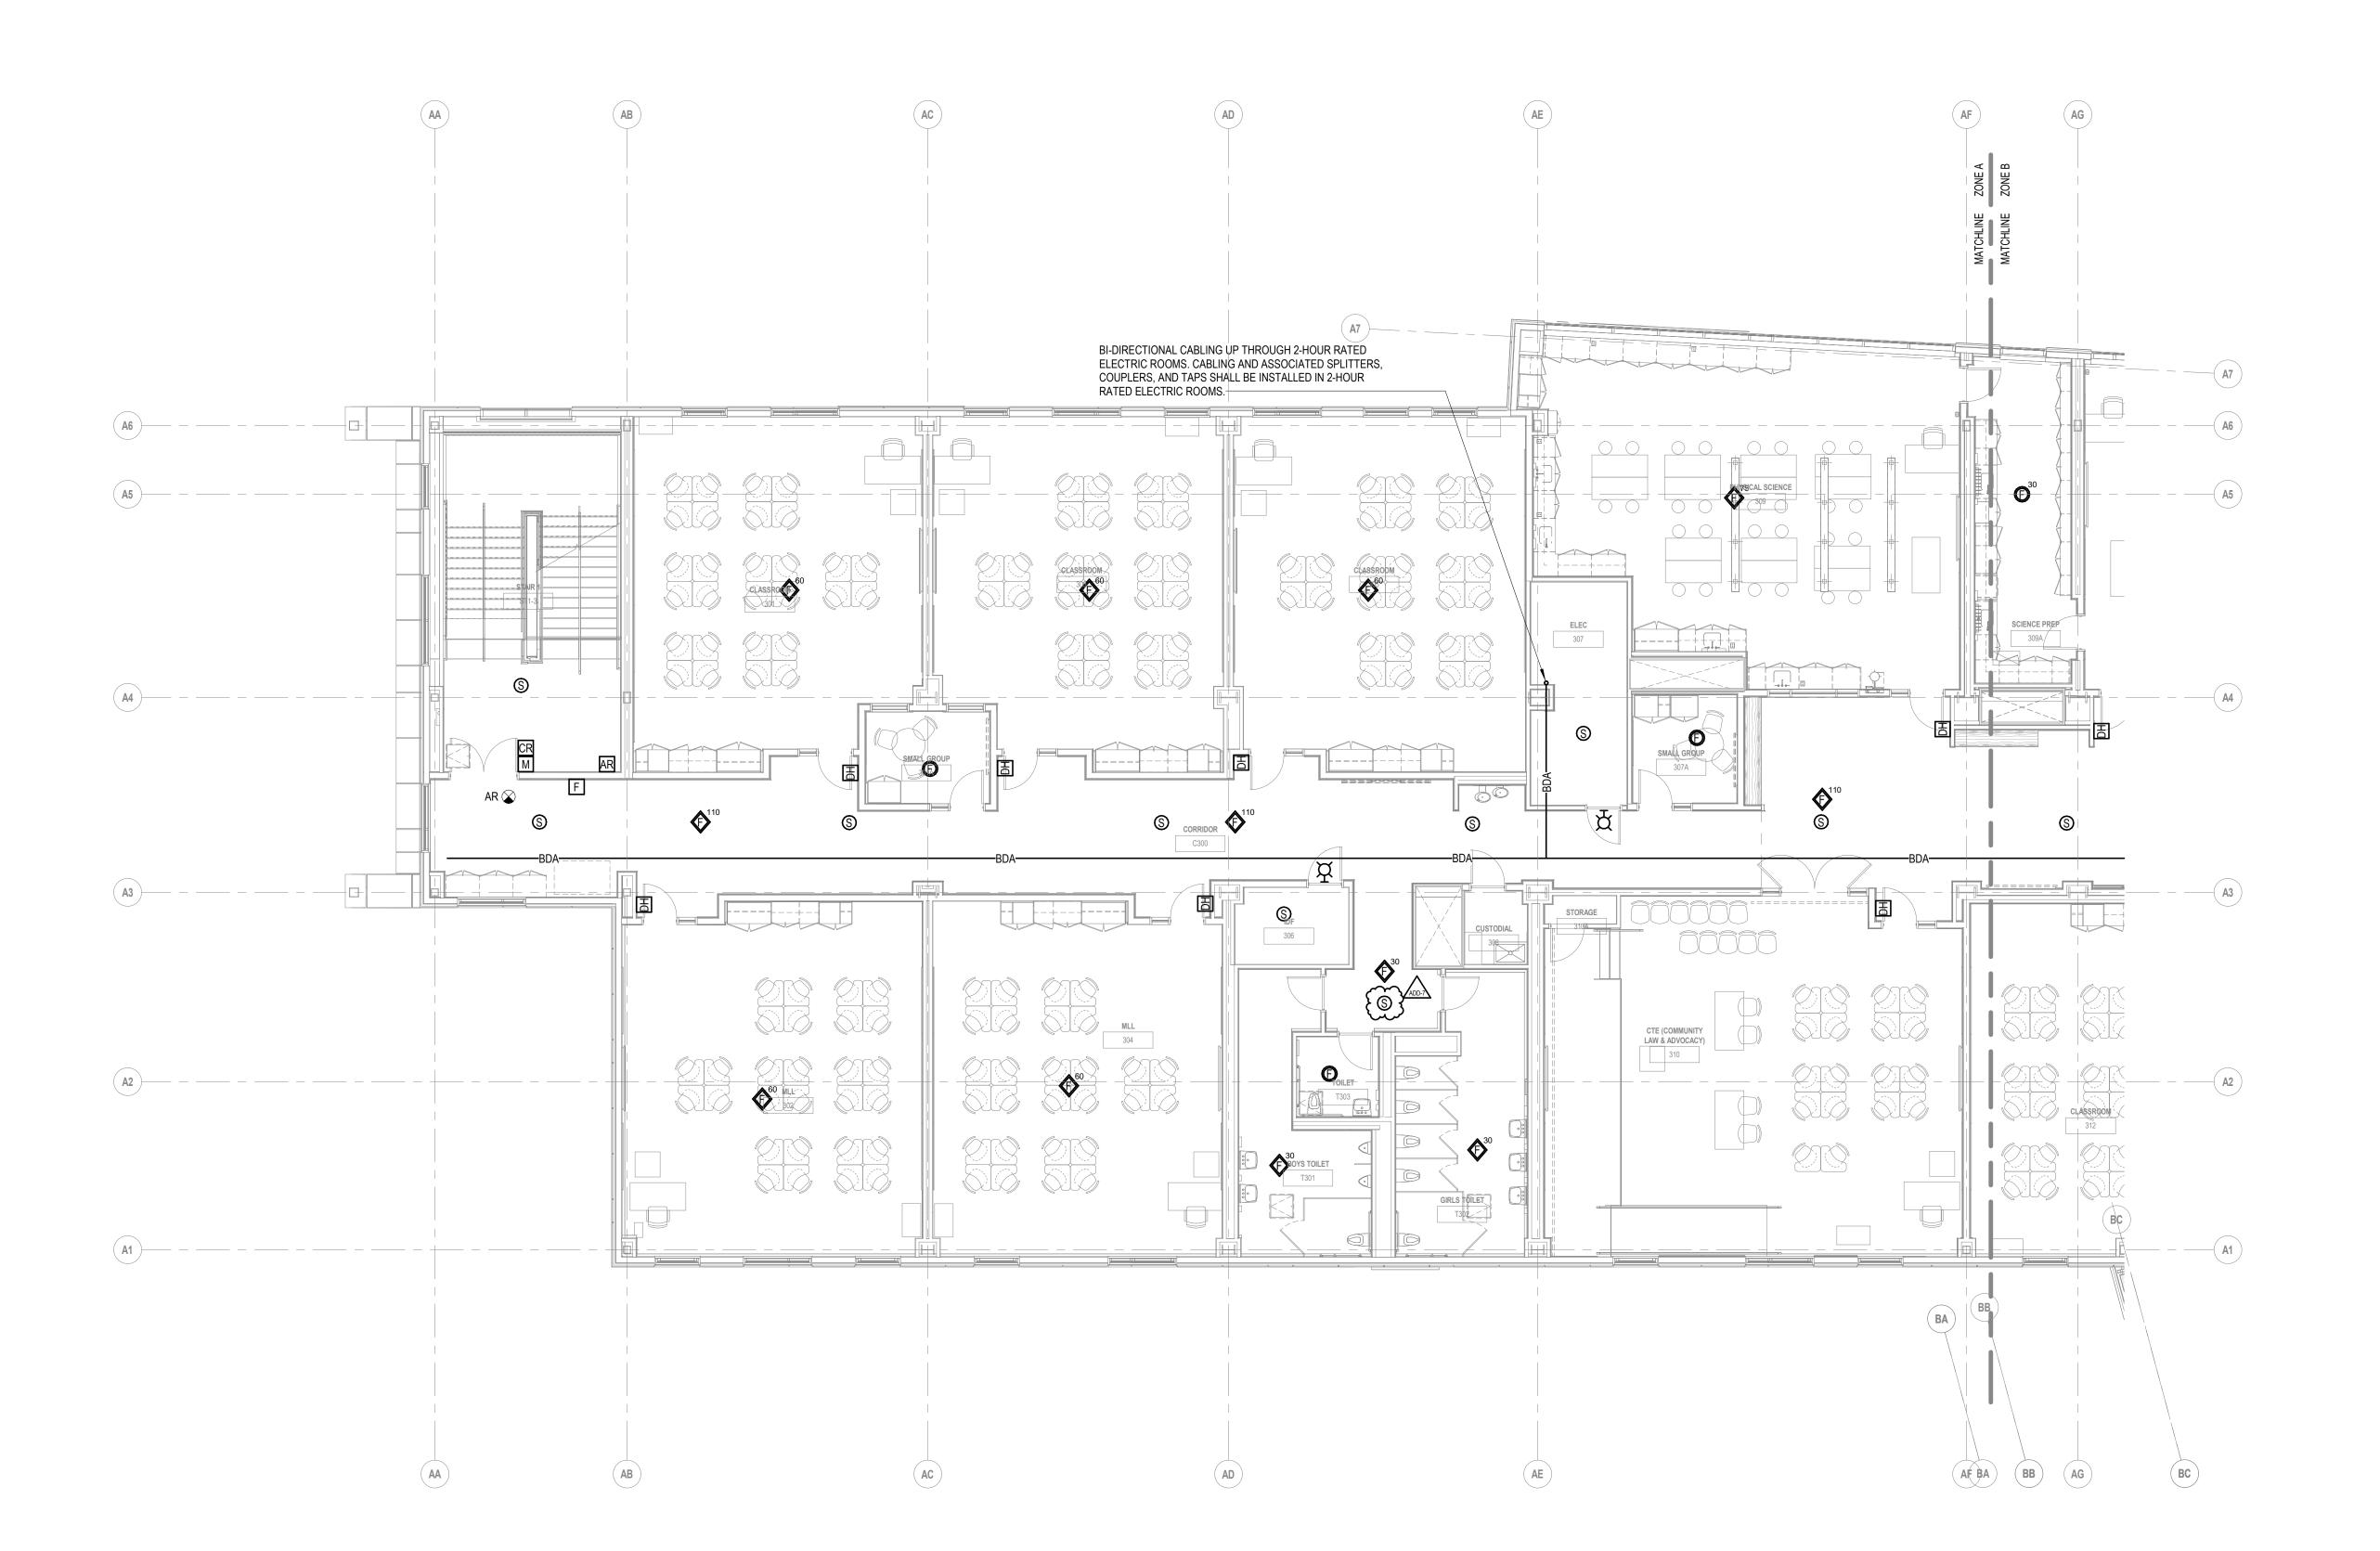
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DRAWING NAME: ELECTRICAL SECOND FLOOR FIRE ALARM PLAN - ZONE C

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1 SECOND FLOOR FIRE ALARM PLAN - ZONE C

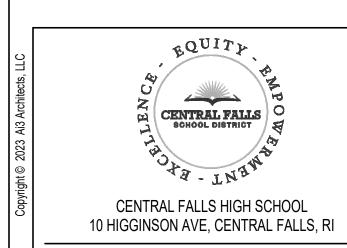

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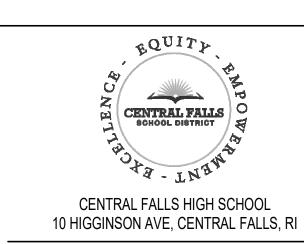
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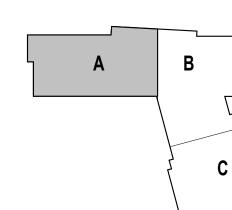
KEYNOTE LEGEND:

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KEY PLAN NORTH ARROW

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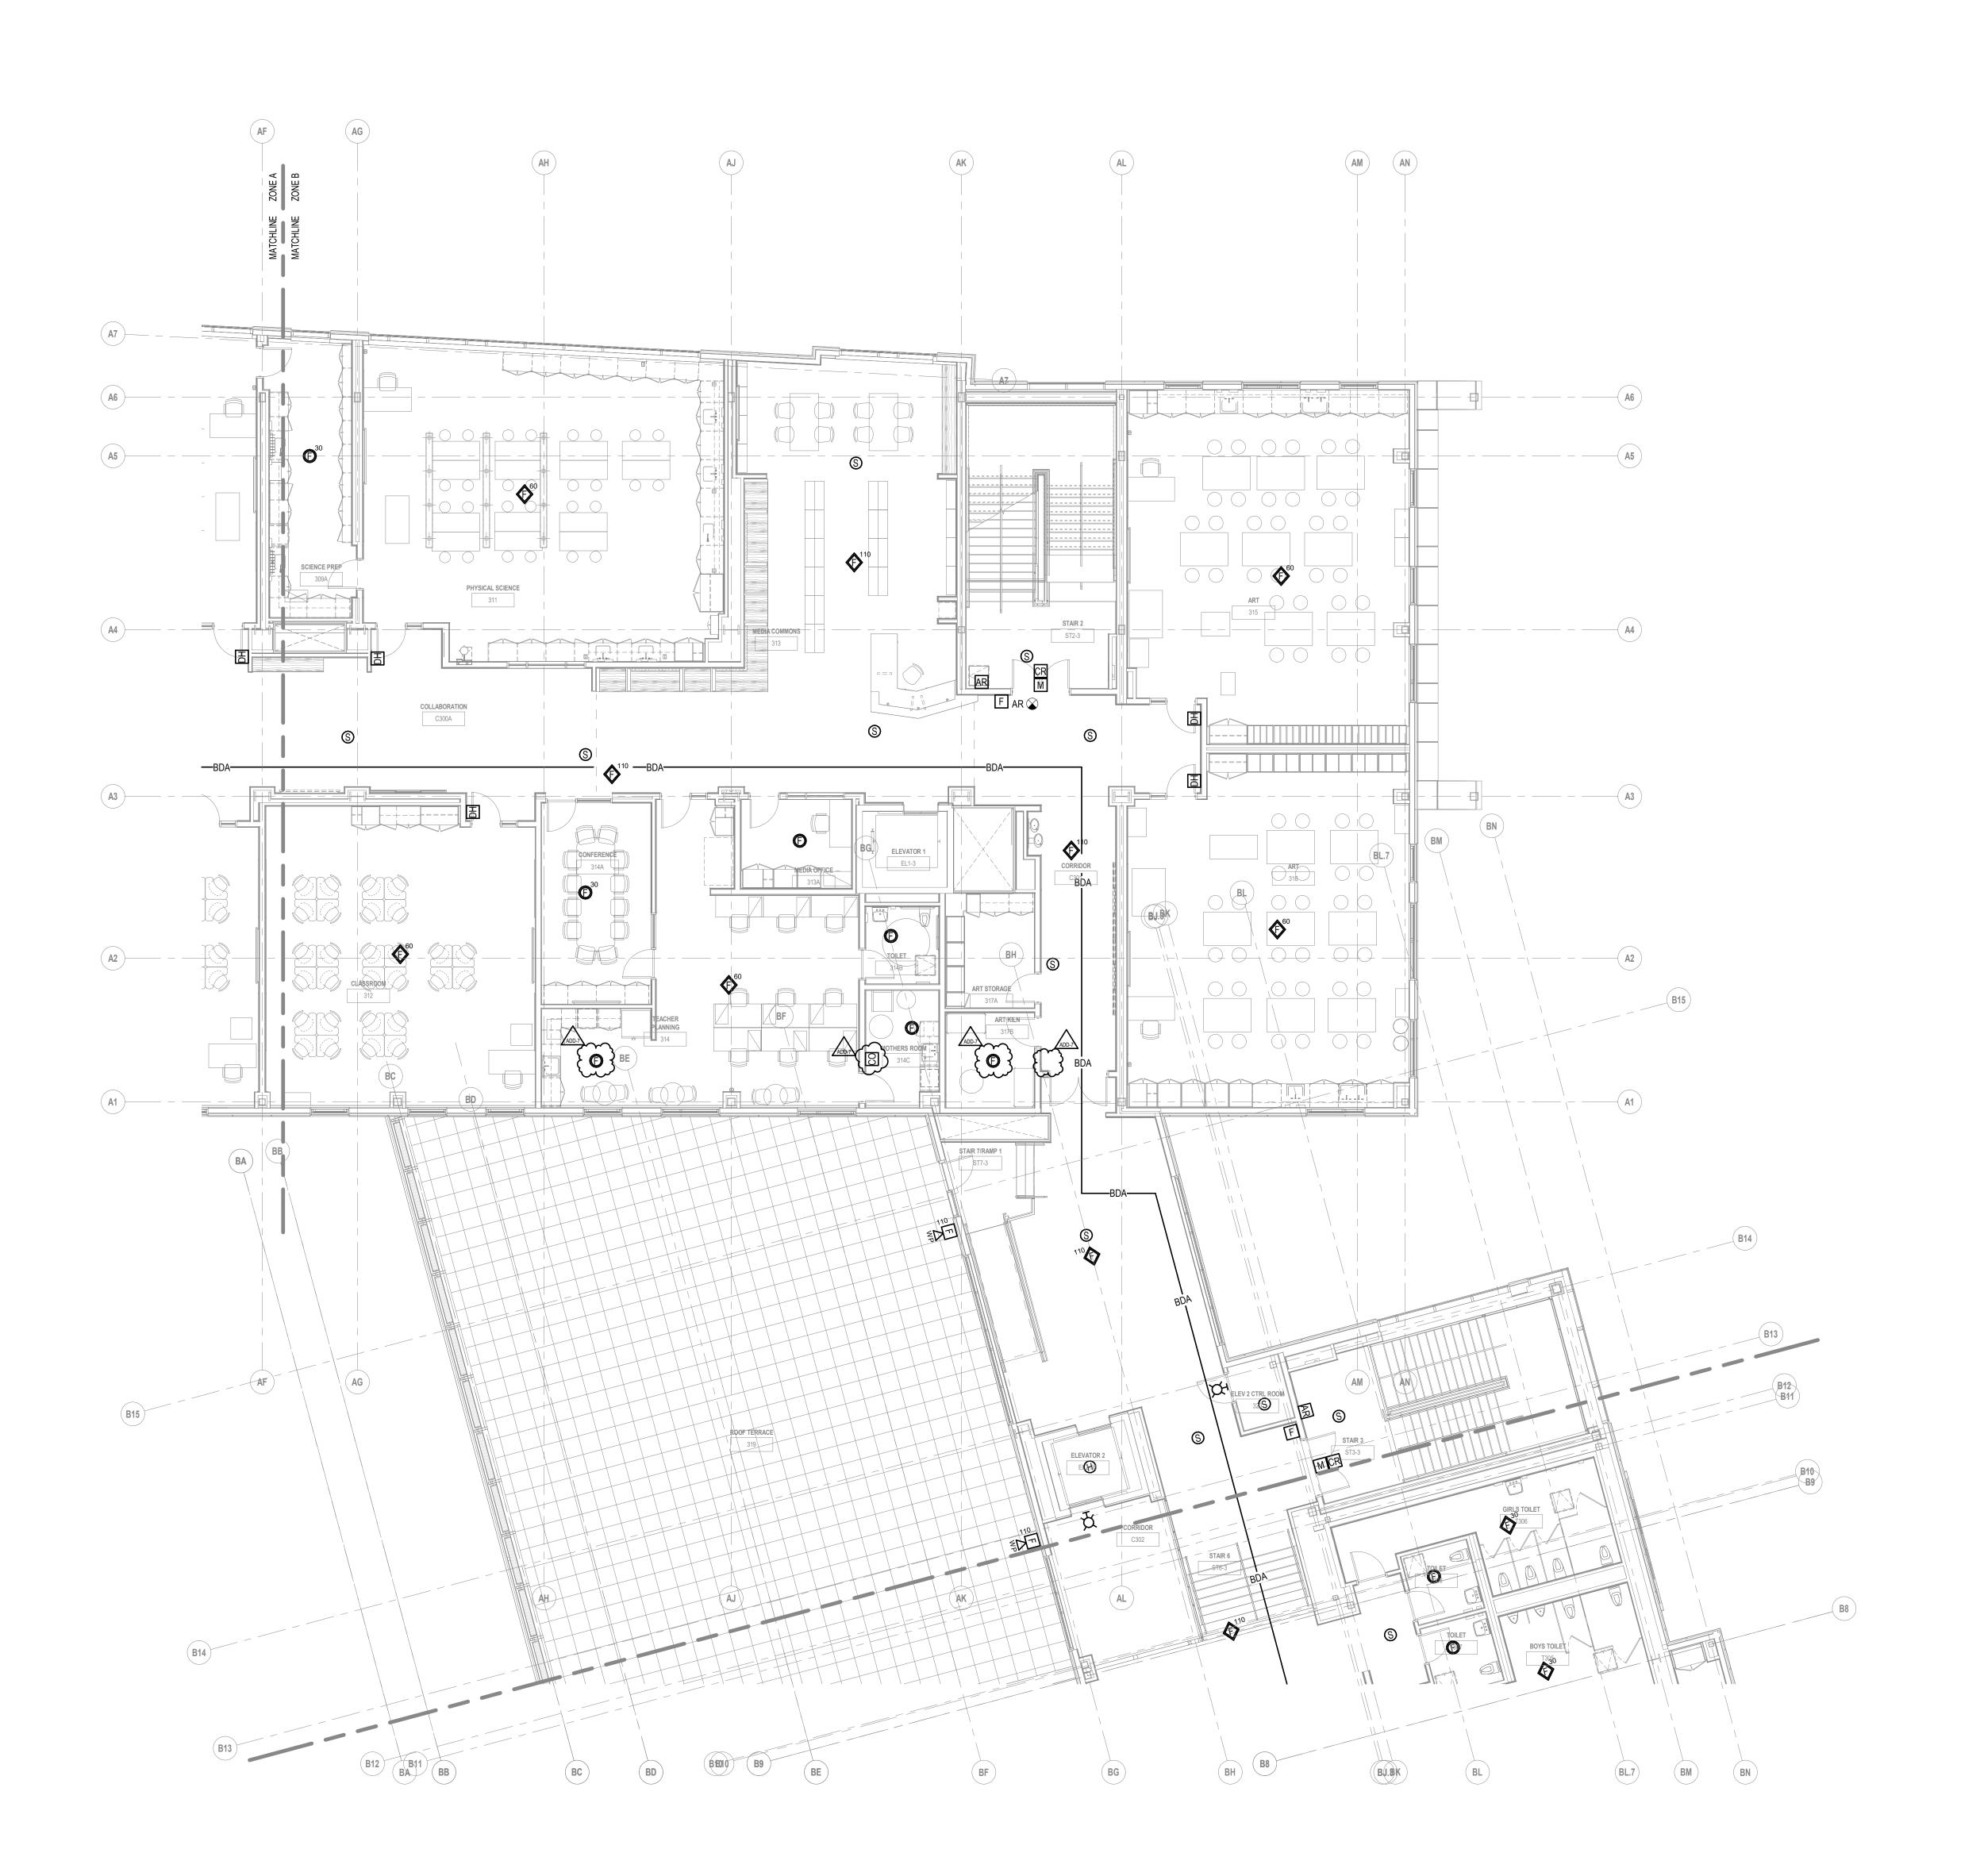


DRAWING NAME:

1 THIRD FLOOR FIRE ALARM PLAN - ZONE A

ELECTRICAL THIRD FLOOR FIRE ALARM PLAN -ZONE A

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1 THIRD FLOOR FIRE ALARM PLAN - ZONE B

1/8" = 1'-0"




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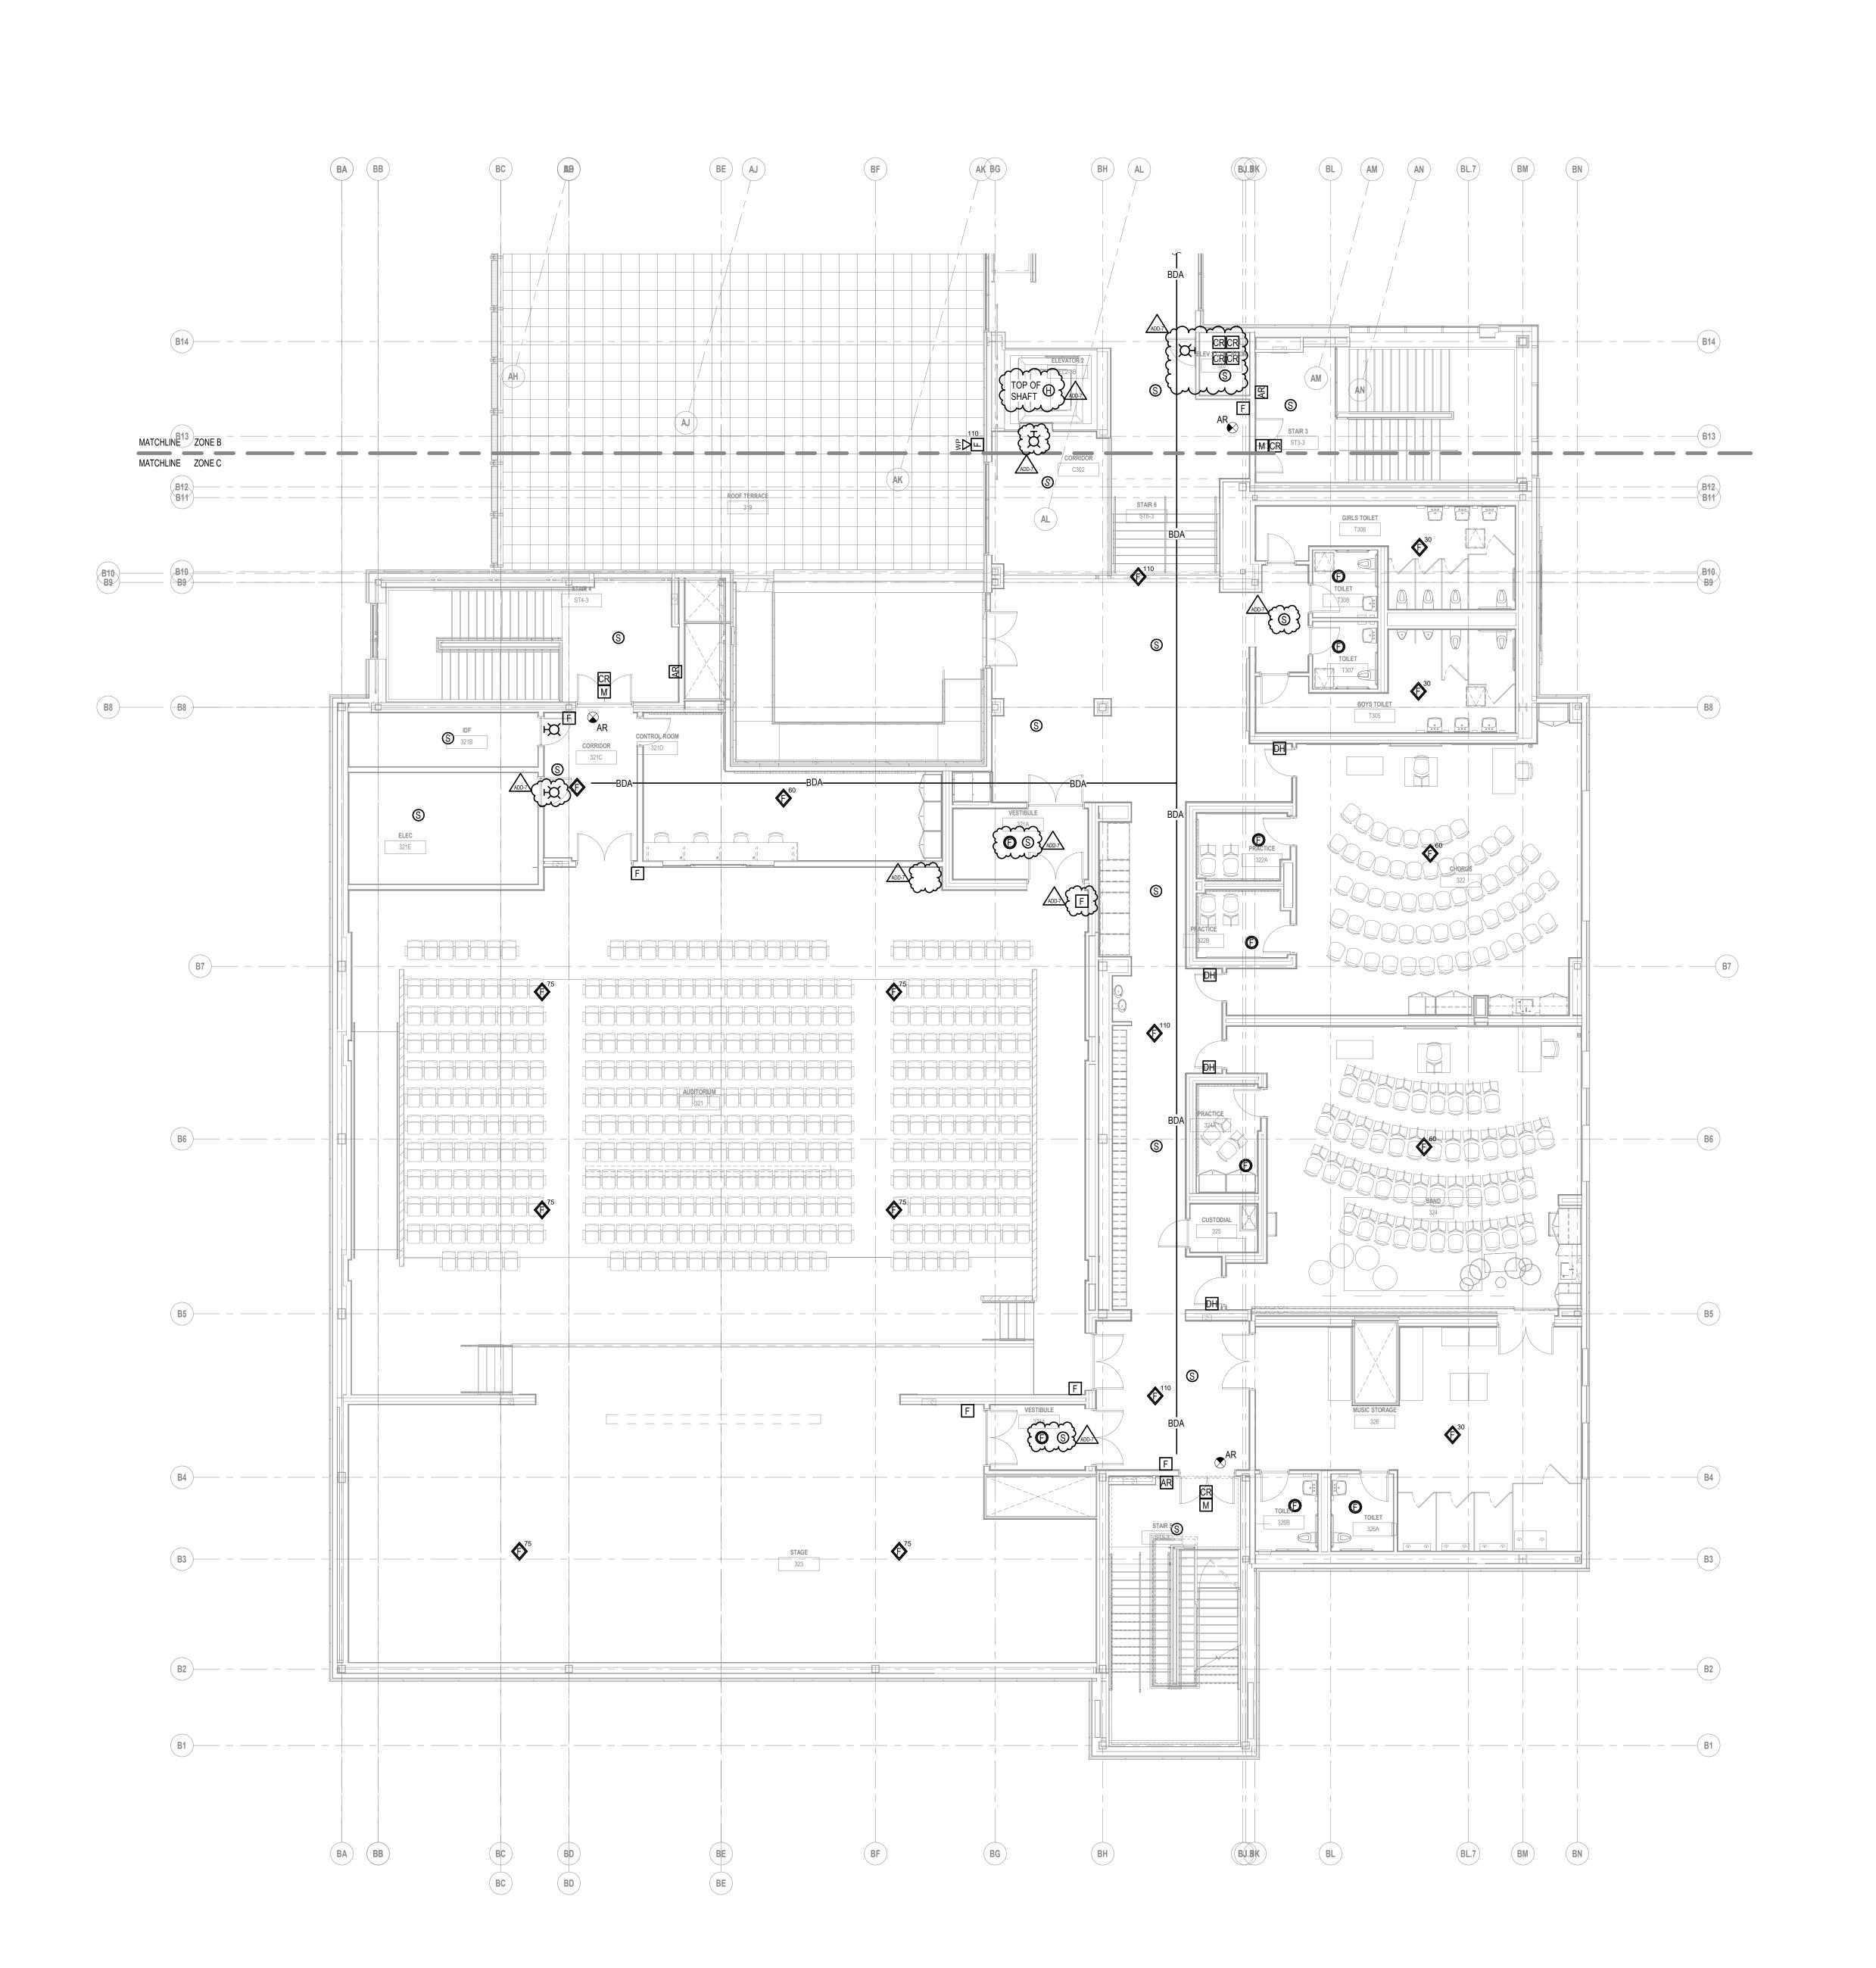
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KEY PLAN NORTH ARROW

A B C

ELECTRICAL
THIRD FLOOR FIRE
ALARM PLAN ZONE B

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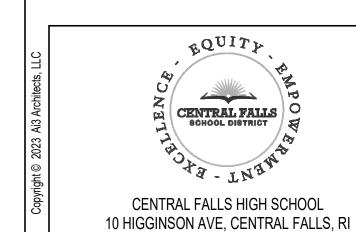


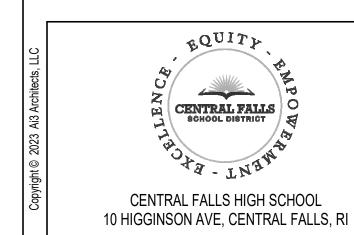

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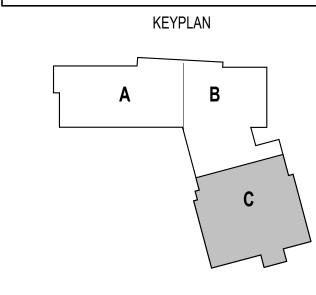
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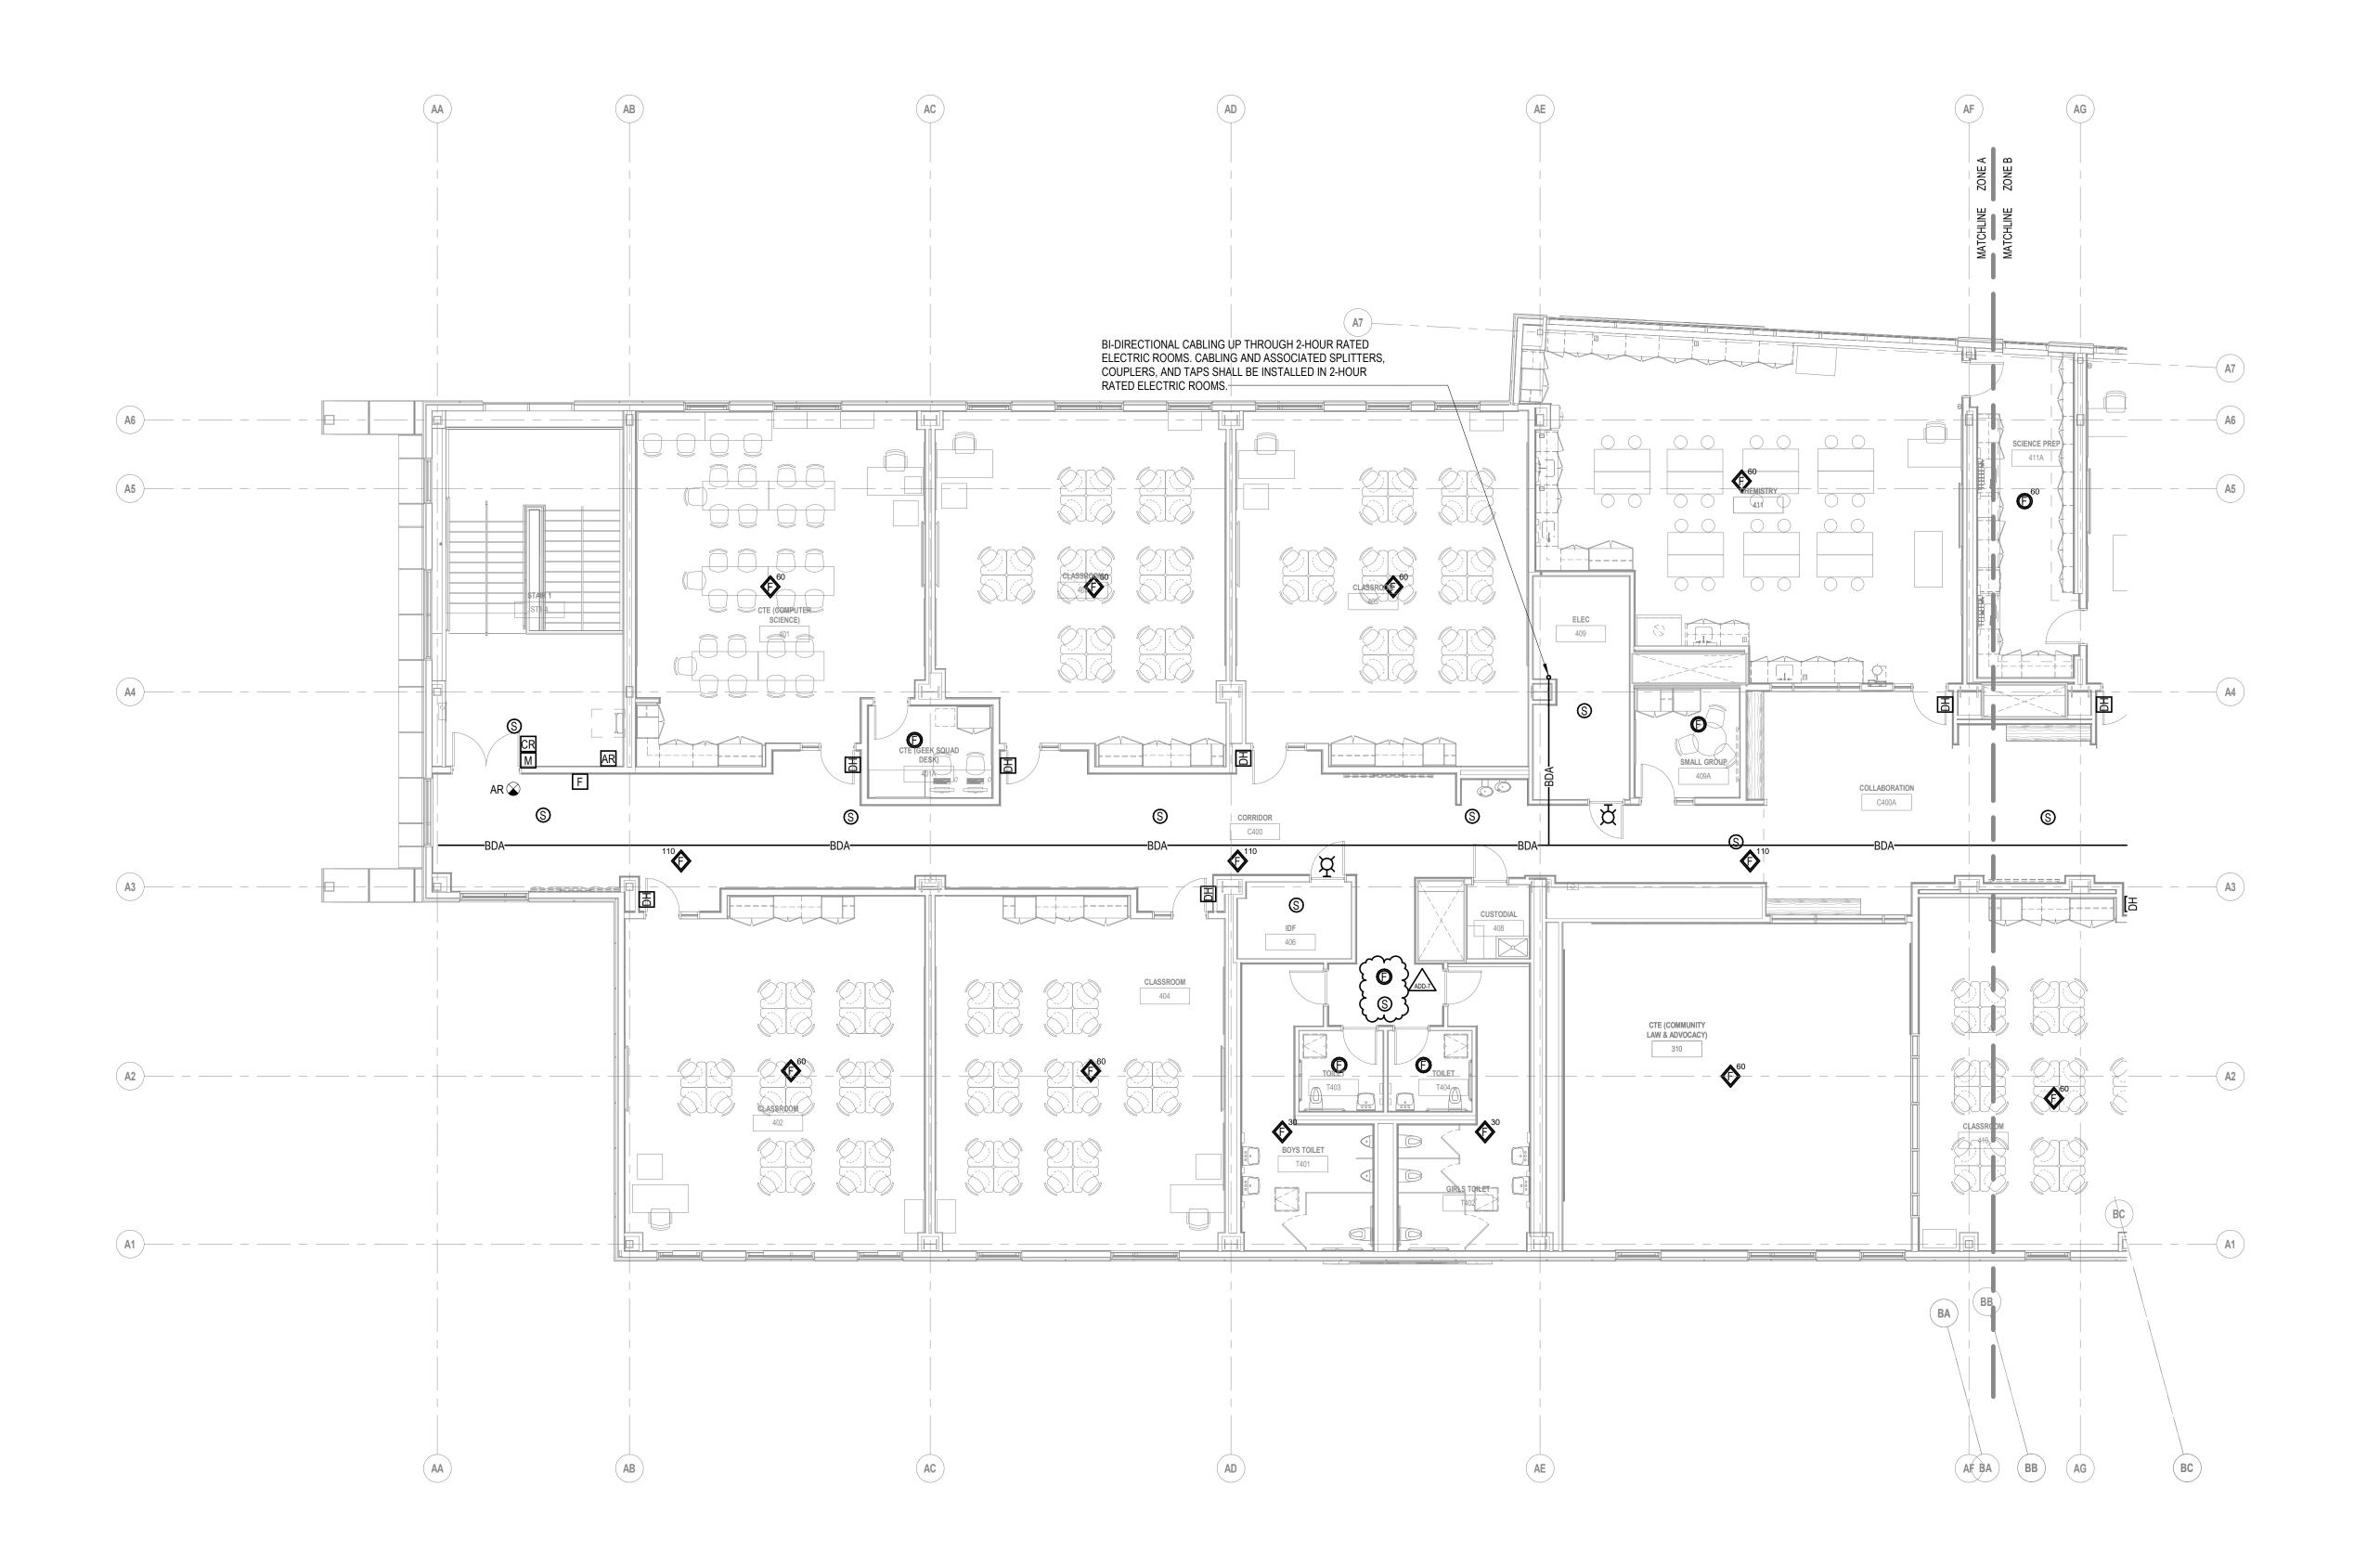
ADDENDUM 7 100% CONSTRUCTION DOCUMENTS KEY PLAN NORTH ARROW |



DRAWING NAME: ELECTRICAL THIRD FLOOR FIRE ALARM PLAN -ZONE C

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1 THIRD FLOOR FIRE ALARM PLAN - ZONE C
1/8" = 1'-0"




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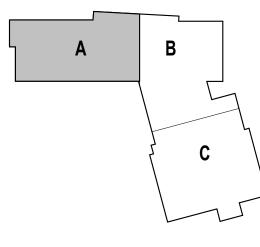


KEYNOTE LEGEND:

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100% CONSTRUCTION DOCUMENTS KEY PLAN NORTH ARROW |

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JOB NO.:	2202.02	EF3.14A
DATE: OC	TOBER 13, 2023	

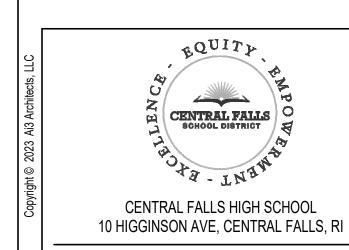1 FOURTH FLOOR FIRE ALARM PLAN - ZONE A



1 FOURTH FLOOR FIRE ALARM PLAN - ZONE B



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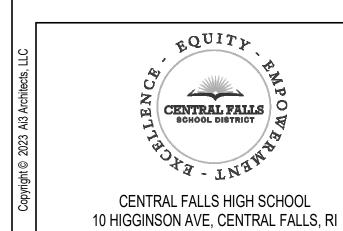
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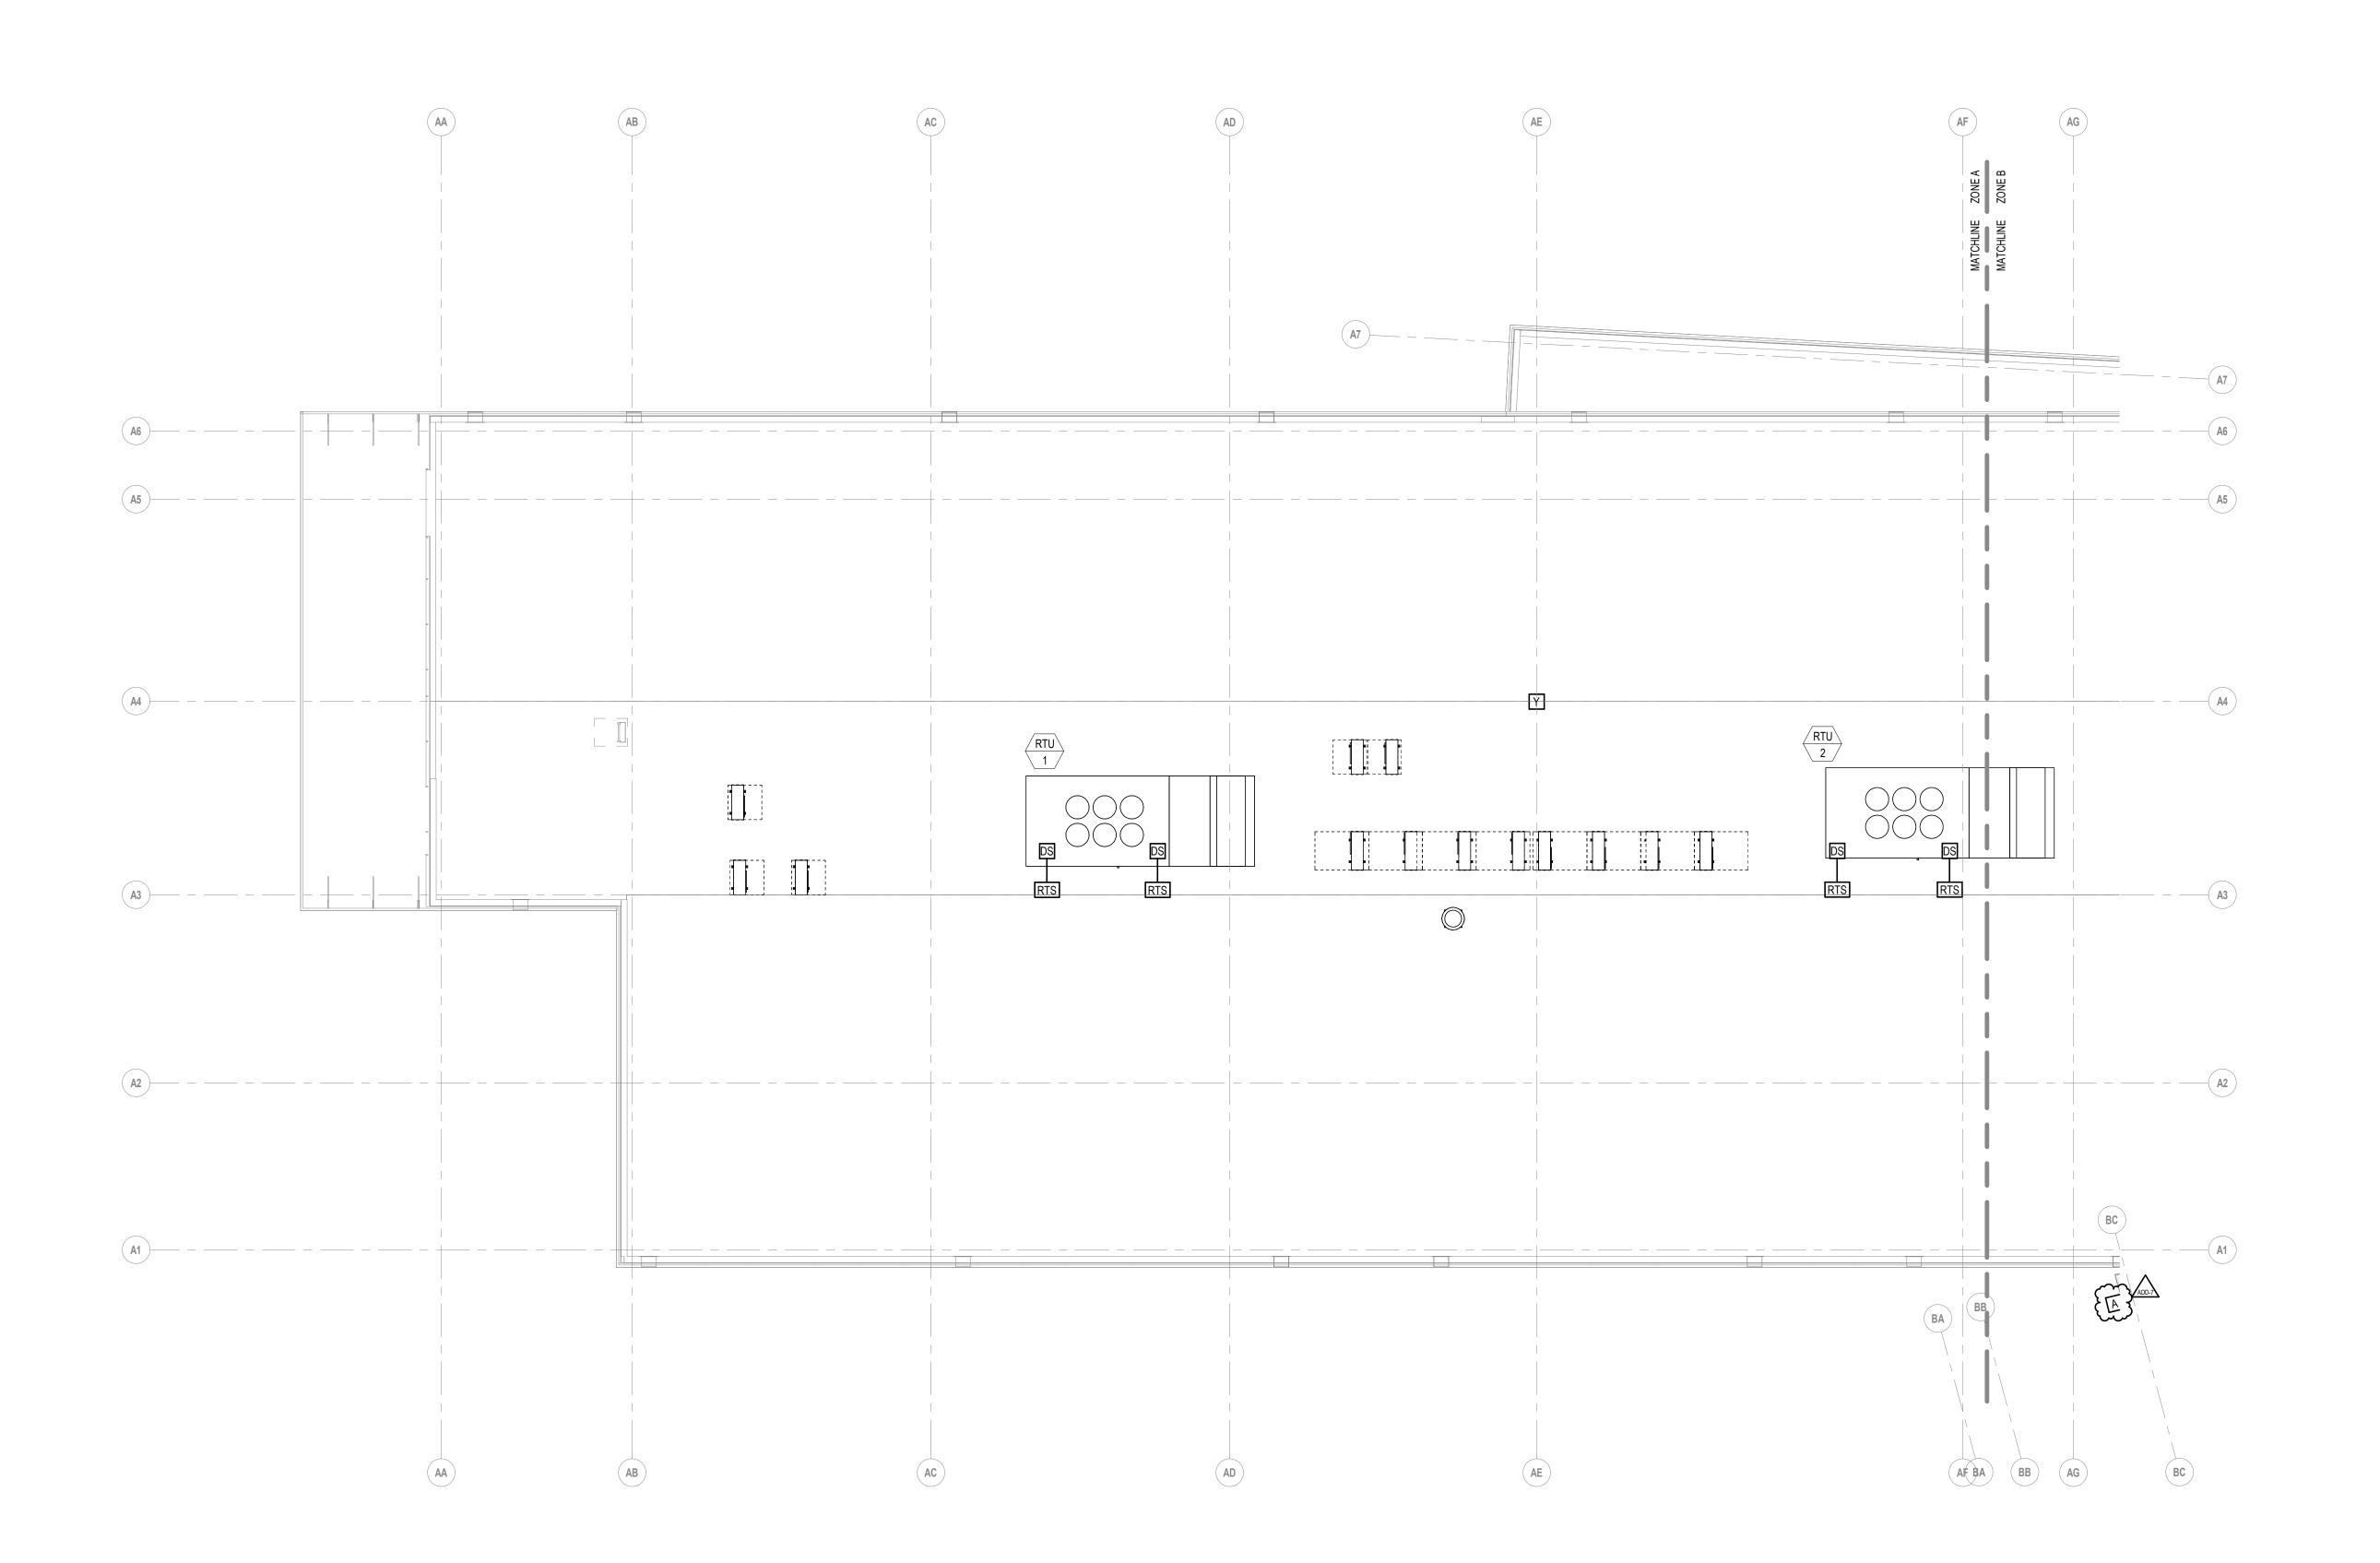
KEYNOTE LEGEND:

100% CONSTRUCTION DOCUMENTS KEY PLAN NORTH ARROW

KEYPLAN

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	REVIEW	ED BY:	RCB
	SCALE:	AS NOTED	DRAWING NUMBER:
	JOB NO.:	2202.02	EF3.14B
	DATE:	OCTOBER 13, 2023	



1 ROOF FIRE ALARM PLAN - ZONE A



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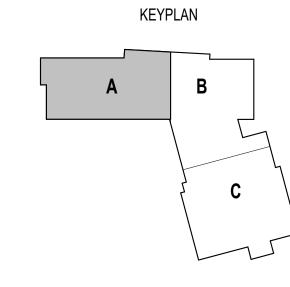
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KEYNOTE LEGEND:

100% CONSTRUCTION DOCUMENTS

KEY PLAN NORTH ARROW |



DRAWING NAME:

ELECTRICAL ROOF FIRE ALARM PLAN - ZONE A


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DATE: OCTOBER 13, 2023

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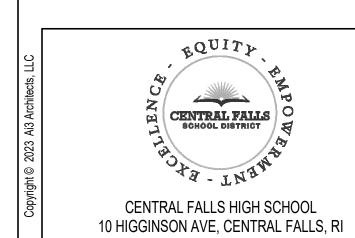




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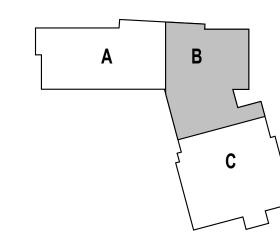
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100% CONSTRUCTION DOCUMENTS KEY PLAN NORTH ARROW |

KEYPLAN

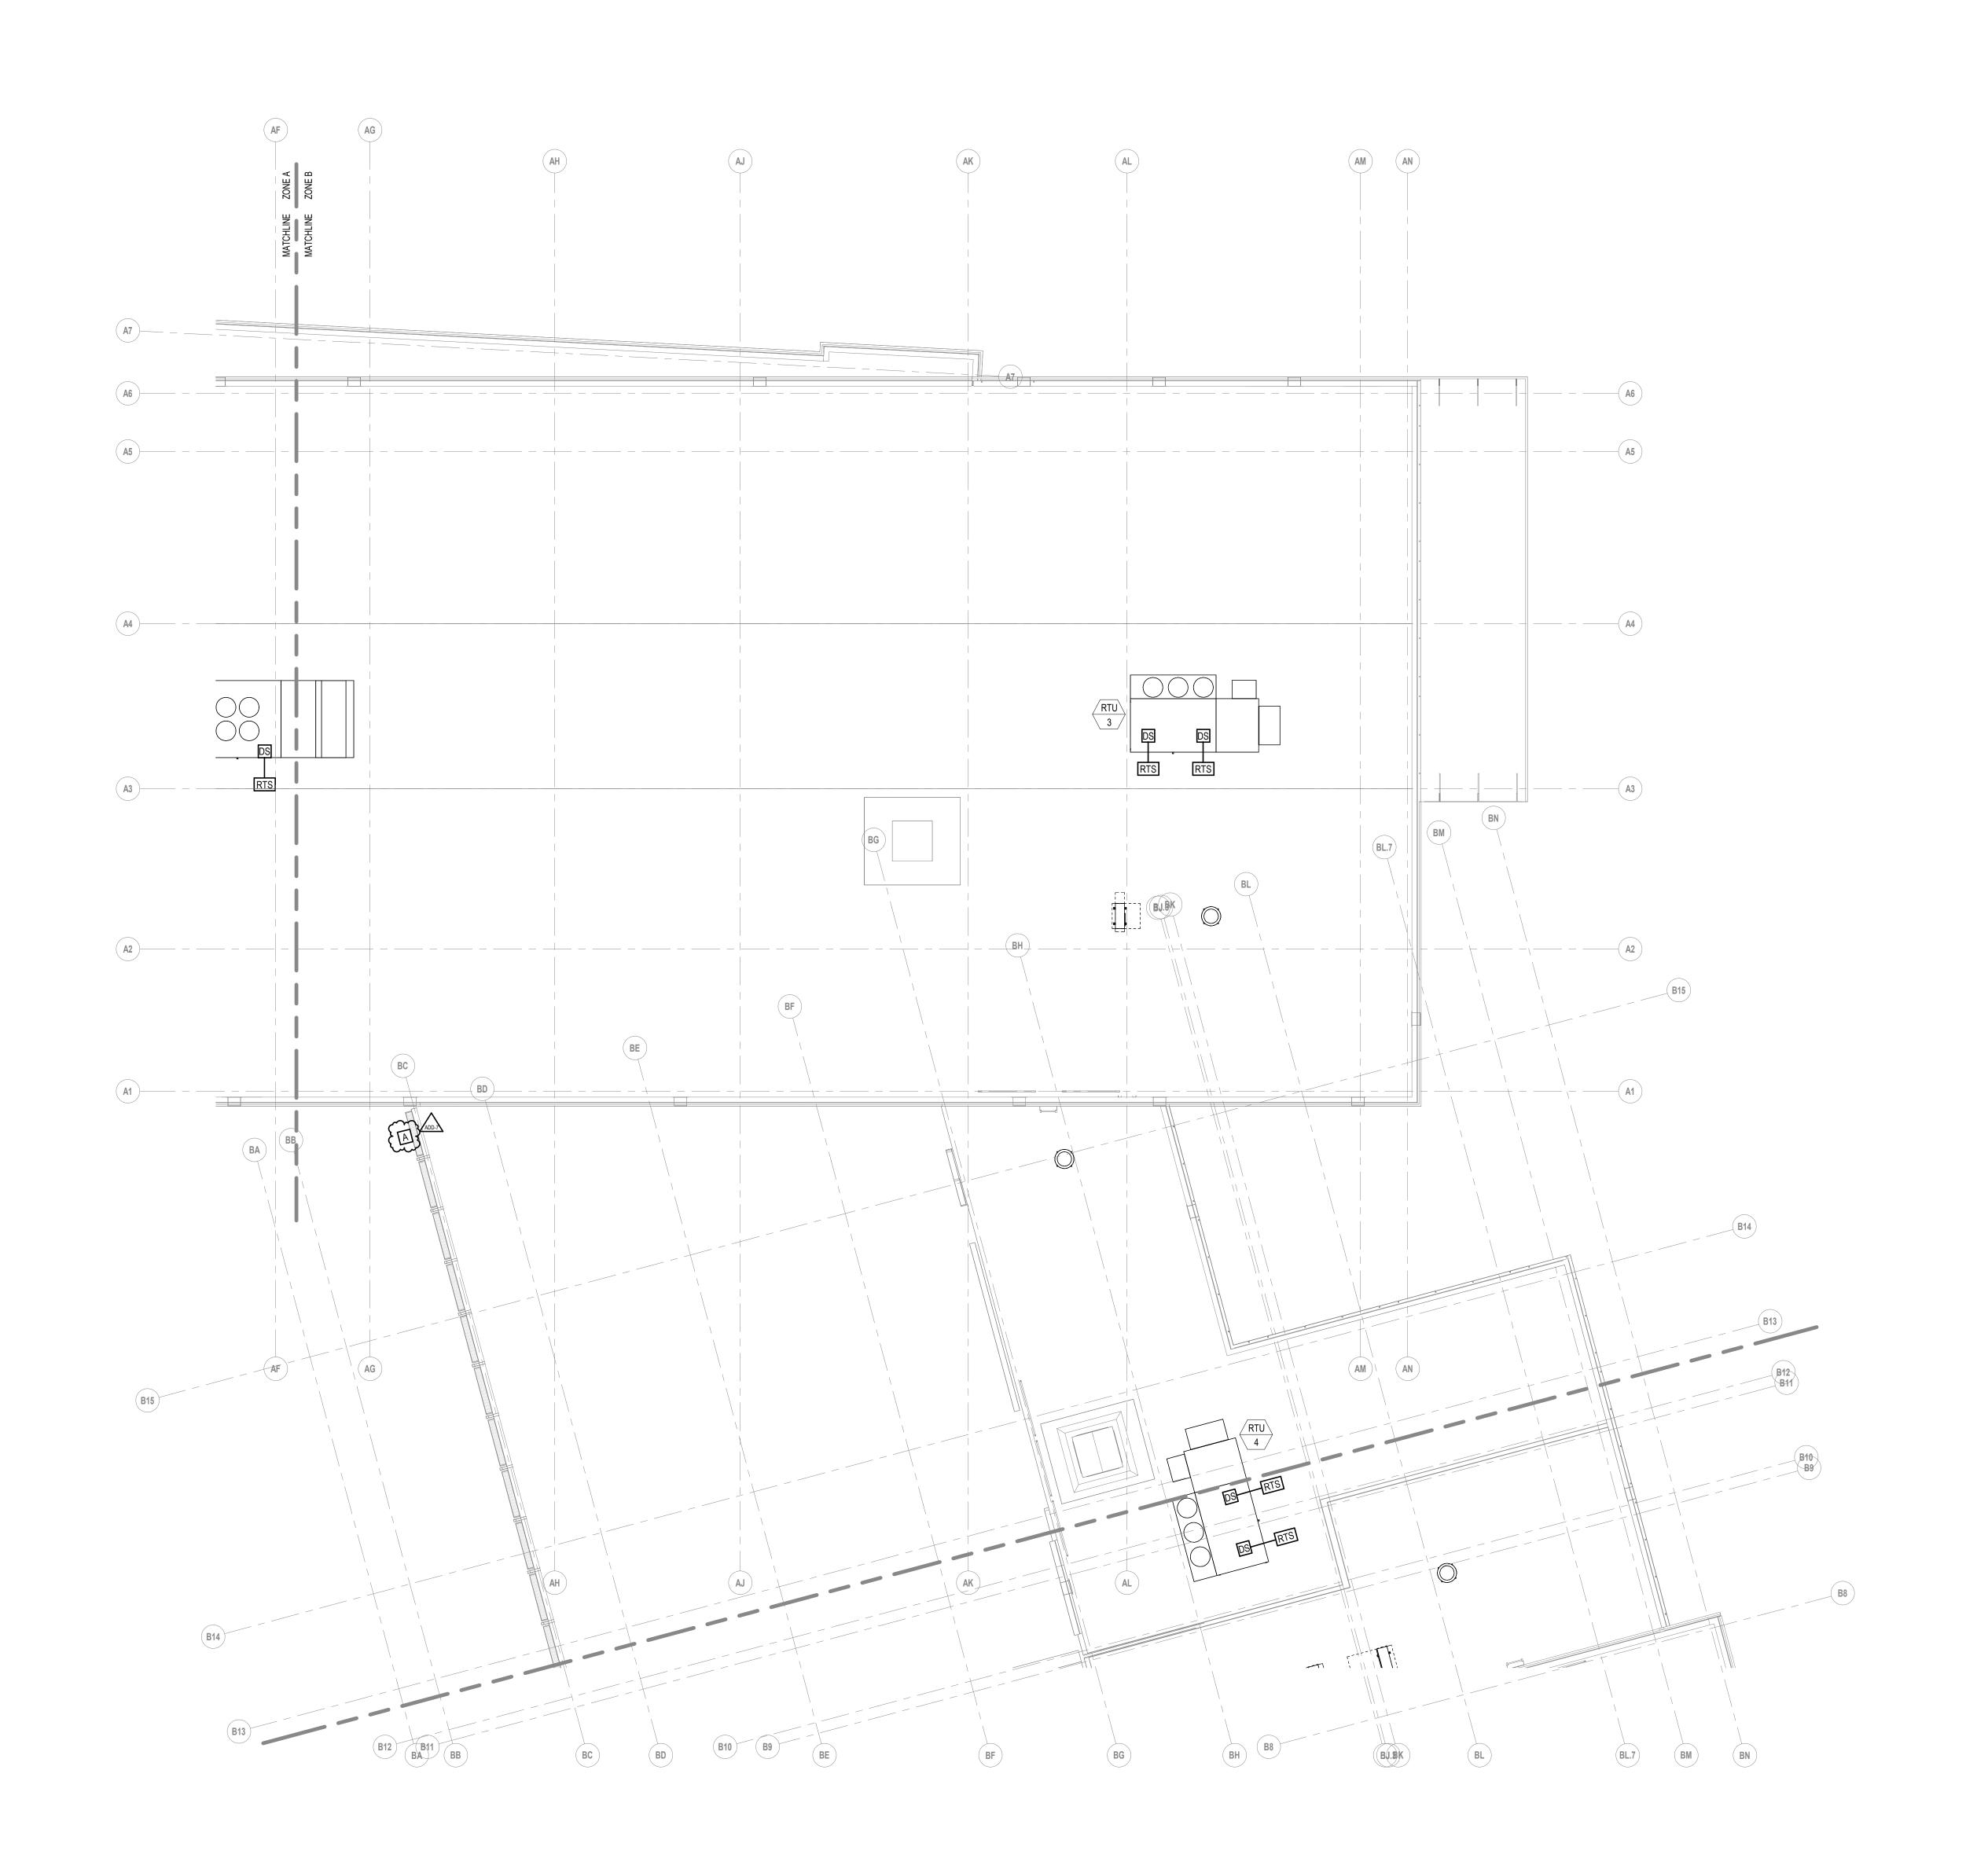

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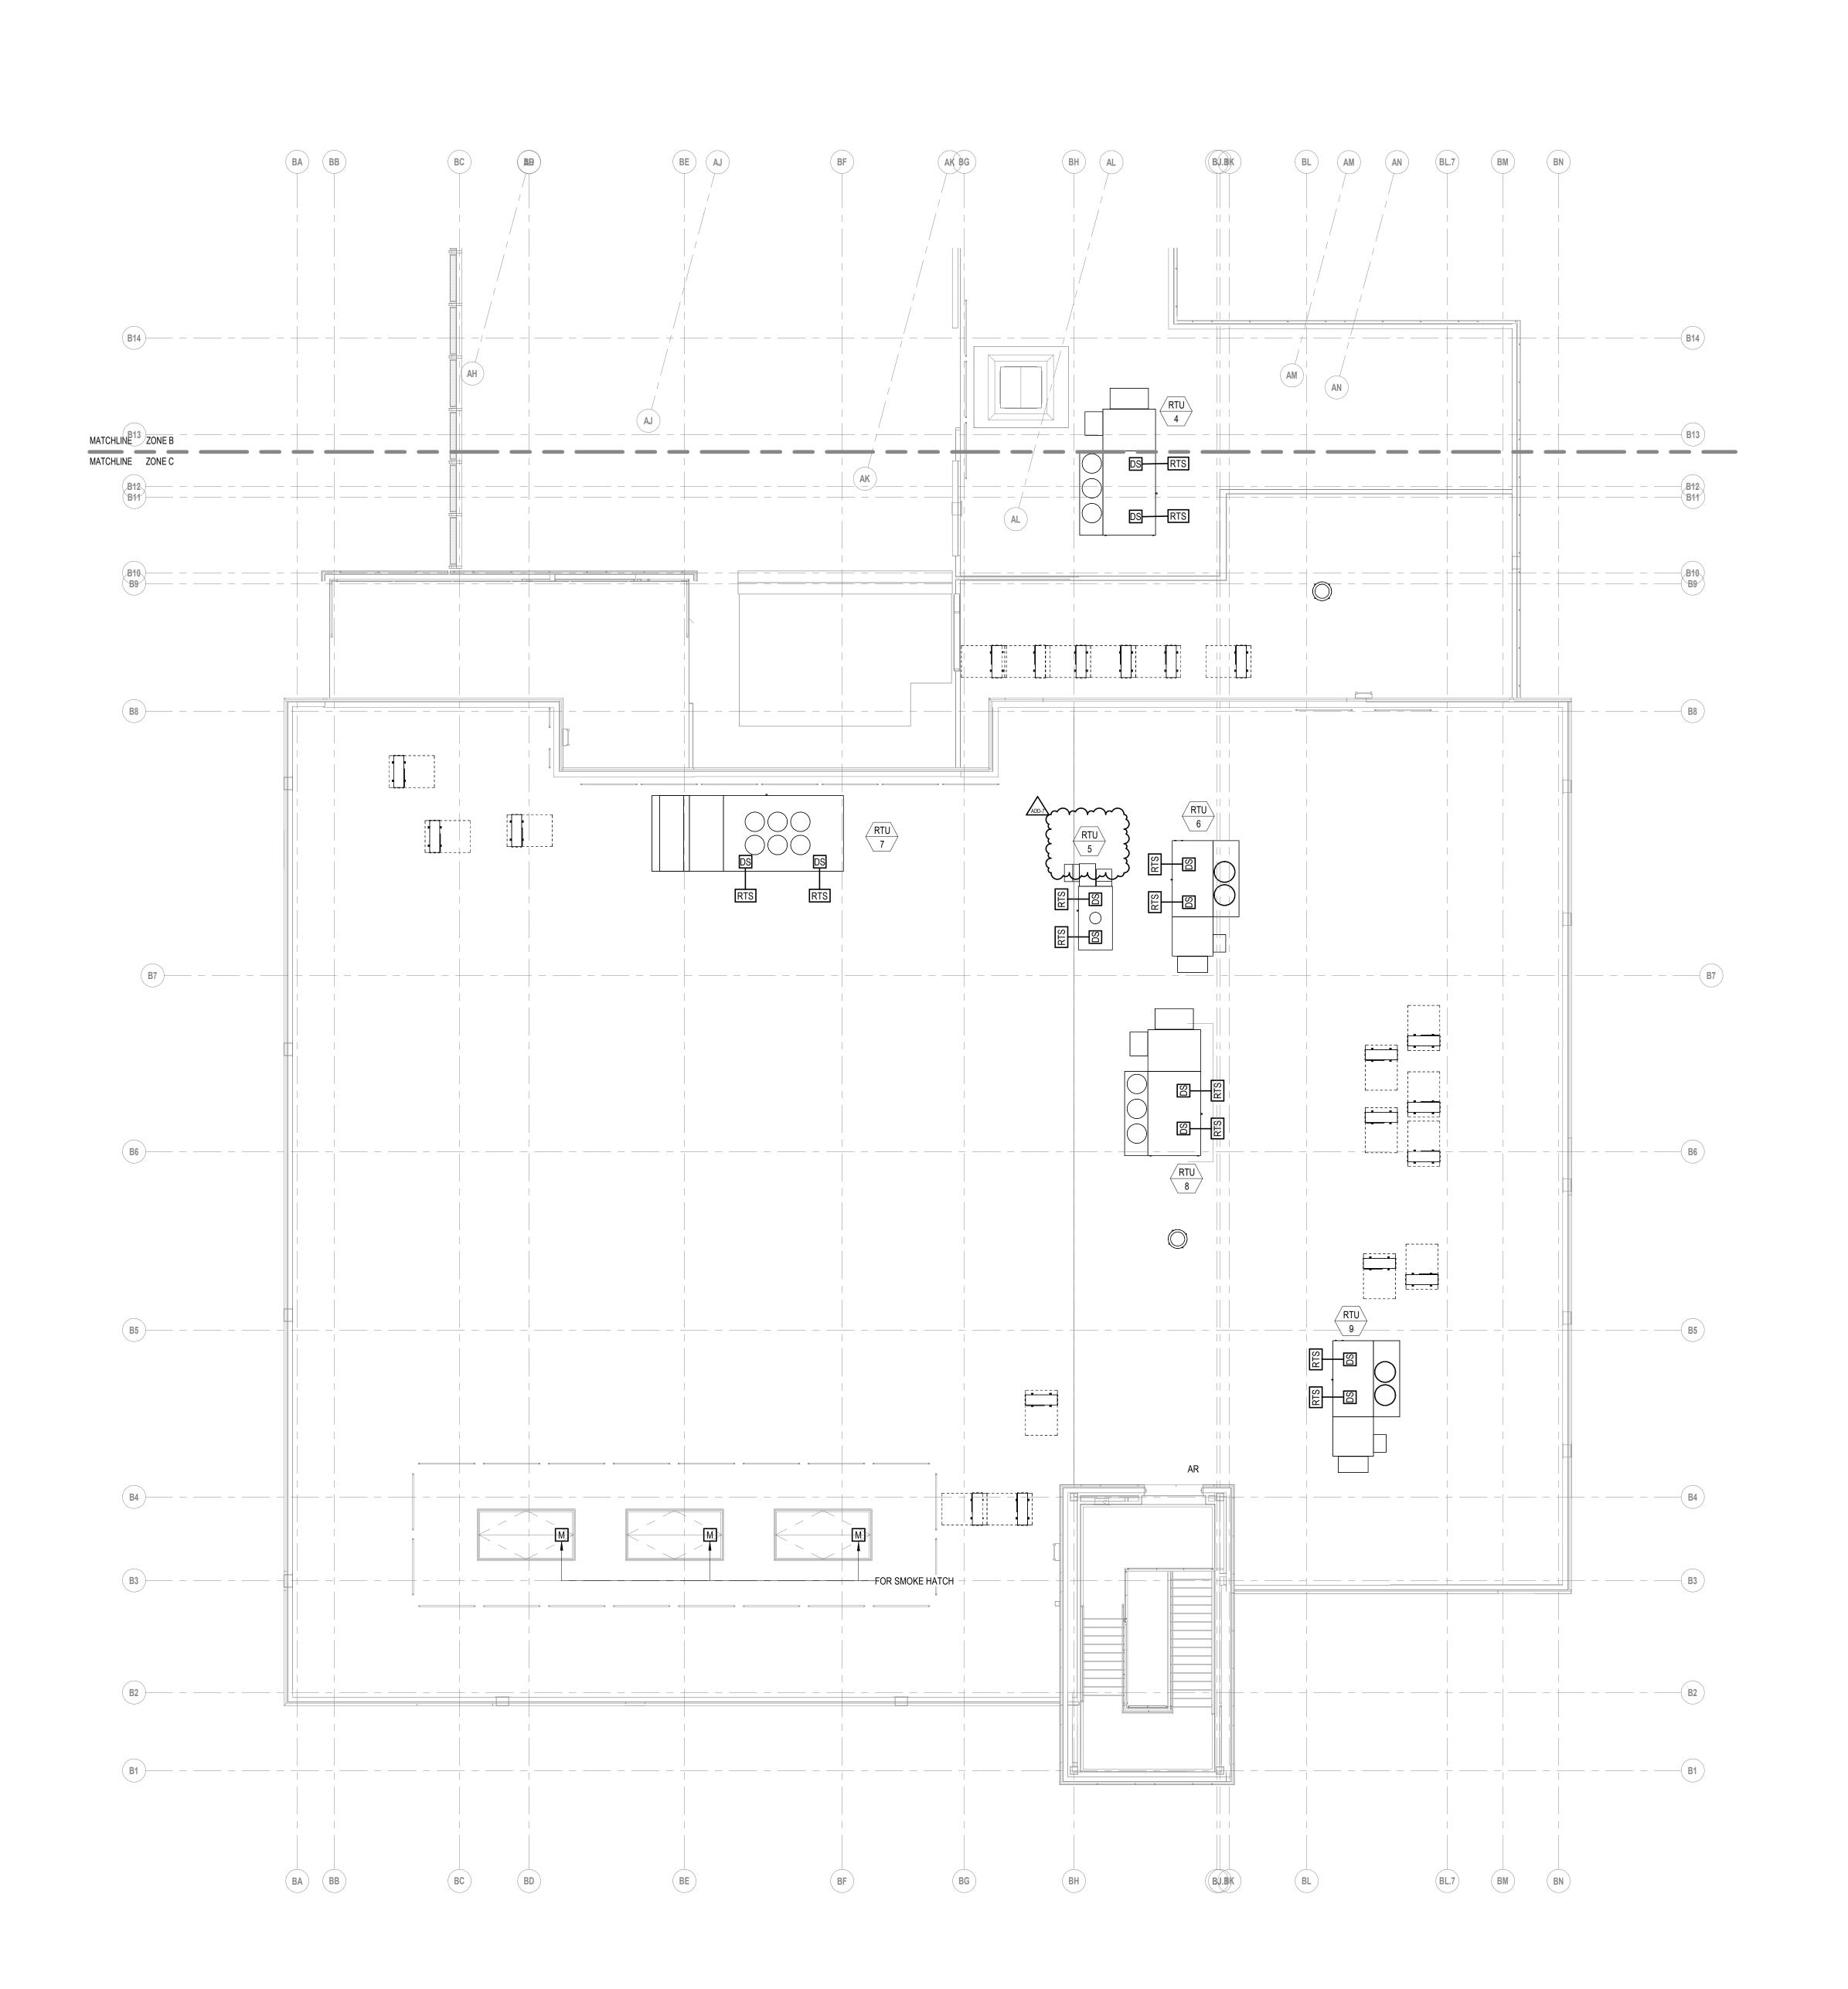
ELECTRICAL ROOF FIRE ALARM PLAN - ZONE B

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DATE: OCTOBER 13, 2023

EF3.15B






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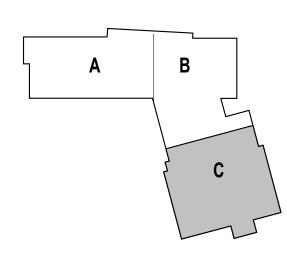
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KEYNOTE LEGEND:

100% CONSTRUCTION DOCUMENTS

KEY PLAN NORTH ARROW

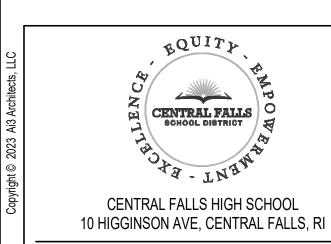

DRAWING NAME:

ELECTRICAL **ROOF FIRE ALARM** PLAN - ZONE C

DRAWN BY: REVIEWED BY: AS NOTED | DRAWING NUMBER: JOB NO.: 2202.02 EF3.15C

1 ROOF FIRE ALARM PLAN - ZONE C

OFFICE OF LAND REVITALIZATION & SUSTAINABLE MATERIALS MANAGEMENT 235 Promenade Street, Providence, Rhode Island 02908

REMEDIAL APPROVAL LETTER File No. SR-04-2061 File No. SR-04-2061 B January 23, 2024

Jim Vandermillen, Director City of Central Falls Department of Planning and Economic Development 580 Broad Street Central Falls, RI 02863

RE: Higginson Avenue School

10 Higginson Avenue, and 756 & 770 Lonsdale Avenue

Central Falls, Rhode Island

Portion of Plat Map 9 / Lot 50, and Plat Map 9 / Lots 26 & 203, respectively

Dear Mr. Vandermillen:

On April 22, 2020, the Rhode Island Department of Environmental Management's (the Department) Office of Land Revitalization and Sustainable Materials Management (LRSMM) enacted the codified 250-RICR-140-30-1, Rules and Regulations for the Investigation and Remediation of Hazardous Material Releases (the Remediation Regulations). The purpose of these regulations is to create an integrated program requiring reporting, investigation, and remediation of contaminated sites in order to eliminate and/or control threats to human health and the environment. A Remedial Approval Letter (RAL) is a document used by the Department to approve remedial actions at contaminated sites that do not involve the use of complex engineered systems or techniques (e.g. groundwater pump and treat systems, soil vapor extraction systems, etc.).

In the matter of the above-referenced property (the Site), the Department's Office of LRSMM is in receipt of the following documentation submitted pursuant to the <u>Remediation Regulations</u> in response to the reported release at the Sites:

SR-04-2061, 10 Higginson Avenue:

- 1. <u>Notification of Release (NOR) Package</u>, received by the Department on December 2, 2021, and prepared by SAGE Environmental, Inc. (SAGE);
- 2. <u>Pre-SIR Public Notice and Environmental Justice Package</u>, received by the Department on January 31, 2022, and prepared by SAGE;
- 3. Newspaper Tear Sheet, received by the Department on February 10, 2022, and prepared by SAGE;

- 4. <u>Pre-Site Investigation Public Hearing Transcript</u>, received by the Department on April 5, 2022, and prepared by SAGE;
- 5. <u>Site Investigation Report (SIR)</u>, received by the Department on December 8, 2022, and prepared by SAGE;
- 6. <u>SIR Response to Comment</u>, received by the Department on February 27, 2023, and prepared by SAGE;
- 7. <u>Public Notice Package</u>, received by the Department on March 20, 2023, and prepared by SAGE:
- 8. <u>Higginson Avenue School Construction Investigation Public Comment</u>, received by the Department on March 30, 2023, and prepared by David A. Brown;
- 9. Response to Public Comment, received by the Department on May 8, 2023, and prepared by SAGE; and
- 10. <u>Combined Remedial Action Work Plan</u> (Combined RAWP), received by the Department on January 3, 2024, and prepared by SAGE.

SR-04-2061 B, 756 & 770 Lonsdale Avenue:

- 1. <u>Release Notification Package</u>, received by the Department on January 11, 2023, and prepared by SAGE Environmental, Inc. (SAGE);
- 2. <u>Pre-SIR Public Notice Package</u>, received by the Department on January 26, 2023, and prepared by SAGE;
- 3. <u>Pre-SIR Public Meeting Summary</u>, received by the Department on April 11, 2023, and prepared by SAGE;
- 4. <u>Site Investigation Report</u> (SIR), received by the Department on May 11, 2023, and prepared by SAGE;
- 5. <u>Post-SIR Public Notice Package</u>, received by the Department on July 28, 2023, and prepared by SAGE; and
- 6. <u>Combined Remedial Action Work Plan</u> (Combined RAWP), received by the Department on January 3, 2024, and prepared by SAGE.

Together these documents fulfill the requirements of Section 1.9 (Risk Management) and Section 1.10 (Remedial Action Work Plan (RAWP)) of the <u>Remediation Regulations</u>.

The preferred remedial alternative involves:

- Encapsulation of Site soils by the existing pavement and building foundation. All cracked and damaged areas of the existing pavement shall be repaired and sealed as part of the remediation. Areas of the Site not currently encapsulated by existing hardscape must be encapsulated by a Department-approved engineering control consisting of two (2) feet or clean fill or equivalent i.e. building foundations, one (1) foot of clean fill over a geotextile fabric, and/or four (4) inches of asphalt or concrete over six (6) inches of clean fill.
- Prior to SSDS activation, post construction sub-slab soil gas sampling is to be conducted to determine if indoor air sampling will be required. The threshold for indoor air sampling will be the MassDEP Residential Sub-Slab Soil Gas Screening Values (R-SSGSVs) for the following Contaminants of Concern (COCs): Toluene, trans-1,2-DCE, cis-1,2-DCE, PCE, and TPH via Method TO-15. Additionally, due to the detection of petroleum, sub-slab soil gas samples are to be analyzed for APH by the MassDEP method. If any COC exceeds the associated R-SSGSVs, quarterly indoor air sampling is to be conducted and compared to MassDEP Residential Indoor Air Threshold Values (R-TVs) for a minimum of one (1) year.
- Upon completion of sub-slab soil gas testing, a pilot test is to be conducted to ensure adequate fan size and radius of influence for system activation. Installation of a vapor barrier and the design & installation of an active sub-slab depressurization system (SSDS) based on the results of the pilot testing.
- An Environmental Land Usage Restriction (ELUR) shall be recorded on the deeds for the entire property for Plat Map 9, Lots 26 & 230, and for a portion of the property for Plat Map 9, Lot 50). As part of the ELUR, a Class I Survey will be required to define the portion of Lot 50 subject to the ELUR. The ELUR shall require the performance of annual inspections to document the status of the ELUR and the condition of the engineered controls. The ELUR shall also include a Department-approved Post-Remediation Soil Management Plan (SMP) which will address any future activities that may disturb on-Site soils. The ELUR shall be recorded for the entire property in the Land Evidence Records for the City of Central Falls, and a recorded copy forwarded back to the Department's Office of Land Revitalization & Sustainable Materials Management within fifteen (15) days of recording.

Based upon review and consideration of the above referenced documents, the Department approves the Combined RAWP through this RAL provided that:

- 1. All work must be performed in accordance with all applicable regulations and the Department approved Combined RAWP.
- 2. Start of the work described in the Department approved Combined RAWP must be initiated within sixty (60) days of issuance of this RAL.
- 3. Prior to initiating any remedial activities, the Department shall be provided with a list of all contractors, and their respective contact information, that will be used on Site to complete the remedial work described in the Department approved Combined RAWP. The Department shall

be notified, when feasible, a minimum of five (5) working days in advance of any changes in contractors and/or consultants involved with the remedial work on this Site. The notification must be promptly supplied in writing with complete contact information for each new contractor or consultant (including but not limited to company name and address, contact name and address, contact telephone number and e-mail address).

- 4. All excavated regulated soil, if not approved for encapsulation onsite, shall be disposed of off-site at an appropriately licensed disposal facility in accordance with all local, State, and Federal laws. Copies of the material shipping records and manifests associated with the disposal of the material shall be included along with the Closure Report.
- 5. Areas of the site where contaminated soils are to be excavated must be staged and temporarily stored in a designated area, as proposed in the Combined RAWP, of the site with proper polyethylene covers. Any stockpiled materials, including clean fill, must be underlain and covered with polyethylene sheeting and be secured at the end of each day with all appropriate erosion and sediment controls to limit the loss of the cover and protect against stormwater and wind erosion (i.e., hay bales, rocks, silt fencing). These appropriate sedimentation and erosion controls must be in place and in proper working order at all times until all disturbed areas are stabilized and capped as proposed. Within reason, the storage location will be selected to limit the unauthorized access to the materials (i.e., away from public roadways/walkways). No regulated soil will be stockpiled on-site for greater than thirty (30) days. In the event that stockpiled soils pose a risk or threat of leaching hazardous materials, a proper leak-proof container (i.e., drum or lined roll-off) or secondary containment will be required and utilized.
- 6. The Office of LRSMM no longer requires the submittal of analytical data prior to clean fill being brought to a Site. It is the sole responsibility of the Performing Party and their consultant to analyze the material, certify that the material meets the Department's Residential Direct Exposure Criteria (RDEC), as defined by the <u>Remediation Regulations</u>, for all constituents, and is suitable for use on the Site. The Office of LRSMM strongly suggests that enough representative samples of the clean fill are collected prior to moving the material to the Site to satisfy the Performing Party and their consultant that the material meets the RDEC. Please note that the Office of LRSMM reserves its rights to sample the fill, if suspect, to confirm compliance with the RDEC.
- 7. All regulated soil remaining onsite shall be encapsulated by an engineered control consistent with those described in the Department approved Combined RAWP.
- 8. Dust suppression techniques (i.e., watering) must be employed at all times during all soil disturbing/handling activities at the site in order to minimize the generation of fugitive dust.
- 9. Within sixty (60) days of completion of the work described in the Department approved Combined RAWP, a Closure Report detailing the remedial action and including any disposal documentation shall be submitted to the Office of LRSMM.
- 10. Within sixty (60) days of completion of the work described in the Department approved Combined RAWP, the final Department approved ELUR shall be recorded in the City of Central Falls Land Evidence Records for the property and a stamped, certified copy returned to the

Department within fifteen (15) days of recording. Upon receipt of a copy of the recorded (stamped) ELUR, the Office of LRSMM will issue a Letter of Compliance.

- 11. Following recording of the ELUR, the site shall be maintained and annually inspected to evaluate the compliance status of the site with the ELUR. Within thirty (30) days of each annual inspection, an evaluation report shall be prepared and submitted to the Office of LRSMM detailing the findings of the inspection and noting any compliance violations at the site.
- 12. As part of the operation and maintenance of the remedy, the sub-slab pressure shall be measured and the SSDS annually inspected to ensure that the SSDS is operating properly. As part of the annual ELUR inspection of the remedy, the efficacy of the SSDS shall be documented. Within thirty (30) days of each annual inspection, an evaluation report shall be prepared and submitted to the Office of LRSMM detailing the findings of the inspection and noting any compliance violations at the site.
- 13. Any changes in the activities detailed in the Combined RAWP shall be reported to the Office of LRSMM by telephone within one (1) working day and in writing within five (5) business days.
- 14. The Office of LRSMM shall be notified forty-eight (48) hours prior to initiating the remedial activities at the site associated with the Department approved Combined RAWP.
- 15. The Office of LRSMM shall be immediately notified of any site or operation condition that results in non-compliance with this RAL.

At this time, the Office of LRSMM offers its concurrence with the proposed remedial action for the property. The Department approves the Combined RAWP provided that all activities and procedures detailed in the Combined RAWP are strictly adhered to. Furthermore, this letter continues to place primary responsibility for the construction, operation, maintenance, and monitoring of the approved Combined RAWP and its associated implementation on the City of Central Falls. As the Responsible Party and Performing Party, the City of Central Falls is expected to implement the Combined RAWP in an expeditious and professional manner that prevents non-compliance with this RAL and said Combined RAWP and is protective of human health and the environment.

Please note that at this time the Department does not approve the ELUR for recording in the Land Evidence Records with the City of Central Falls. Please forward an electronic version of the draft ELUR and the post-construction SMP in red line / strikeout format for Department review and approval. The draft ELUR and SMP shall be reviewed and approved by the Department, followed by recording of the approved ELUR, at the completion of all remedial work.

This RAL does not remove your obligation to obtain any other necessary permits from other local, State, or Federal agencies.

If you have any questions regarding this letter or would like the opportunity to meet with Department personnel, please contact me by telephone at (401) 537-4359, or by E-mail at Joanna.Pawlina@dem.ri.gov.

Sincerely,

Joanna Pawlina

Joanna Pawlina
Environmental Scientist I
Office of Land Revitalization &
Sustainable Materials Management

Authorized by,

Ashley L. Blauvelt. P.E. Environmental Engineer IV

Office of Land Revitalization &

Sustainable Materials Management

Cc: Kelly Owens, RIDEM/LRSMM

Nicholas Pisani, RIDEM/OWR

Amy Mulhern, SAGE Environmental Inc. Lacy Reyna, SAGE Environmental Inc.

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