

CALCUTT MIDDLE SCHOOL

ARCHITECT

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SPECIFICATIONS

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375 Main Street Boxford, MA 01921 Tel: (781) 598-6789

CODE CONSULTANT

COSENTINI ASSOCIATES, INC.

101 Federal Street, 6th Floor Boston, MA 02110 Tel: (617) 748-7800

STRUCTURAL ENGINEER

PARE CORPORATION

10 Lincoln Rd, Suite 210 Foxboro, MA 02035 Tel: (508) 543-1755 Fax: (508) 543-1881

OWNERS PROJECT MANAGER

PEREGRINE GROUP, LLC

20 Newman Avenue, Suite Rumford, RI 02916 Tel: (401) 270-0600

MECH. / ELEC. / PLUMB. ENGINEERS

GRIFFITH & VARY, INC.

12 Kendrick Road Wareham, MA 02571 Tel: (508) 295-0050

COST ESTIMATOR

PROJECT MANAGEMENT & COST

20 Downer Ave., Suite 1C Hingham, MA 02043 Tel: (781) 740-8007 Fax: (781) 740-1012

ACCESSIBILITY CONSULTANT

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1 Bridge St., Suite A102 Newton, MA 02458 Tel: (617) 641-2802

DOOR HARDWARE CONSULTANT

SPEC CONSULTANTS, LLC

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DEMOLITION

DA1.00 DEMOLITION GENERAL NOTES AND LEGEND
DA2.11 B2 FIRST FLOOR DEMOLITION PLAN

DA2.21 B2 STUDENT DINING ENLARGED DEMOLITION RCP

ARCHITECTURAL A0.0A MASTER KEYNOTE LIST

A0.0A MASTER KEYNOTE LIST

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A2.11 B2 FIRST FLOOR RCP
A2.21 B2 STUDENT DINING ENLARGED RCP

A6.10 B2 DOOR SCHEDULE
A10.10 B2 STUDENT DINING ENLARGED PLAN
A10.11 B2 STUDENT DINING INTERIOR ELEVATIONS

STRUCTURAL

S1.10 CMU WALL OPENING PLAN AND DETAILS

FIRE PROTECTION

FP0.01 B2 FIRE PROTECTION LEGEND & GENERAL NOTES
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MECHANICAL

M0.01 B2 MECHANICAL LEGEND, SCHEDULES, & DETAILS
M3.01 B2 MECHANICAL ENLARGED CAFETERIA PLANS

ELECTRICAL

E0.01 B2 ELECTRICAL LEGEND & LIGHTING FIXTURE SCHEDULE
E3.01 B2 ELECTRICAL ENLARGED CAFETERIA LIGHTING PLANS
E3.02 B2 ELECTRICAL ENLARGED CAFETERIA POWER PLANS
E4.01 B2 ELECTRICAL POWER RISER AND PART PLAN



100% CONSTRUCTION DOCUMENTS BID PACKAGE #2

DEMOLITION LEGEND

GENERAL DEMOLITION NOTES

EXISTING CONSTRUCTION TO REMAIN

EXISTING CONSTRUCTION TO BE REMOVED REFER TO SCHEDULED DEMOLITION NOTES FOR SPECIFIC INSTRUCTIONS

DENOTES APPROXIMATE EXTENTS OF DEMOLITION WORK

-) Prior to the removal of structural walls, beams, lintels and other items, identify same and properly shore and brace as required keeping the structural integrity of the building. See specifications. Areas and methods of making new penetrations and modifications at existing structure shall be approved by the structural engineer prior to performing the work.
- 2) Provide all trenching at existing slabs for electrical, plumbing, mechanical and other utilities as required for demolition of existing utilities and
- 3) Unless otherwise noted, at walls scheduled to be removed by Construction Manager, Construction Manager shall remove all electrical devices. For disconnecting and capping of lines and demolition of other electrical devices, please see electrical drawings.
- 4) See plumbing drawings for removal of plumbing fixtures. Remove piping and other associated work to buried or concealed condition. Patch existing walls to remain to match existing and as required for application of new finish materials. See finish schedule.
- 5) All existing structural columns to remain unless otherwise noted.
- 6) Construction Manager shall coordinate the extent of demolition with proposed work.
- 7) Selective demolition: all items designated for demolition are subject to selective demolition. Coordinate demolition and proposed drawings for the extent of demolition where existing items to remain are subject to new construction and or refinishing.
- 8) Refer to civil, fire protections, mechanical, plumbing, and structural drawings for additional demolition requirements.
- 9) Coordinate with the owner any items to be removed and returned to the owner.
- 10) Maintain existing required exit ways and establish temporary exit way SIGNAGE where necessary to direct occupants. Provide temporary fire rated enclosures when work requires opening fire rated partitions is in progress.
- 11) Verify existing conditions and report discrepancies to architect prior to commencing contract work. Accomplish all work necessary to permit the completion of contract work whether or not such work is directly referenced in contract documents.
- 12) Core holes as required through existing roof and floor decks for new pipes. See plumbing drawings and roof plan for pipe sizes and location. Coordinate with specifications 01 73 29 - Cutting and Patching.
- 13) Construction Manager shall provide temporary whether protection to exposed cavities, interior spaces and all other areas normally sheltered from weather during construction.
- 14) Refer to the door schedule for additional (if any) demotion work on doors and/or door frames that are not indicated on plans.
- 15) Where existing construction is indicated to be replaced it is the intent to remove the existing construction in its entirety as indicated as indicated on the drawings. Refer to construction documents for more information.
- 16) Patch/infill surface for smooth surface in preparation for new surface finish after removal of existing built-in equipment, curbs and floor recesses
- 17) Restore existing construction and finishes beyond contract limits where disturbed by contract work.
- 18) Remove and properly dispose of all items left behind, not identified to be returned over to the owner (i.e. furniture, books, computers, TVs) 19) Remove and dispose of existing door hardware not meeting accessibility requirements. Prepare door and adjacent surfaces for installation of
- 20) Salvage and store all existing painted door with Lite glass (offices) in walls being demolished for reuse/ installation. Existing hardwood doors with full lite glass are to remain. See architectural drawing for additional information.
- 21) Salvage and store all existing six panel wood doors (storage closets) in wall being demolished for reuse/ installation. See architectural drawing for 22) Salvage and store all existing hardwood trim (casing, base, crown, etc.) for reuse in matching and patching. See architectural drawing for
- 23) Remove exposed water and air drops back to a point which would not interfere with the new work. Construction Manager to coordinate extents with scope of the new work and with Owner to confirm line shall not remain in place.

SCHEDULED DEMOLITION NOTES

(1) REMOVE EXISTING FLOORING.

(2) REMOVE EXISTING CEILINGS.

- (3) REMOVE ALL EXISTING PARTITIONS, FLOORS, PLUMBING FIXTURES, AND CASEWORK AS INDICATED.
- (4) REMOVE ALL CEILING GRIDS AND TILES IN LOCATIONS NOTED PLANS AND COORDINATED WITH THE ROOM FINISH
- REMOVE WINDOW UNIT AND ALL ASSOCIATED WOOD BLOCKING, WINDOW TREATMENTS, INTERIOR WOOD TRIM AND APRON AS REQUIRED FOR INSTALLATION OF NEW WORK.
- REMOVE EXISTING DOOR HARDWARE INCLUDING TRANSOM PANEL WHERE OCCURS, PREPARE EXISTING DOOR FRAME AS REQUIRED TO RECEIVE SCHEDULED FINISH, DOOR AND HARDWARE. REFER TO DOOR SCHEDULE FOR ADDITIONAL
- REMOVE EXISTING DOOR(S), FRAME(S), INCLUDING TRANSOM PANEL(S) AND SIDELITE(S), BLOCKING, TRIM AND
- (8) REMOVE CEILING MOUNTED DEVICES AND LIGHT FIXTURES. REFER TO ELECTRICAL DRAWINGS FOR ADDITIONAL
- REMOVE EXISTING CASEWORK, BUILT-IN SHELVING, LOOSE SHELVING, WARDROBES, BASE AND UPPER CABINETS AND
- (10) REMOVE EXISTING PLUMBING FIXTURE(S) AND LINES BACK TO A POINT WHICH WOULD NOT INTERFERE WITH NEW

REMOVE EXISTING GYM EQUIPMENT INCLUDING BUT NOT LIFTED TO PULL UP BAGS, CURTAIN + TRACK, WALL PADS +


- FASTENERS, BLEACHERS, ROPES. PATCH & PREPARE SURFACE FOR NEW FINISH. REMOVE EXISTING WALL MOUNTED PARTITIONS AND ACCESSORIES. PROVIDE BLOCKING AND FURRING AT RECESSES
- TO ALIGN WITH EXISTING WALL FINISH TO RECEIVE NEW.
- (13) REMOVE ALL WALL MOUNTED ITEMS AND PREPARE SURFACE FOR NEW FINISH. (14) REMOVE EXISTING TECTUM WALL PANELS. PATCH & PREPARE SURFACE FOR NEW FINISH.
- (15) REMOVE DOOR FRAME + HARDWARE IN ITS ENTIRETY.

INFORMATION.

- (16) REMOVE DOOR + HARDWARE & PREPARE FRAME FOR NEW DOOR + HARDWARE.
- (17) REMOVE HARDWARE & PREPARE DOOR + FRAME FOR NEW HARDWARE.
- (18) PREPARE EXISTING FLOOR FOR INSTALLATION OF NEW POURED EPOXY FLOOR. SEE ARCHITECTURAL DRAWINGS FOR
- 19) REMOVE & DISPOSE OF ALL WALL MOUNTED ITEMS NOT SCHEDULED TO REMAIN & PREPARE FOR NEW FINISH
- MATERIAL. SEE ARCHITECTURAL DRAWINGS FOR MORE INFORMATION. (20) REMOVE & DISPOSE OF EXISTING ACOUSTICAL CEILING TILES. ALL ITEMS ASSOCIATED WITH EXISTING SUSPENSION SYSTEM ARE TO REMAIN. REFER TO ARCHITECTURAL, MECHANICAL, ELECTRICAL, PLUMBING DRAWINGS FOR MORE
- REMOVE & DISPOSE OF ALL FINISHED CEILING MATERIALS NOT SCHEDULED TO REMAIN, INCLUDING GWB, AND ALL ITEMS ASSOCIATED WITH CEILING SUSPENSION SYSTEM, ACOUSTICAL TILES, ETC. REFER TO ARCHITECTURAL, MECHANICAL, ELECTRICAL, PLUMBING DRAWINGS FOR MORE INFORMATION. LEAVE EXPOSED STRUCTURE ABOVE CLEAN + FREE OF ALL ITEMS SCHEDULED FOR DEMOLITION FOR INSTALLATION OF NEW WORK.




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KEYNOTE LEGEND:

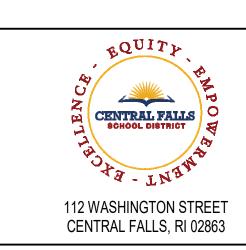
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DRAWING NAME:

DEMOLITION GENERAL NOTES AND LEGEND

REVIEWED BY: SCALE: AS INDICATED | DRAWING NUMBER:

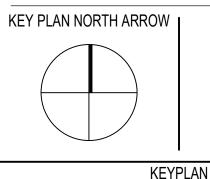

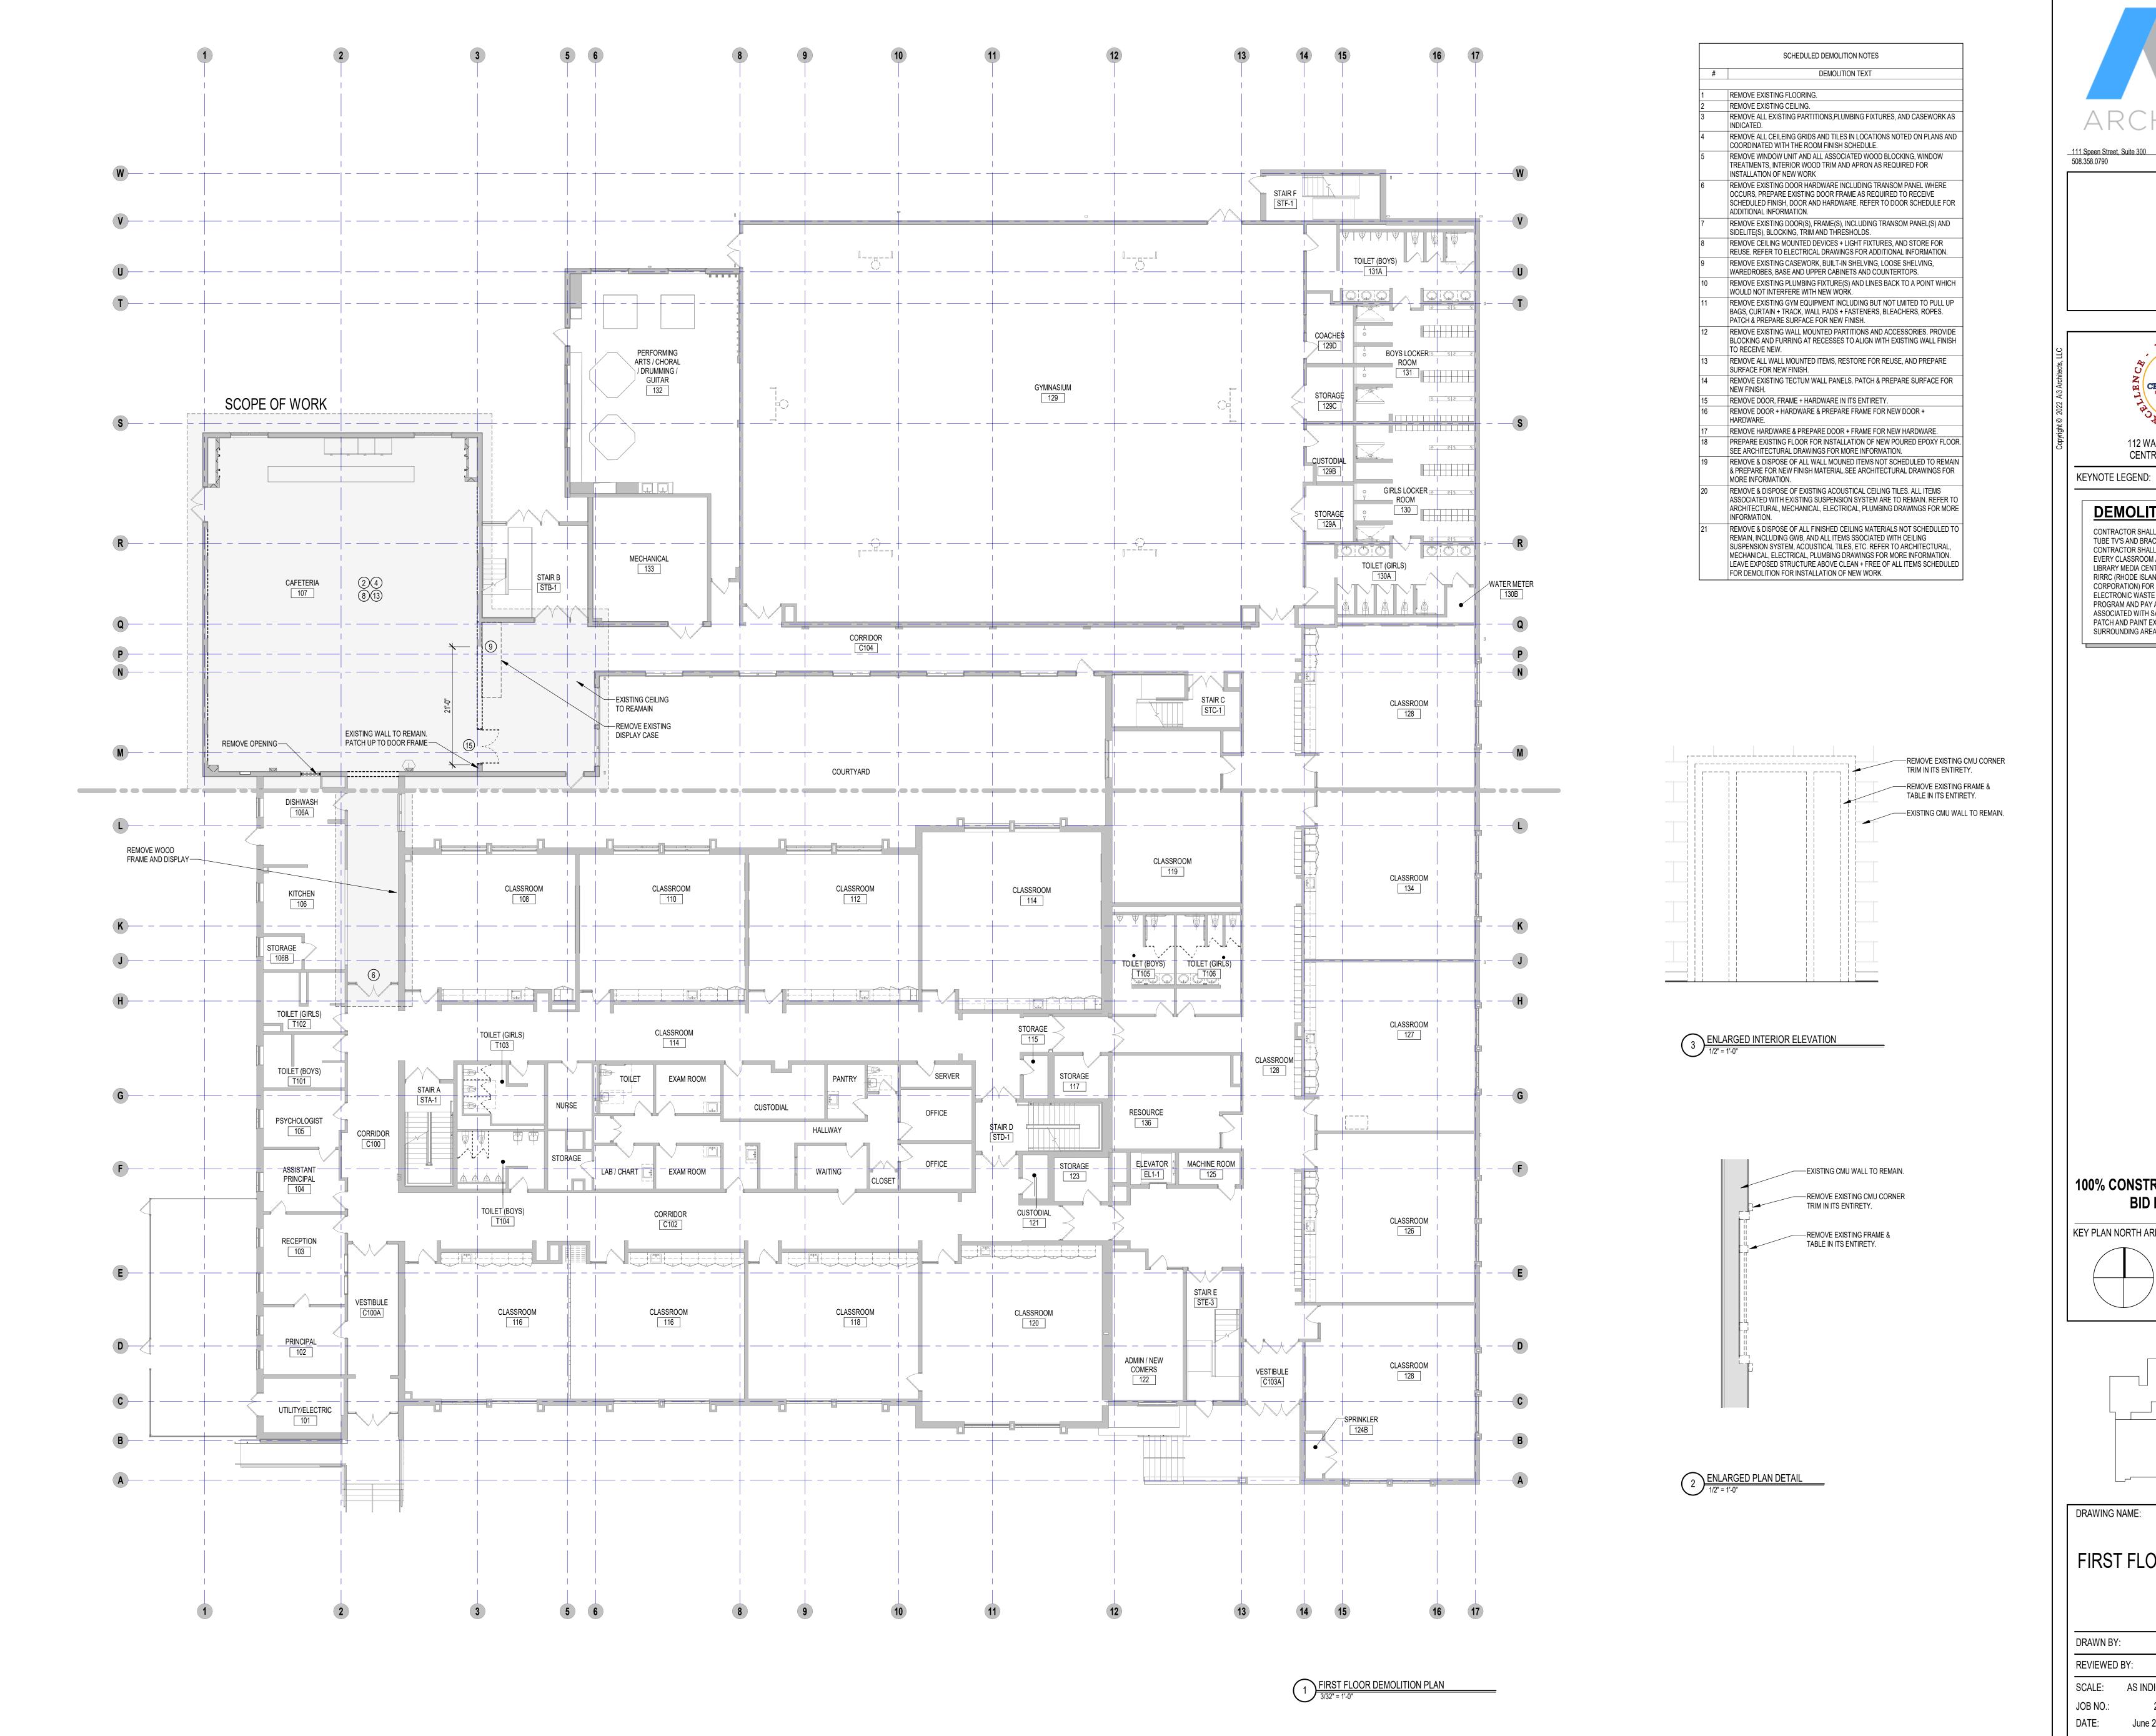


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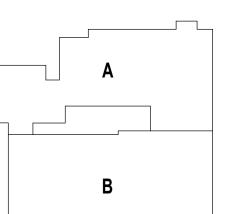


DEMOLITION NOTE:

CONTRACTOR SHALL REMOVE ALL EXISTING WALL HUNG TUBE TV'S AND BRACKETS IN THEIR ENTIRETY. CONTRACTOR SHALL ASSUME ONE TV AND BRACKET PER EVERY CLASSROOM AND TWO TV'S AND BRACKETS IN THE LIBRARY MEDIA CENTER. CONTRACTOR SHALL CONTACT RIRRC (RHODE ISLAND RESOURCE RECOVERY CORPORATION) FOR DISPOSAL OF TV'S AND BRACKETS AS ELECTRONIC WASTE VIA THEIR RESOURCE RECOVERY PROGRAM AND PAY ANY AND ALL APPLICABLE FEES ASSOCIATED WITH SAID DISPOSAL. CONTRACTOR SHALL PATCH AND PAINT EXISTING CMU OR DRYWALL TO MATCH SURROUNDING AREA.


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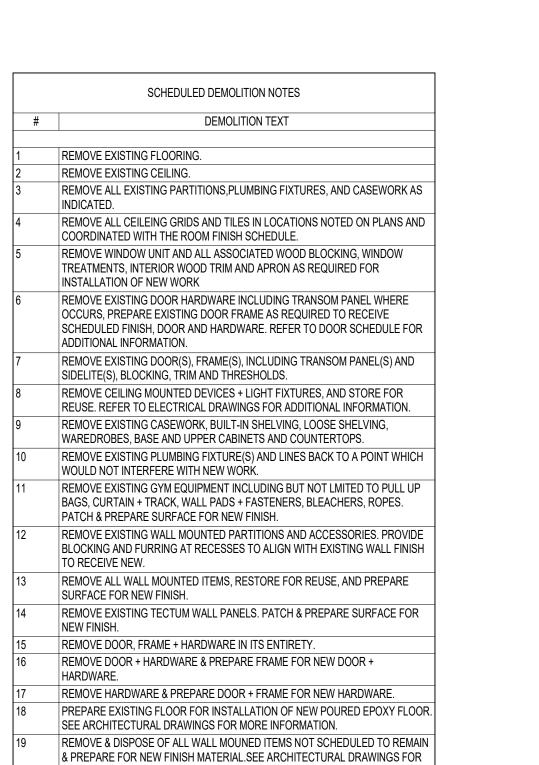


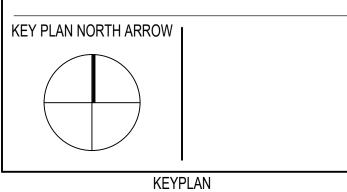

FIRST FLOOR DEMOLITION PLAN

DRAWN BY	·.	MS / NS
REVIEWED	BY:	JQ
SCALE:	AS INDICATED	DRAWING NUMBER:
JOB NO.: DATE:	2202.04 June 22, 2023	DA2.11 B2



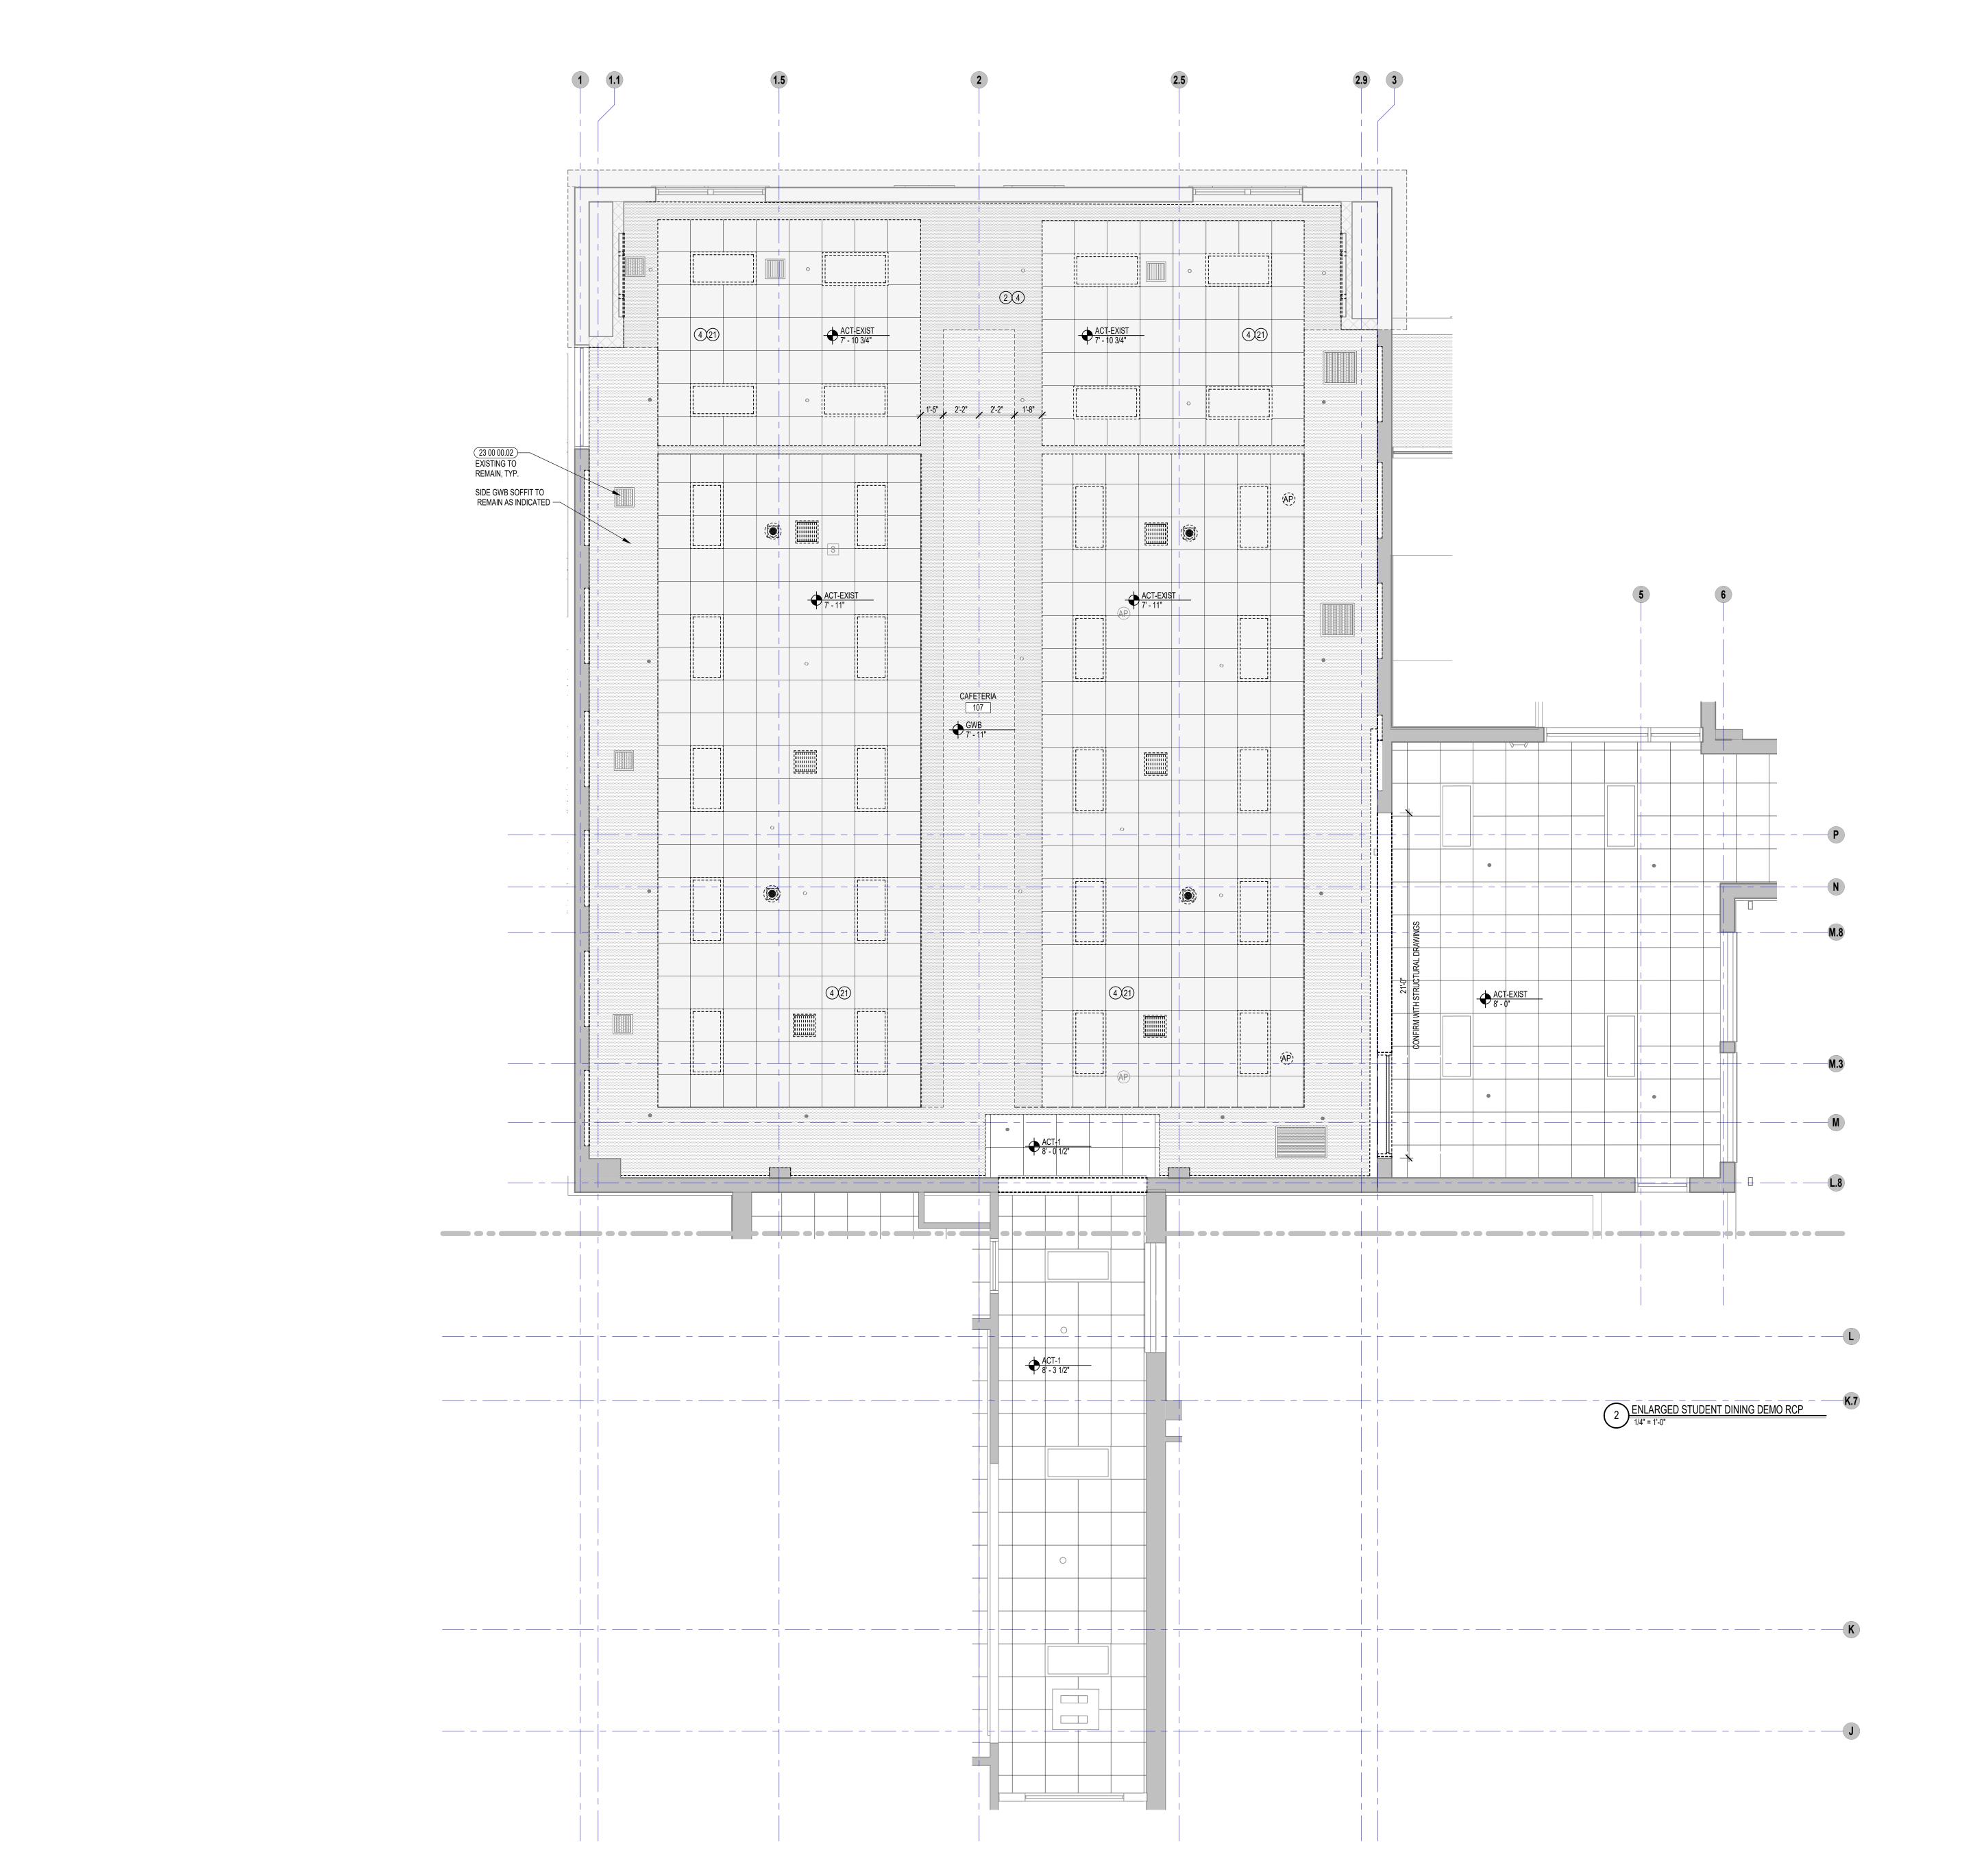

REMOVE & DISPOSE OF EXISTING ACOUSTICAL CEILING TILES. ALL ITEMS ASSOCIATED WITH EXISTING SUSPENSION SYSTEM ARE TO REMAIN. REFER TO ARCHITECTURAL, MECHANICAL, ELECTRICAL, PLUMBING DRAWINGS FOR MORE

REMOVE & DISPOSE OF ALL FINISHED CEILING MATERIALS NOT SCHEDULED TO REMAIN, INCLUDING GWB, AND ALL ITEMS SSOCIATED WITH CEILING SUSPENSION SYSTEM, ACOUSTICAL TILES, ETC. REFER TO ARCHITECTURAL, MECHANICAL, ELECTRICAL, PLUMBING DRAWINGS FOR MORE INFORMATION. LEAVE EXPOSED STRUCTURE ABOVE CLEAN + FREE OF ALL ITEMS SCHEDULED

FOR DEMOLITION FOR INSTALLATION OF NEW WORK.

MORE INFORMATION.

INFORMATION.





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DRAWING NAME:

STUDENT DINING **ENLARGED DEMOLITION**

	DRAWN BY	:	MS / NS
	REVIEWED BY:		JQ
	SCALE:	AS INDICATED	DRAWING NUMBER:
	JOB NO.:	2202.04	DA2.21 B2
	DATE:	June 22, 2023	

KEYNOTES_MASTER LEGEND

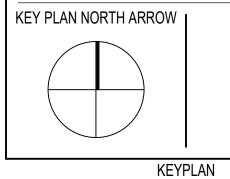03 30 00.01	CONCRETE
03 30 00.03	CONCRETE SLAB ON DECK - SEE STRUCTURAL
04 20 00.01	FACE BRICK - REFERENCE ELEVATIONS FOR TYPE AND COURSING
04 20 00.31	CMU - STANDARD - NORMAL WEIGHT - REFERENCE DRAWINGS FOR DEPTH SIZE AND FIRE RATING
04 20 00.32	CMU BOND BEAM - SEE STRUCTURAL
04 20 00.51	GROUT FILL
05 31 00.01	COMPOSITE STEEL DECK - SEE STRUCTURAL
05 31 00.11	STEEL ROOF DECK - 3 INCH GALVANIZED - SEE STRUCTURAL
05 40 00.03	STEEL STUDS - 3 5/8 INCH - 16 INCHES O.C. MAX
05 40 00.19	STEEL Z-CLIP - 16 GAGE MIN 1 INCH MIN. DEPTH - 16 INCHES O.C. MAX
05 40 00.21	ISOLATION HANGER
05 50 00.10	STEEL ANGLE - SEISMIC CLIP - SEE STRUCTURAL
05 50 00.22	STEEL TUBE - SIZE AS NOTED OR DRAWN
05 50 00.32	STEEL BENT PLATE - SEE STRUCTURAL
05 50 00.41	STEEL PLATE - 1/4 INCH THICK - SIZE AS NOTED OR DRAWN
05 50 00.82	EXPANSION BOLT
06 10 00.23	WOOD BLOCKING - FIRE RETARDANT TREATED - SIZE AS NOTED OR DRAWN
06 10 00.99	WOOD BLOCKING - SIZE AS NOTED OR DRAWN
06 20 00.03	HARDWOOD TRIM - EASED EDGE 1/4 INCH RADIUS - TRANSPARENT FINISH
06 20 00.03	HARDWOOD TRIM - BULLNOSE - TRANSPARENT FINISH
06 20 00.04	HARDWOOD TRIM - 1/2 INCH - TRANSPARENT FINISH
	HARDWOOD TRIM - 3/4 INCH - TRANSPARENT FINISH
06 20 00.23	
06 20 00.62	FLAG HOOK STANDOFF WITH CAP
06 20 00.71	GROMMET - 3 INCH - PLASTIC
06 20 00.72	WIRE MANAGEMENT HOOKS – 12 INCHES O.C. – UNDER COUNTER
06 20 00.73	STEEL UNDER COUNTER SUPPORT BRACKET - SIZE AS NOTED OR DRAWN
06 20 00.81	PLASTIC LAMINATE - TYPE 1
06 20 00.82	PLASTIC LAMINATE BACKSPLASH - 4 INCH
06 20 00.95	REMOVABLE ACCESS PANEL - MATCH ADJACENT FINISH
06 20 00.99	WOOD BLOCKING - SIZE AS NOTED OR DRAWN
06 40 00.33	HARDWOOD VENEER PLYWOOD - 3/4 INCH - TRANSPARENT FINISH
07 21 00.20	GLASS FIBER BLANKET INSULATION - MATCH DEPTH OF STUD - UNFACED
07 21 00.22	GLASS FIBER ACOUSTICAL BLANKET INSULATION - MATCH DEPTH OF STUD - UNFACED
07 21 00.29	
07 21 00.30	MINERAL WOOL INSULATION
07 21 00.32	MINERAL WOOL ACOUSTICAL INSULATION - 3 1/2 INCH
07 84 00.01	FIRE SAFING MINERAL WOOL
07 84 00.02	CAULK - CAULK AND PUTTY
07 84 00.03	FIRE STOP MORTAR
07 84 00.04	FIRE STOP PILLOWS
07 92 00.01	JOINT SEALANT - TYPE AS REQUIRED
07 92 00.02	BACKER ROD AND SEALANT - TYPE AS REQUIRED
07 95 13.01	EXPANSION JOINT COVER - 4 INCH - INTERIOR - FLOOR / FLOOR
08 11 13.10	STEEL DOOR - SEE SCHEDULE FOR TYPES
08 11 13.11	STEEL FRAME - SEE SCHEDULE FOR TYPES
08 11 13.20	STEEL FRAME CLIP BY FRAME INSTALLER
08 11 13.21	STEEL FRAME ANCHOR
08 14 16.01	SOLID CORE FLUSH WOOD DOOR- SEE DOOR SCHEDULE
08 71 00.11	ALUMINUM THRESHOLD
09 21 23.11	METAL SHAFTWALL C-H STUD - 2 1/2 INCH - 24 INCHES O.C. MAX
09 21 23.11	METAL SHAFTWALL J RUNNER
09 21 23.12	GYPSUM SHAFTWALL LINER PANEL - 1 INCH
09 21 23.21	GYPSUM BOARD - 5/8 INCH TYPE X - 1 LAYER
09 21 23.32	GYPSUM BOARD - 5/8 INCH TYPE X - 2 LAYERS
09 21 23.41	METAL SHAFTWALL C-STUD TRACK - 2 INCH
09 21 23.42	METAL SHAFTWALL H STUD - 2 INCH
09 21 23.51	ALUMINUM 2x2x2-1/2 INCH BREAKAWAY CLIP - MAX 10 FEET O.C. VERTICALLY
09 22 16.01	METAL STUD 1-5/8 INCH - 16 INCHES O.C. MAX
09 22 16.03	METAL STUD 3-5/8 INCH - 16 INCHES O.C. MAX
09 22 16.06	METAL STUD 6 INCH - 16 INCHES O.C. MAX
09 22 16.08	METAL STUD 8 INCH - 16 INCHES O.C. MAX
09 22 16.20	METAL STUD - REFER TO FLOOR PLANS FOR DEPTH
09 22 16.21	METAL FURRING CHANNEL - 7/8 INCH - 16 INCHES O.C. MAX
09 22 16.31	BOXED HEADER
09 22 16.41	METAL DEFLECTION TRACK ASSEMBLY
09 22 16.42	METAL DEFLECTION TRACK ASSEMBLY - FIRE RATED
09 22 16.51	METAL STUD BRACE
09 22 16.99	METAL CLIP FOR WALL FRAMING - 16 GA 24 INCHES O.C. MAX
09 29 00.01	5/8 INCH GYPSUM BOARD - LEVEL 4 FINISH - 1 LAYER
09 29 00.02	5/8 INCH GYPSUM BOARD - LEVEL 4 FINISH - 2 LAYERS
09 29 00.09	
09 29 00.11	5/8 INCH PLYWOOD - FIRE RETARDANT TREATED
09 29 00.21	5/8 INCH GYPSUM BOARD - LEVEL 4 FINISH - SAG-RESISTANT
09 29 00.31	5/8 INCH GYPSUM BOARD - LEVEL 4 FINISH - IMPACT RESISTANT
09 29 00.43	CORNER BEAD
09 29 00.43	GYPSUM BOARD SYSTEM - LEVEL 4 FINISH - REFER TO FLOOR PLANS AND WALL TYPES FOR COMPONENTS
09 29 00.99	OT TOOM BOARD OFFICIAL FLEVEL FEMINIOH FILE EN TO LEOUR FLAND MIND WALL TIPES FOR COMPONENTS
09 30 13.11	
09 30 16.01	
09 30 19.01	
09 30 19.51	
09 51 00.01	ACT TYPE-1 - REFERENCE REFLECTED CEILING PLANS FOR GRID PATTERN
09 51 00.02	ACT TYPE-2
09 51 00.04	ACT TYPE-4
09 51 00.51	ACT SUSPENSION SYSTEM
09 51 00.52	EDGE MOLDING SYSTEM
09 51 00.61	PERMITER EDGE TRIM SYSTEM - VERTICAL PROFILE - HEIGHT AS NOTED

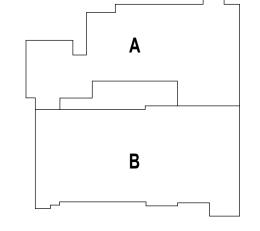PERMITER EDGE TRIM SYSTEM - VERTICAL PROFILE - HEIGHT AS NOTED

WOOD STRIP AND PLANK FLOOR

RUBBER COVE WALL BASE - VENTED

GAME LINES - COURT MARKINGS - PAINTED

WOOD ATHLETIC FLOOR

09 64 66.07 STENCIL LETTERING - PAINTED

ACOUSTICAL CEILING - REFERENCE REFLECTED CEILING PLANS FOR TYPE AND HEIGHT

09 64 66.01

09 64 66.02

09 64 66.09

09 65 13.01

09 65 16.01

09 65 16.11

09 65 19.01 09 65 19.11

09 65 23.02

09 65 23.03 09 65 23.11

09 65 23.12

09 65 36.01

09 65 36.11

09 67 23.01

09 67 23.02 09 68 00.01 09 68 00.11

10 21 13.01 10 21 13.11

10 21 13.31

10 21 23.01

10 44 00.11 11 61 00.21 11 61 00.41

11 66 23.01

11 66 23.11

12 66 13.01

22 00 00.21 23 00 00.02

23 00 00.25

12 30 00.03 TALL CABINET

22 00 00.01 SINK - SEE PLUMBING

WALL PADDING - TYPE 1

12 30 00.21 PLASTIC LAMINATE BACKSPLASH - 4 INCH 12 30 00.22 PLASTIC LAMINATE BACKSPLASH - 6 INCH

DIFFUSER - SEE HVAC

RADIANT PANEL - SEE HVAC


12 30 00.20 PLASTIC LAMINATE COUNTERTOP

VOLLEYBALL STANDARD FLOOR INSERT

12 48 13.01 RECESSED ENTRANCE MAT - REFERENCE DRAWINGS FOR SIZE 12 48 13.10 EXTRUDED ALUMINUM RECESSED FRAMING - L SHAPE

> WATER FOUNTAIN - SEE PLUMBING FLOOR DRAIN - SEE PLUMBING

TELESCOPING POWER ASSISTED BLEACHERS

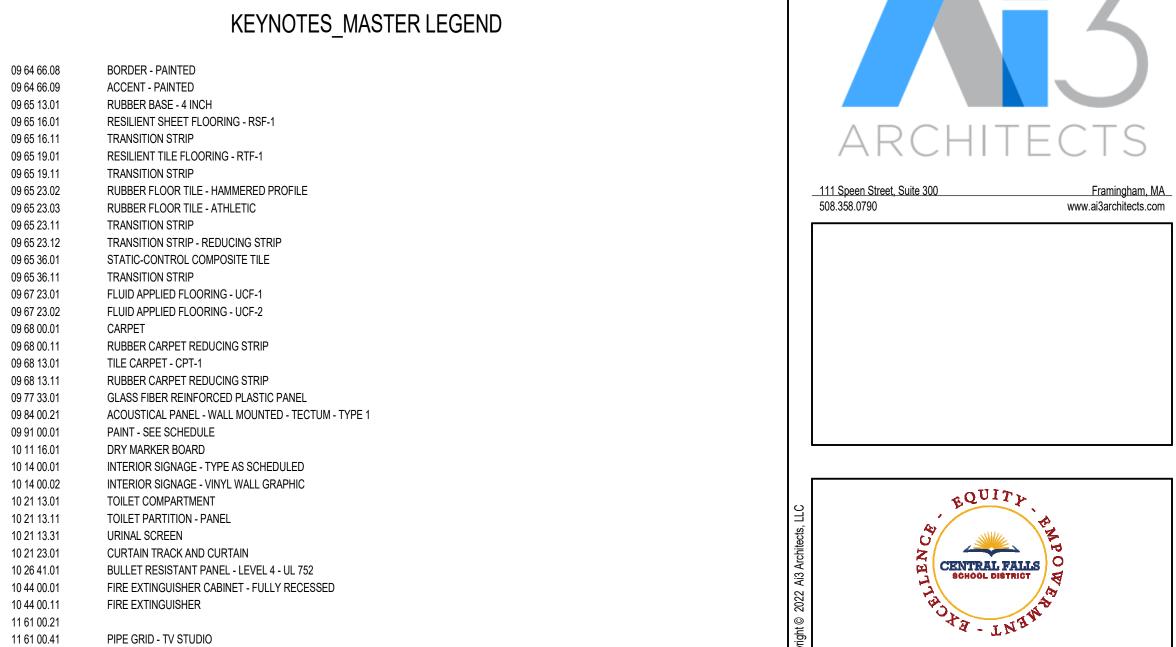



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KEYNOTE LEGEND:






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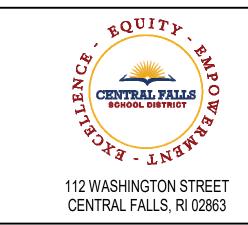
GRAPHIC SYMBOLS		
ROOM NAME	ROOM TAG	
(100-01)	DOOR TAG	
⟨W100-01⟩	WINDOW TAG	
XX	WALL TAG	
BX.X	CASEWORK TAG	
FEC	EQUIPMENT TAG	
0.0 — — — —	NEW COLUMN GRID LINES	
- LEVEL 1	DATUM/SPOT ELEVATION	
X AX.X Ref	BUILDING SECTION	
X AX.X Ref	DETAIL	
X AX.X Ref	WALL SECTION	
X AX.X Ref	CALLOUT	
X AX.X Ref	EXTERIOR ELEVATION	
Ref X AX.X X Ref Ref	INTERIOR ELEVATION	
# VIEW NAME SCALE	TITLE MARK	
	NORTH ARROW	
	WOOD GRAIN DIRECTION	

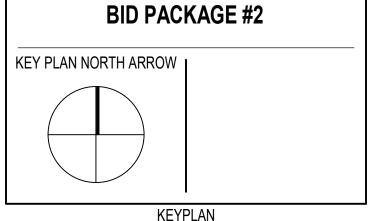	BATT INSULATION
	BRICK, STONE MASONRY
	CONTINUOUS BLOCKING
	INTERMEDIATE BLOCKING
A A A A A A A A A A A A A A A A A A A	CONCRETE
	CONCRETE MASONRY
	EARTH
	FIRESAFING
	GRAVEL
	GYPSUM - PLASTER
	MINERAL FIBER INSULATION
	PLYWOOD
	RIGID INSULATION
	STEEL
	VINYL WALL GRAPHIC
	WOOD FINISH

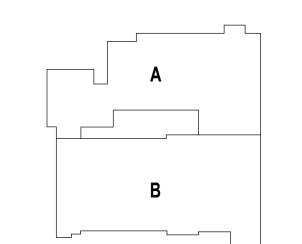





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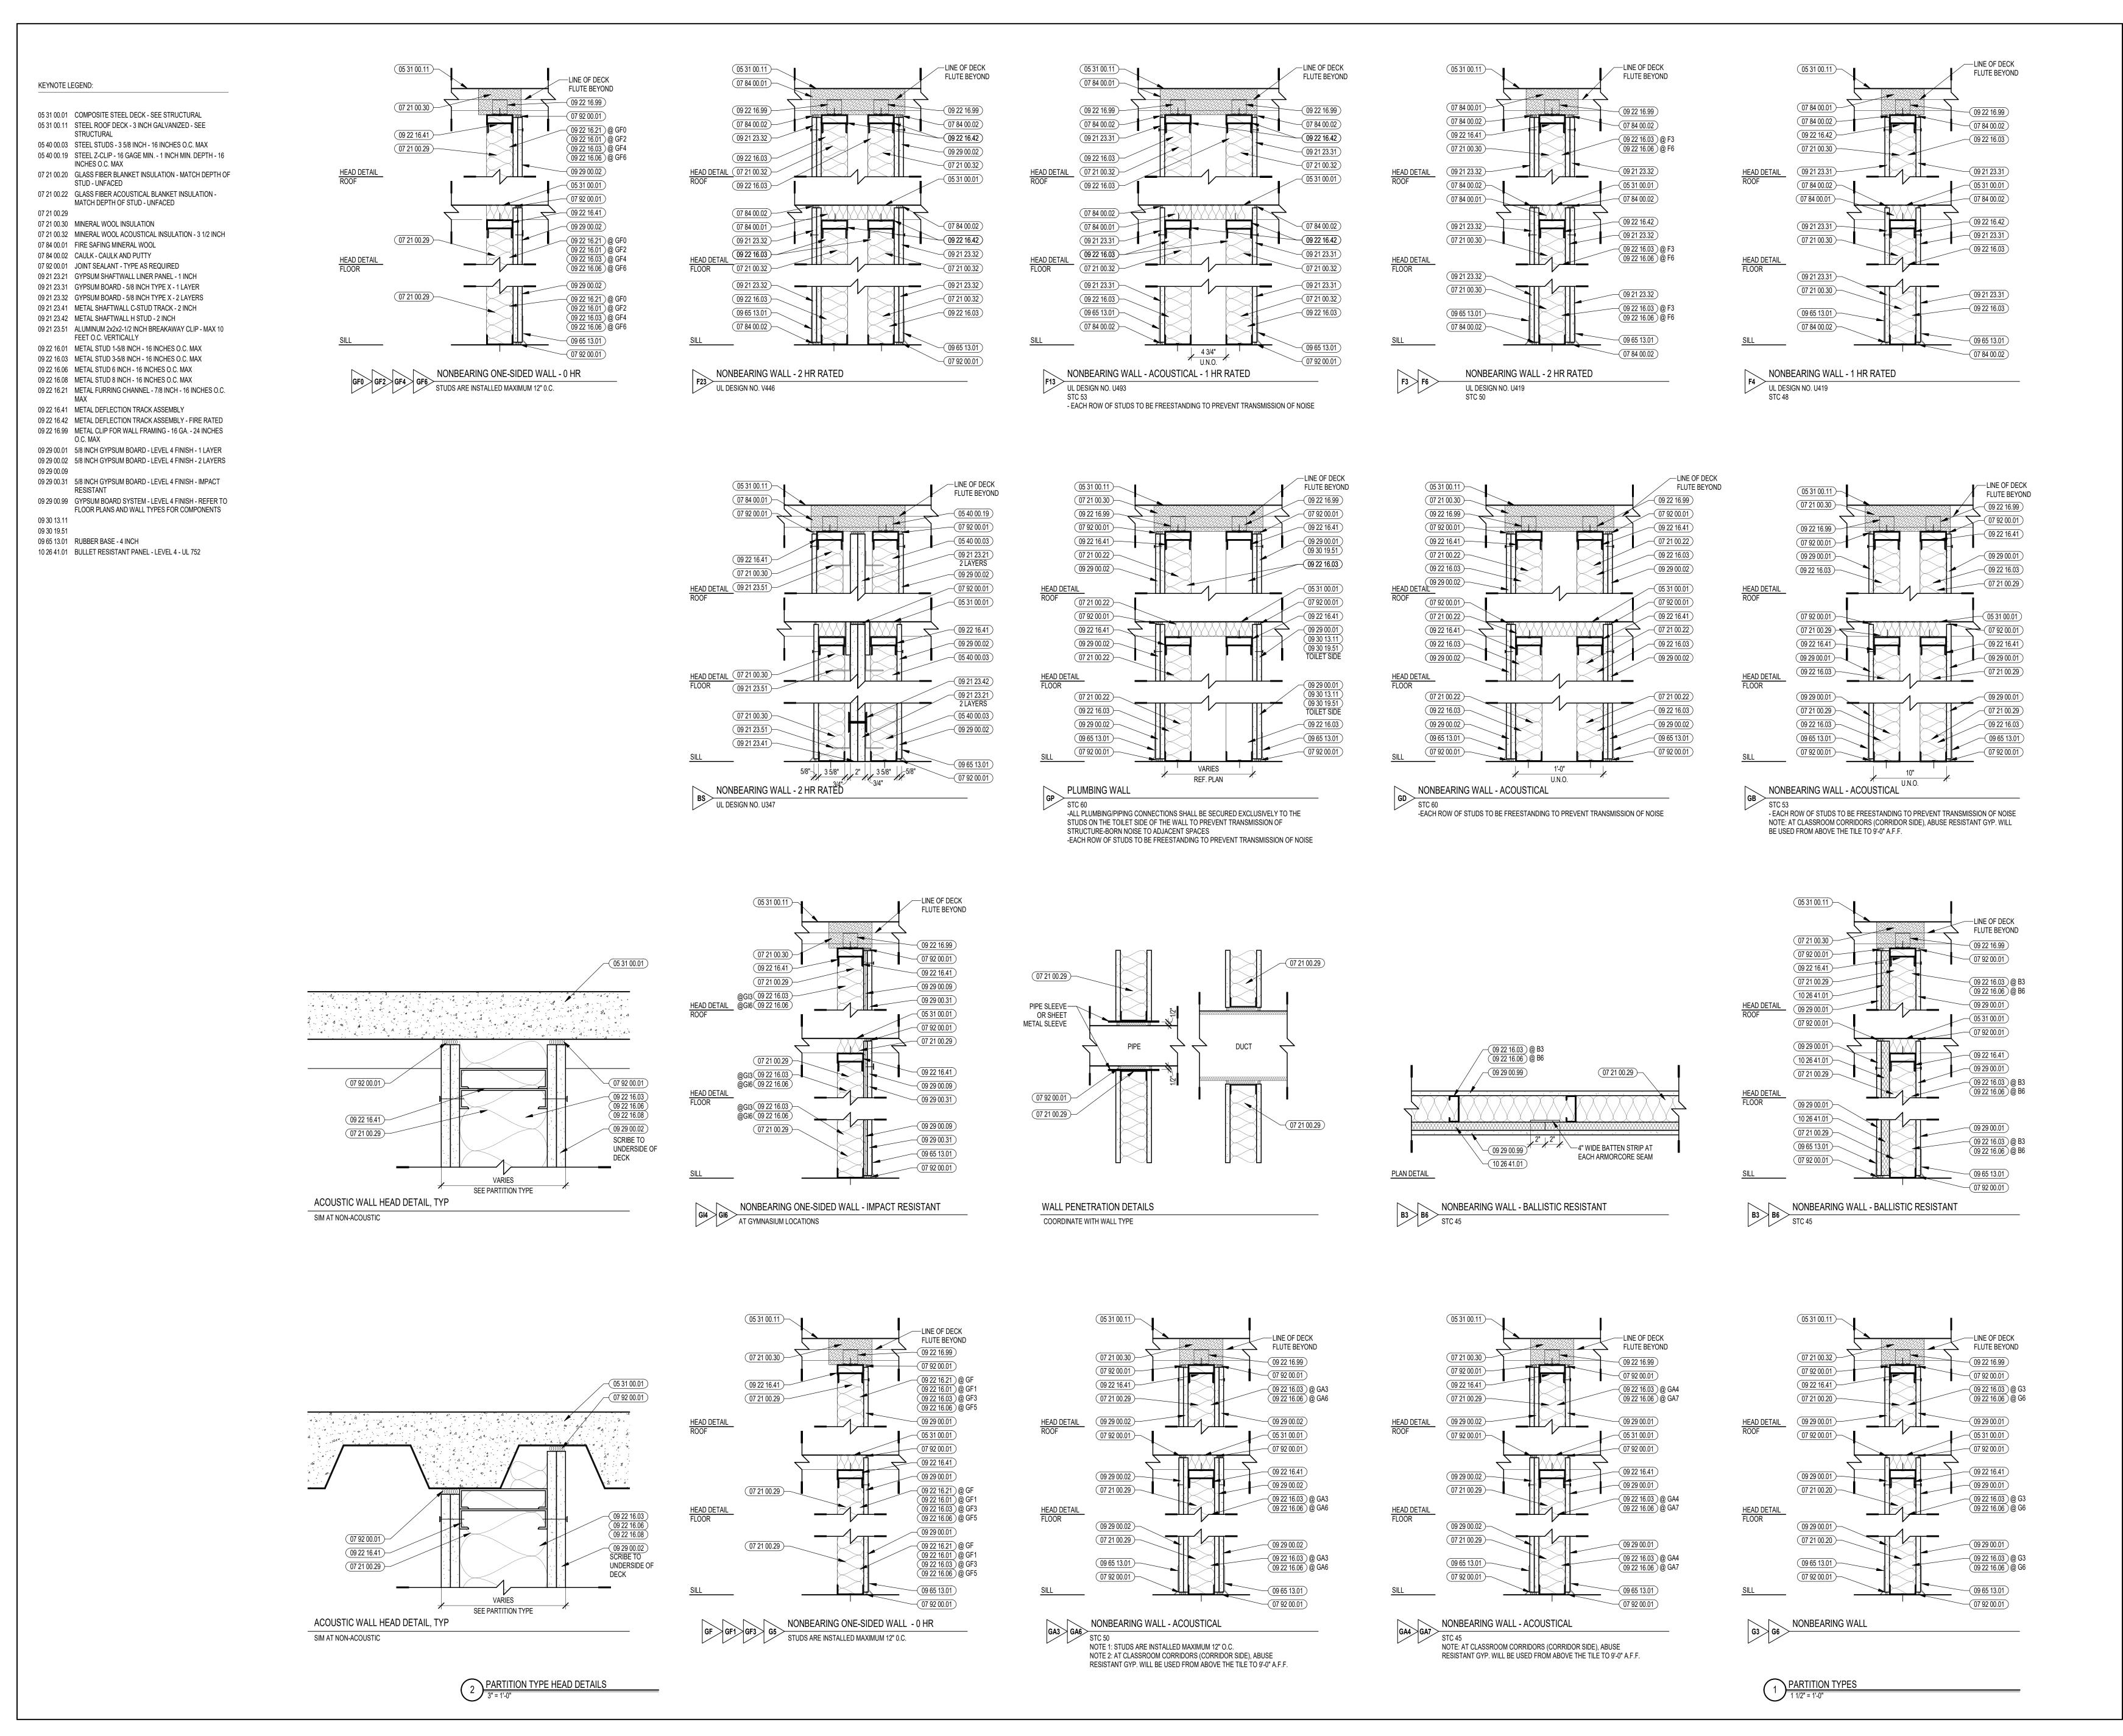


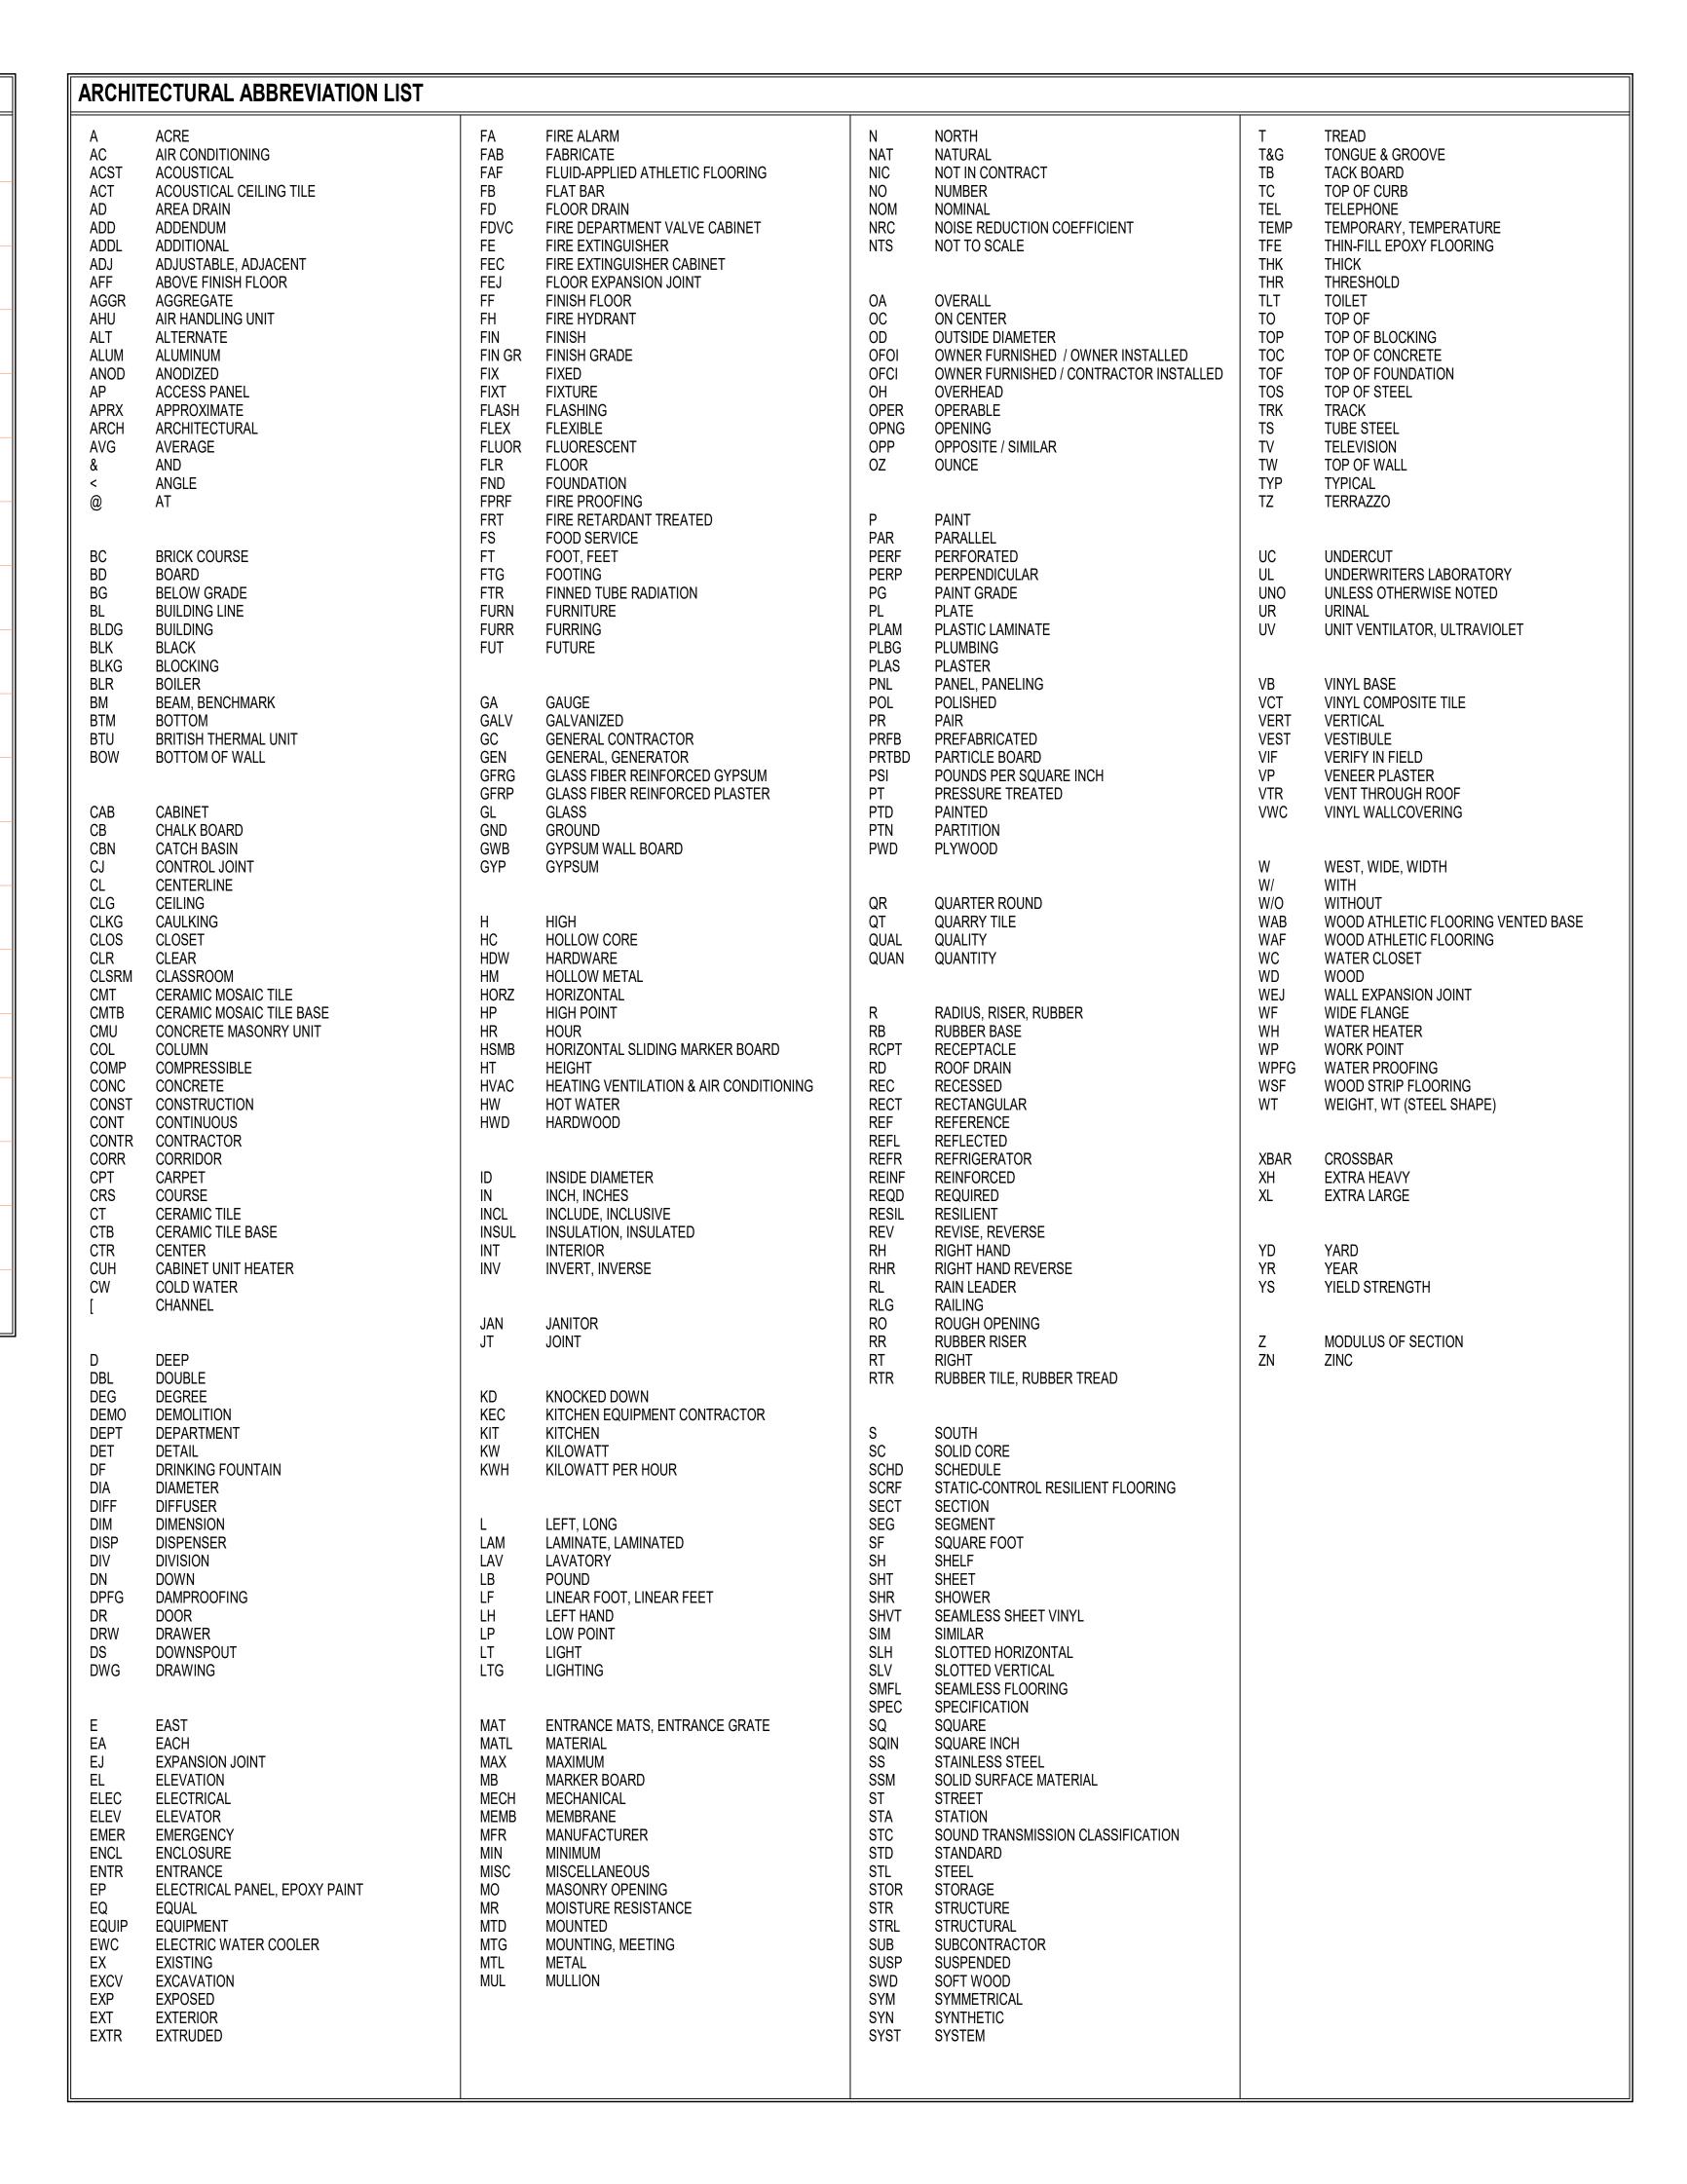

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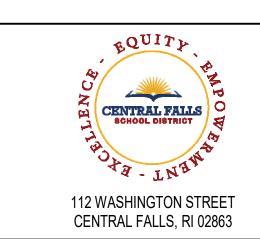
ABBREVIATIONS, SYMBOLS & MATERIALS INDICATIONS

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REVIEWED	BY:	KRK
SCALE:	AS INDICATED	DRAWING NUMBER:
JOB NO.: DATE:	2202.04 June 22, 2023	A0.0B

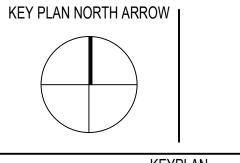

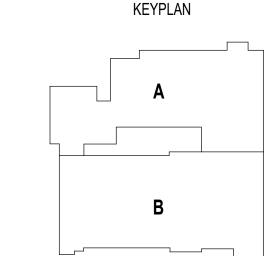

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KEYNOTE LEGEND:

GENERAL NOTES:

1. CONTRACTOR SHALL MAINTAIN THE INTEGRITY OF ALL SPRAY FIREPROOFING, PROVIDE PATCHING & TOUCH UP OF SPRAY FIREPROOFING AS REQUIRED, TYP. CLIP FOR WALL FRAMING AT STRUCTURAL STEEL CONDITIONS (ROOF DECK, COLUMNS & BRACING) KEYNOTED 09 22 16.99 IS REQUIRED TO PROVIDE CLEARANCE FOR SPRAY FIREPROOFING.

2. SEE MECHANICAL DRAWINGS FOR CMU PARTITION PENETRATIONS BY DUCTS,. PROVIDE STEEL LINTELS AS REQUIRED. SEE STRUCTURAL DRAWINGS FOR LINTEL

PENETRATIONS BY DUCTS,. PROVIDE STEEL LINTELS AS REQUIRED. SEE STRUCTURAL DRAWINGS FOR LINTEL SCHEDULE.

3. PROVIDE DIAGONAL BRACING @ METAL STUD PARTITIONS ABOVE CEILING AS REQUIRED.

4. ALL STEEL ANGLE RESTRAINERS & ASSOCIATED STEEL CHANNELS & ANGLES BETWEEN STRUCTURE ARE TO BE FURNISHED BY 05 50 00.

5. SEE STRUCTURAL DRAWINGS FOR SIZES OF ALL STEEL ANGLE RESTRAINERS AND REQUIREMENTS OF FABRICATION METAL BETWEEN STRUCTURAL

MEMBERS.

6. ALL WALL PENETRATIONS INCLUDING, BUT NOT LIMITED TO, PIPING OR DUCTWORK SHOULD BE SEALED. REFER TO WALL PENETRATION DETAILS.

7. SEE INTERIOR ELEVATIONS & ROOM FINISH SCHEDULE FOR WALL FINISHES OR WALL THE APPLICATIONS.

FOR WALL FINISHES OR WALL TILE APPLICATIONS.

8. ALL INTERIOR WALLS SHALL EXTEND TO UNDERSIDE OF DECK, U.N.O.

9. DIMENSIONS ARE TO FACE OF FOUNDATION (F.O.F.), FACE OF STUD (F.O.S.) OR FACE OF MASONRY (F.O.M.), UNLESS NOTED AS "HOLD", "CLEAR", "MIN", "MAX", OR OTHERWISE INDICATED. DIMENSION LINES INTERSECTING AT COLUMN LINES WITH TICK MARKS ARE TO BE TAKE FROM COLUMN CENTER.

10. ANY METAL STUD PARTITIONS EXCEEDING 14'-0" FLOOR

TO FLOOR IN HEIGHT SHALL BE CONSTRUCTED BY COLD-FORMED METAL FRAMING, SECTION 05 40 00, UNLESS NOTED OTHERWISE.

11. GYPSUM BOARD LAYER(S) IDENTIFIED ON WALL TYPES SHALL BE REPLACED AS NOTED:

A. ALL TOILET ROOM & LOCKER ROOM LOCATIONS SHALL HAVE MOISTURE RESISTANT GYPSUM BOARD (09 29 00 33)

SHALL HAVE MOISTURE RESISTANT GYPSUM BOARD (09 29 00.33)


B. ALL CORRIDORS, STAIRS, VESTIBULES, LOBBIES AND OTHER OPEN CIRCULATION AREAS SHALL HAVE ABUSE RESISTANT GYPSUM BOARD (09 29 00.32) FROM FLOOR LEVEL TO 8'-0" A.F.F.

C. ALL FIRE-RATED WALLS SHALL HAVE TYPE "X" GYPSUM BOARD (09 21 23.31 / 09 21 23.32)


D. ALL GYPSUM BOARD SURFACES WITHIN THE GYMNASIUM SHALL BE IMPACT RESISTANT

GYPSUM BOARD (09 29 00.31) FROM FLOOR LEVEL

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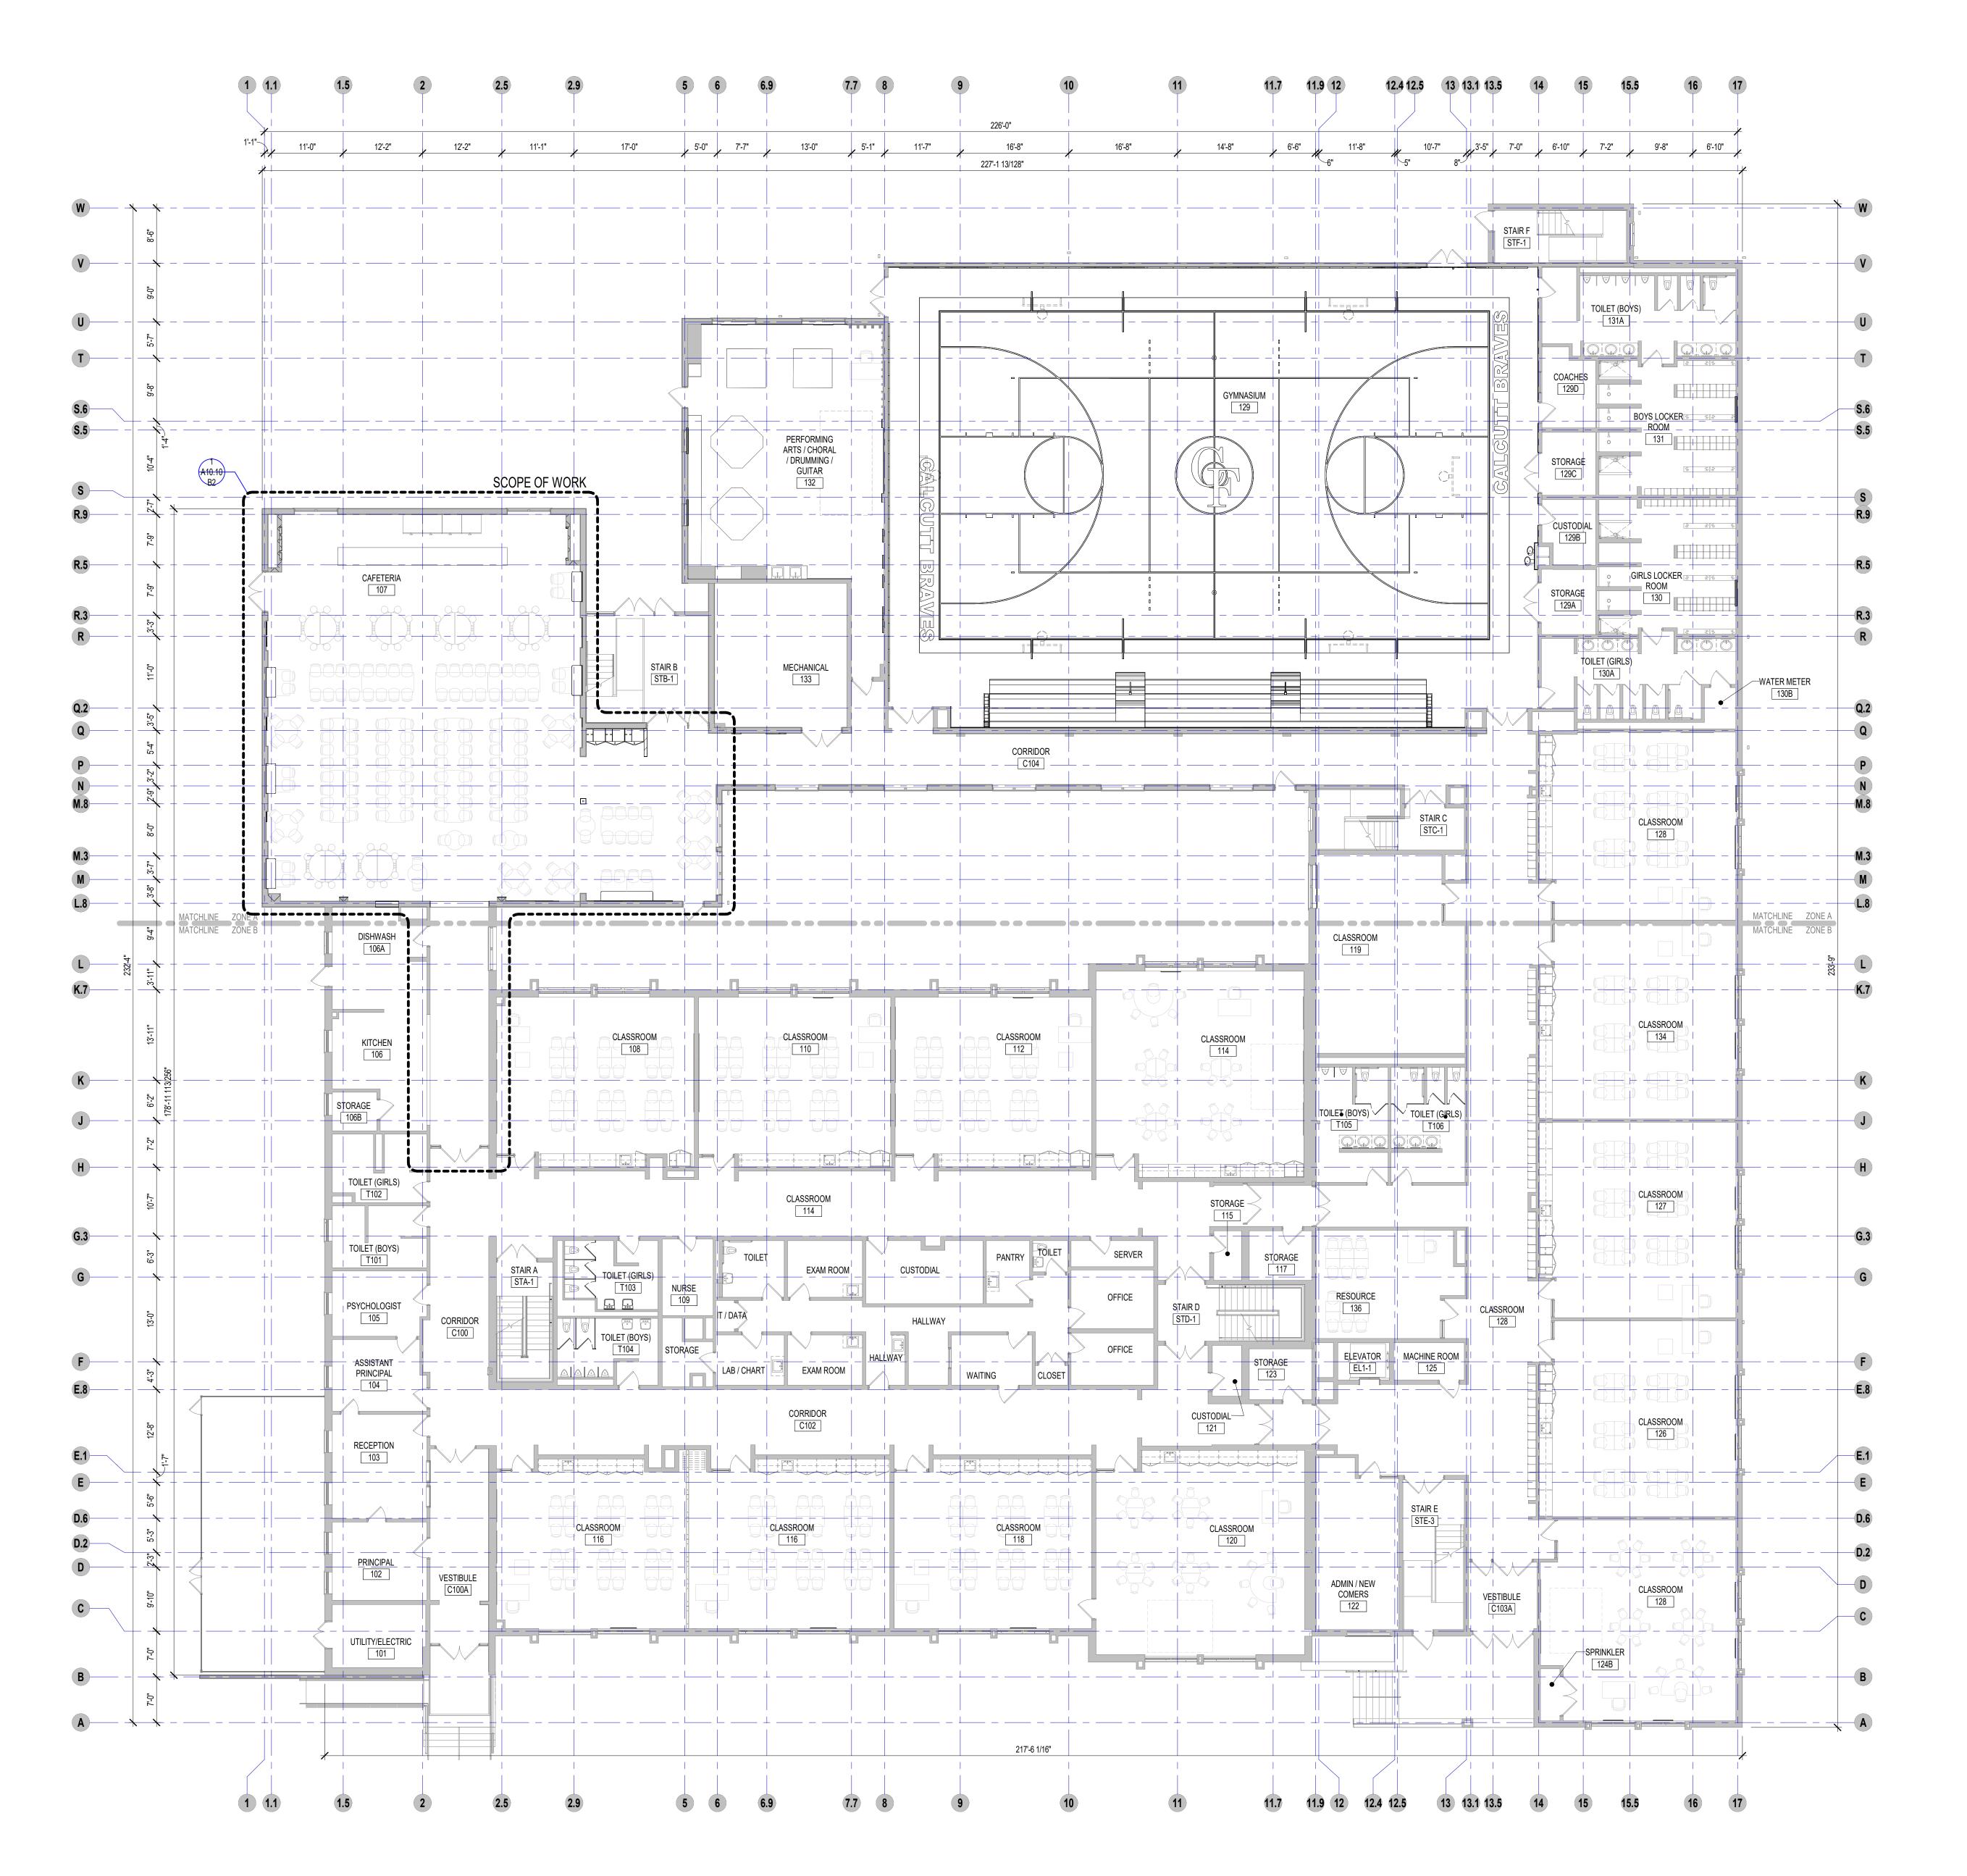
TO 12'-0" A.F.F.

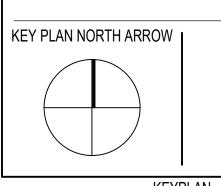

DRAWING NAME:

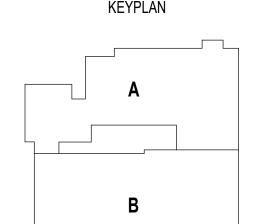PARTITION TYPES

DRAWN BY	·.	KRK / CHR
REVIEWED BY:		KRK
SCALE:	AS INDICATED	DRAWING NUMBER:
JOB NO.: DATE:	2202.04 June 22, 2023	A0.0C







111 Speen Street, Suite 300 Framingham, MA
508.358.0790 www.ai3architects.com

CENTRAL FAILS SCHOOL DISTRICT

112 WASHINGTON STREET CENTRAL FALLS, RI 02863

KEYNOTE LEGEND:

GENERAL NOTES:

1. REFER TO ROOM FINISH SCHEDULE ON A7.01 FOR SCOPE OF WORK FOR NEW FINISHES.

2. ALL EXISTING TOILET ROOMS TO RECIEVE NEW PARTITIONS, FINISHES, AND VANITIES.


FLOOR PLAN LEGEND:



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DRAWING NAME:

OVERALL FIRST FLOOR PLAN


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REVIEWED BY: JO

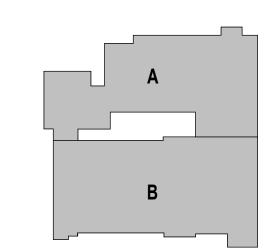SCALE: AS INDICATED DRAWING NUMBER:


JOB NO.: 2202.04
DATE: June 22, 2023

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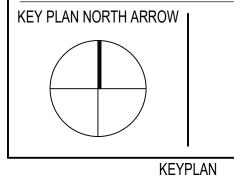



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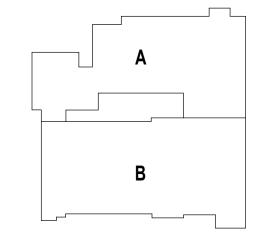


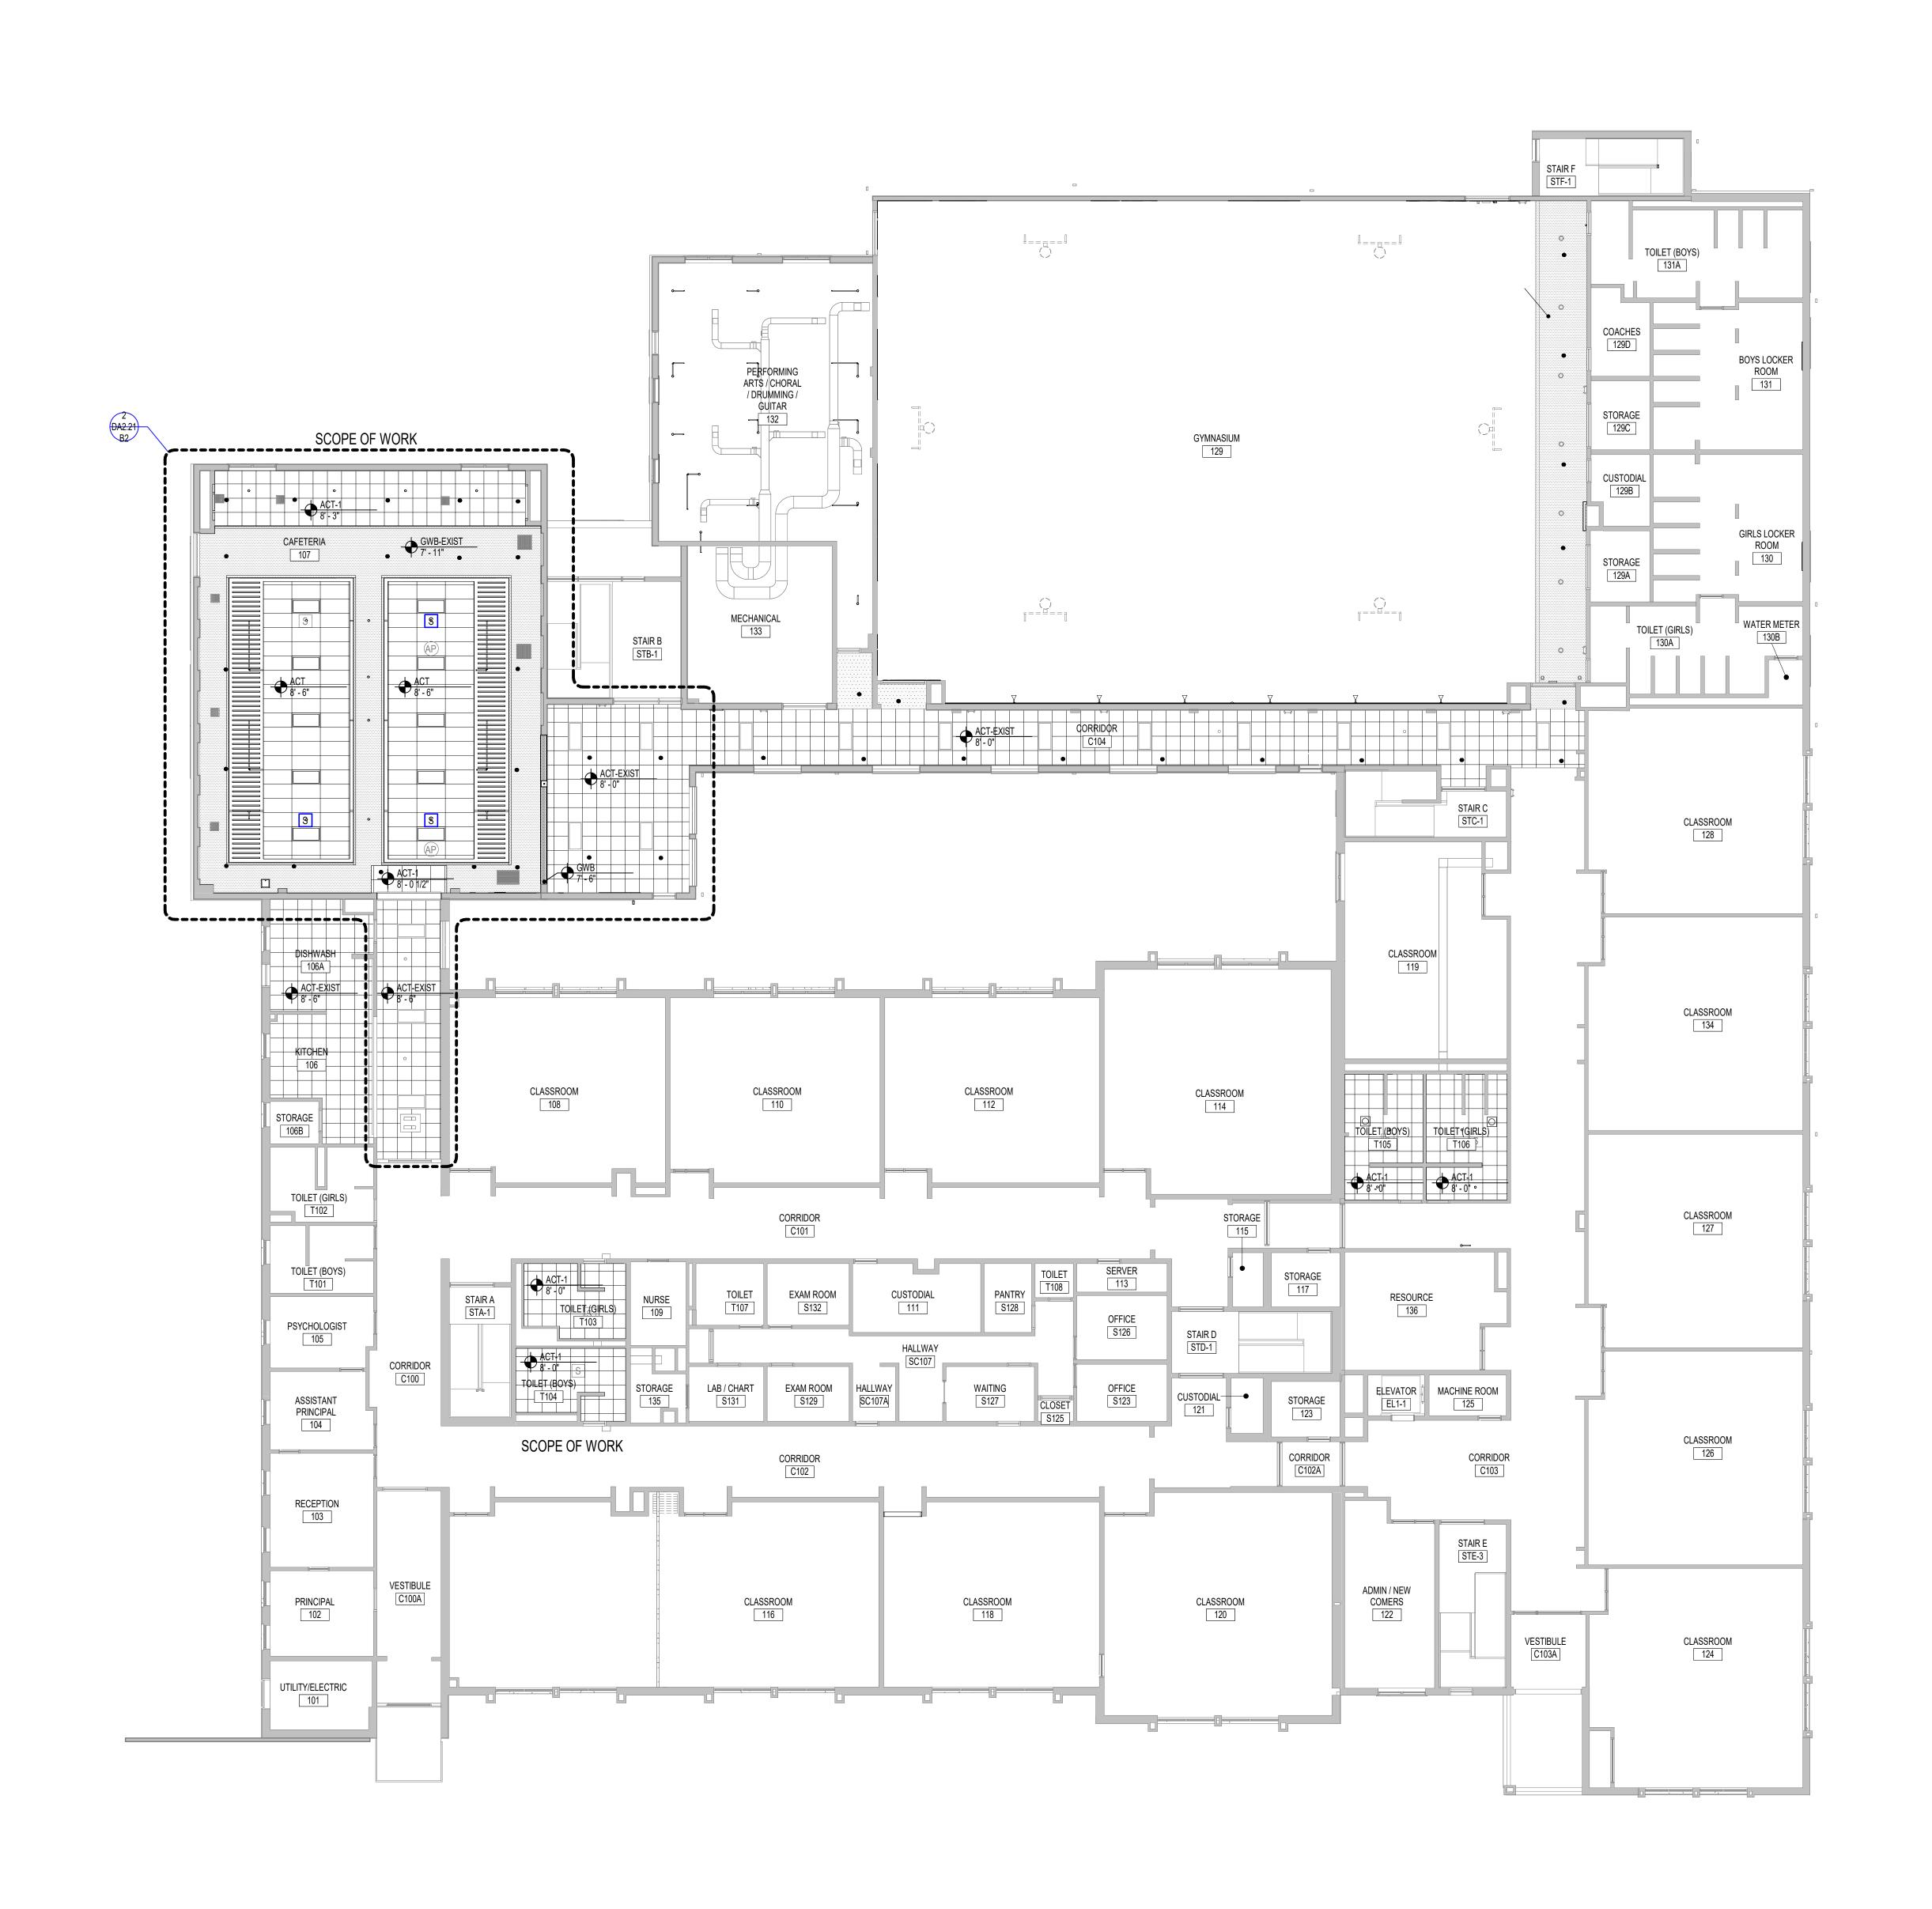KEYNOTE LEGEND:

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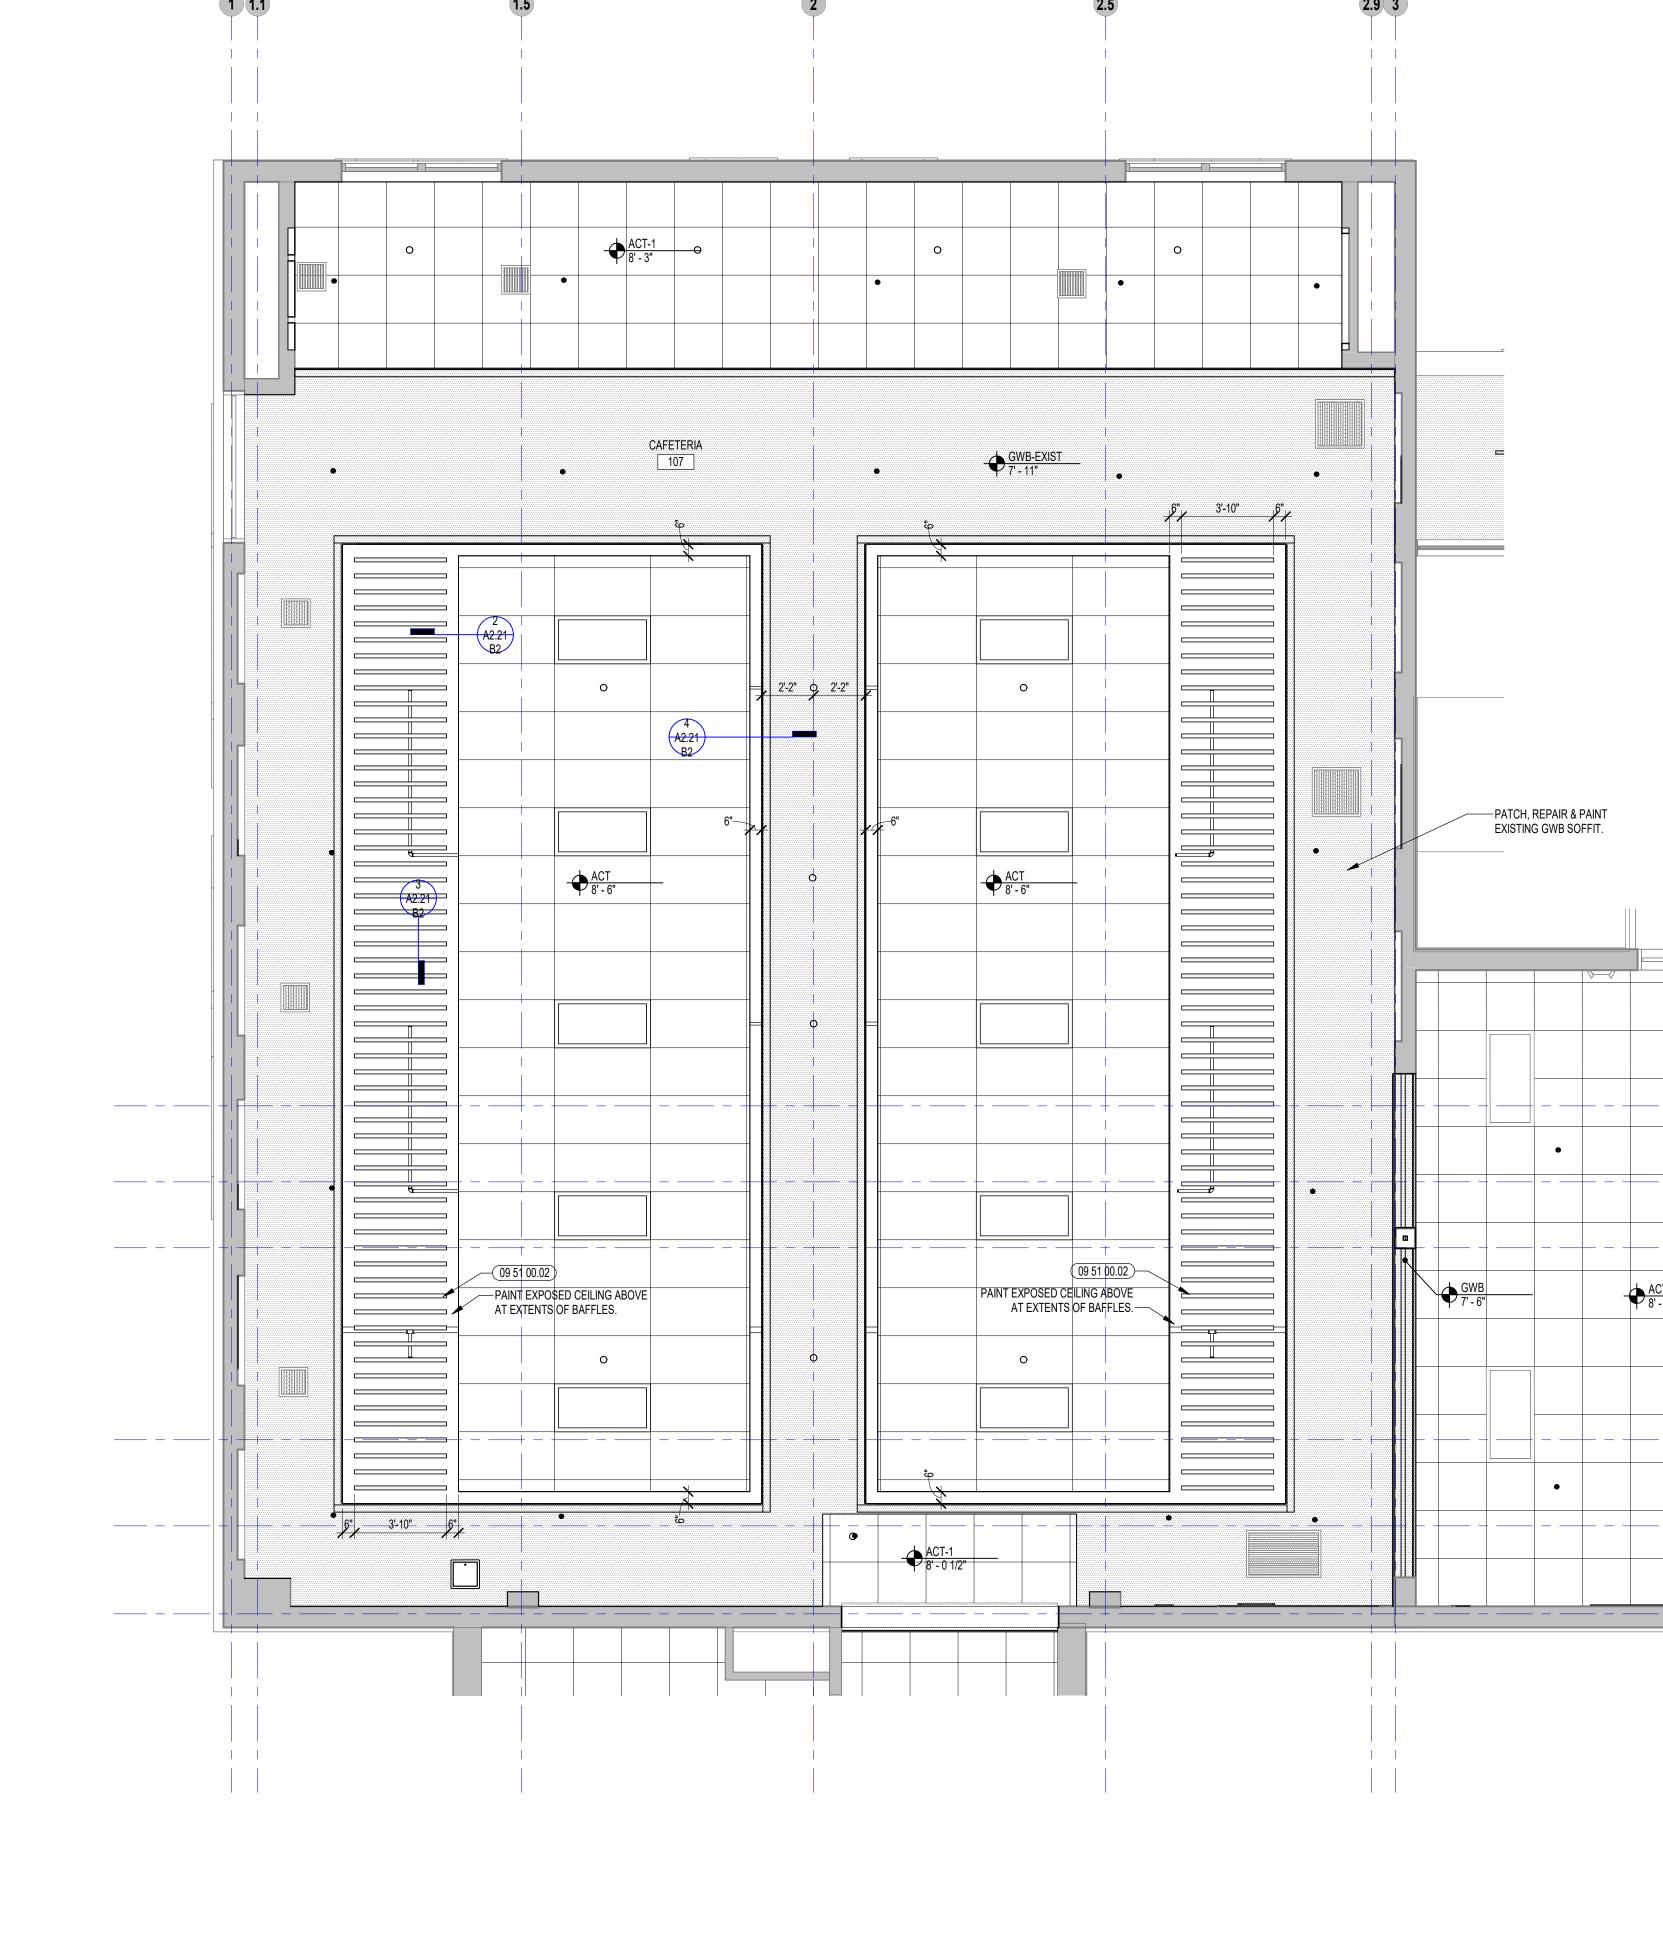


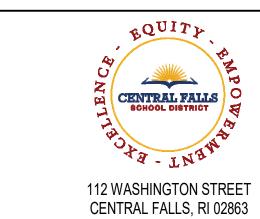



DRAWING NAME:

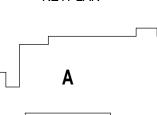FIRST FLOOR RCP

DRAWN BY		MS
REVIEWED	BY:	JQ
SCALE:	AS INDICATED	DRAWING NUMBER:
JOB NO.:	2202.04	A2.11 B2
DATE:	June 22, 2023	/\Z.11 DZ



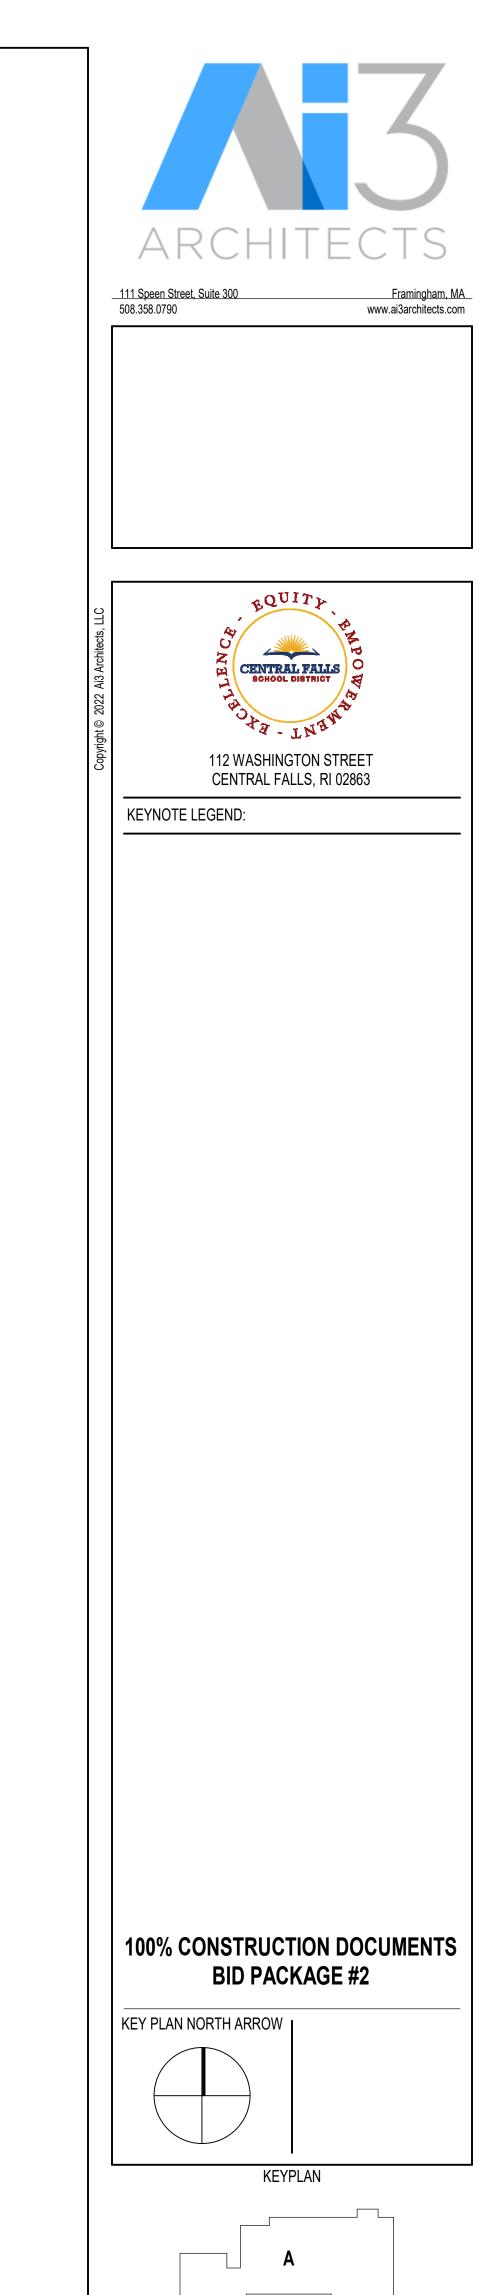

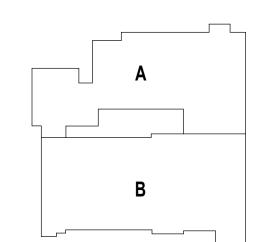



DRAWING NAME:

1 ENLARGED STUDENT DINING RCP
1/4" = 1'-0"

STUDENT DINING **ENLARGED RCP**


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SCALE:	AS INDICATED	DRAWING NUMBER:
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DATE:	June 22, 2023	112.21 02

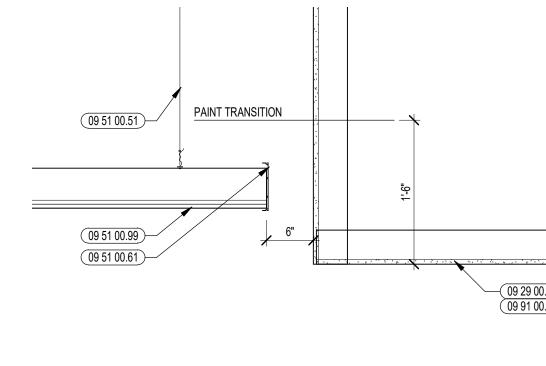

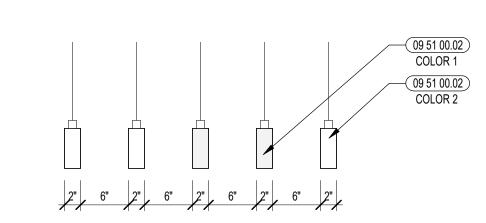

3 ACOUSTIC BAFFLE SECTION DETAIL

1" = 1'-0"

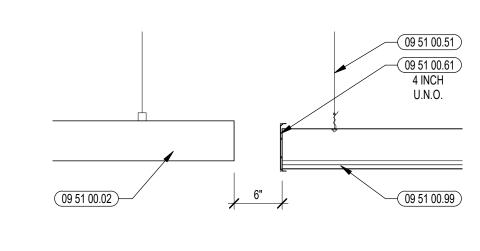

2 AXIOM TRIM SECTION DETAIL

1" = 1'-0"

BBF	REVIATIONS		
ACST	ACOUSTIC	Р	PAINTED FINISH
AL	ALUMINUM	PC	POWDER COAT FINISH
ALG	ALUMINUM AND GLASS	PS	POWER SUPPLY REQUIRED FOR DOOR HARDWARE
CLR	CLEAR FINISH		
НМ	HOLLOW METAL	PS1	POWER SUPPLY REQUIRED FOR DOOR OPERATOR ONLY. NO ELECTRIFIED DOOR HARDWARE.
GL	GLASS		
MFR	MANUFACTURERS STANDARD	PVFD	POLYVINYLDENE FLUORIDE
ОН	OVERHEAD DOOR	SCW	SOLID CORE WOOD (FLUSH)
• • • • • • • • • • • • • • • • • • • •		STL	STEEL
OHC	OVERHEAD COILING DOOR	TBHM	THERMALLY BROKEN HOLLOW METAL
OHCC	OVERHEAD COILING COUNTER DOOR	. 2	FRAME
OHG	OVERHEAD COILING GRILLE		


REMARKS: GENERAL NOTES	
A. PROVIDE INSULATION, WEATHERSTRIPPING AND THRESHOLD AT EX	TERIOR DOORS.
B. ALL EXTERIOR HOLLOW METAL DOORS AND FRAMES TO BE GALVAN OTHERWISE.	IIZED UNLESS NOTED
C. ELECTRICAL (26 00 00) SHALL INSTALL FLEXIBLE CONDUIT IN ALL FRA POSITION SENSORS AND/OR ACCESS CONTROL DEVICES. COORDIN/ LOCATION WITH ACCESS CONTROL (28 00 00).	
D. ALL EXTERIOR DOOR FRAMES SHALL BE PREPARED TO RECEIVE DO AND/OR ACCESS CONTROL DEVICES AS IDENTIFIED IN THE HARDWA SPECIFICATION SECTIONS; 08 71 00 - DOOR HARDWARE AND 28 00 00	RE SET. REFER TO
E. REFER TO FLOOR PLANS FOR DOUBLE EGRESS DOOR FRAMES.	
F. REFER TO MECHANICAL DRAWINGS FOR DOORS THAT REQUIRE UND	DERCUTTING.
G. REFER TO DRAWING A7.02 FOR FLOOR TRANSITION DETAILS. COORD A7.01 - ROOM FINISH SCHEDULE.	DINATE LOCATIONS WITH
H. ELECTRICAL & DOOR HARDWARE SHALL COORDINATE WITH HOLLOW FOR ACCESS CONTROL WIRING, REQUIREMENTS, PATHING, AND LOC	

I. FIELD VERIFY ROUGH OPENING PRIOR TO FABRICATION - IF ANY DISCREPANCY BRING TO THE

NOTICE OF THE ARCHITECT.

FIRST FLOOR		DOOR				FRAME				FIRE				
OOOR # ROOM NAME	DR SIZE	TYPE	MAT'L	THK.	DR FIN	TYPE	MAT'L	FIN.	HEAD	JAMB	SILL	HDW SET	HDW SET RATING	REMARKS
7-01 CAFETERIA	PR 3' - 0" X 7' - 0"	AA	SCW		Р	F1.2	НМ	Р	ETR	ETR	ETR	SD-1.0		EXISTING REUSED
7-02 CAFETERIA	3' - 0" X 7' - 0"	Α	SCW		Р	EX	EX	Р	ETR	ETR	ETR	SD-2.0		EXISTING REUSED
1-01 STAIR B	PR 3' - 1" X 7' - 0"	AA	SCW		Р	EX	EX	Р	ETR	ETR	ETR	SD-1.0		EXISTING REUSED
1-02 STAIR B	3' - 0" X 7' - 0"	Α	SCW		Р	EX	EX	Р	ETR	ETR	ETR	SD-2.0		EXISTING REUSED




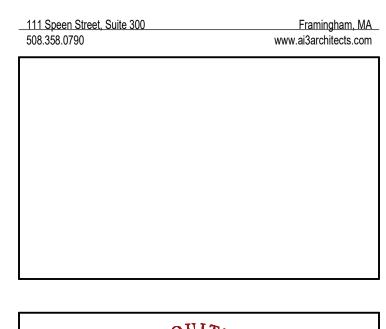


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112 WASHINGTON STREET CENTRAL FALLS, RI 02863

KEYNOTE LEGEND:

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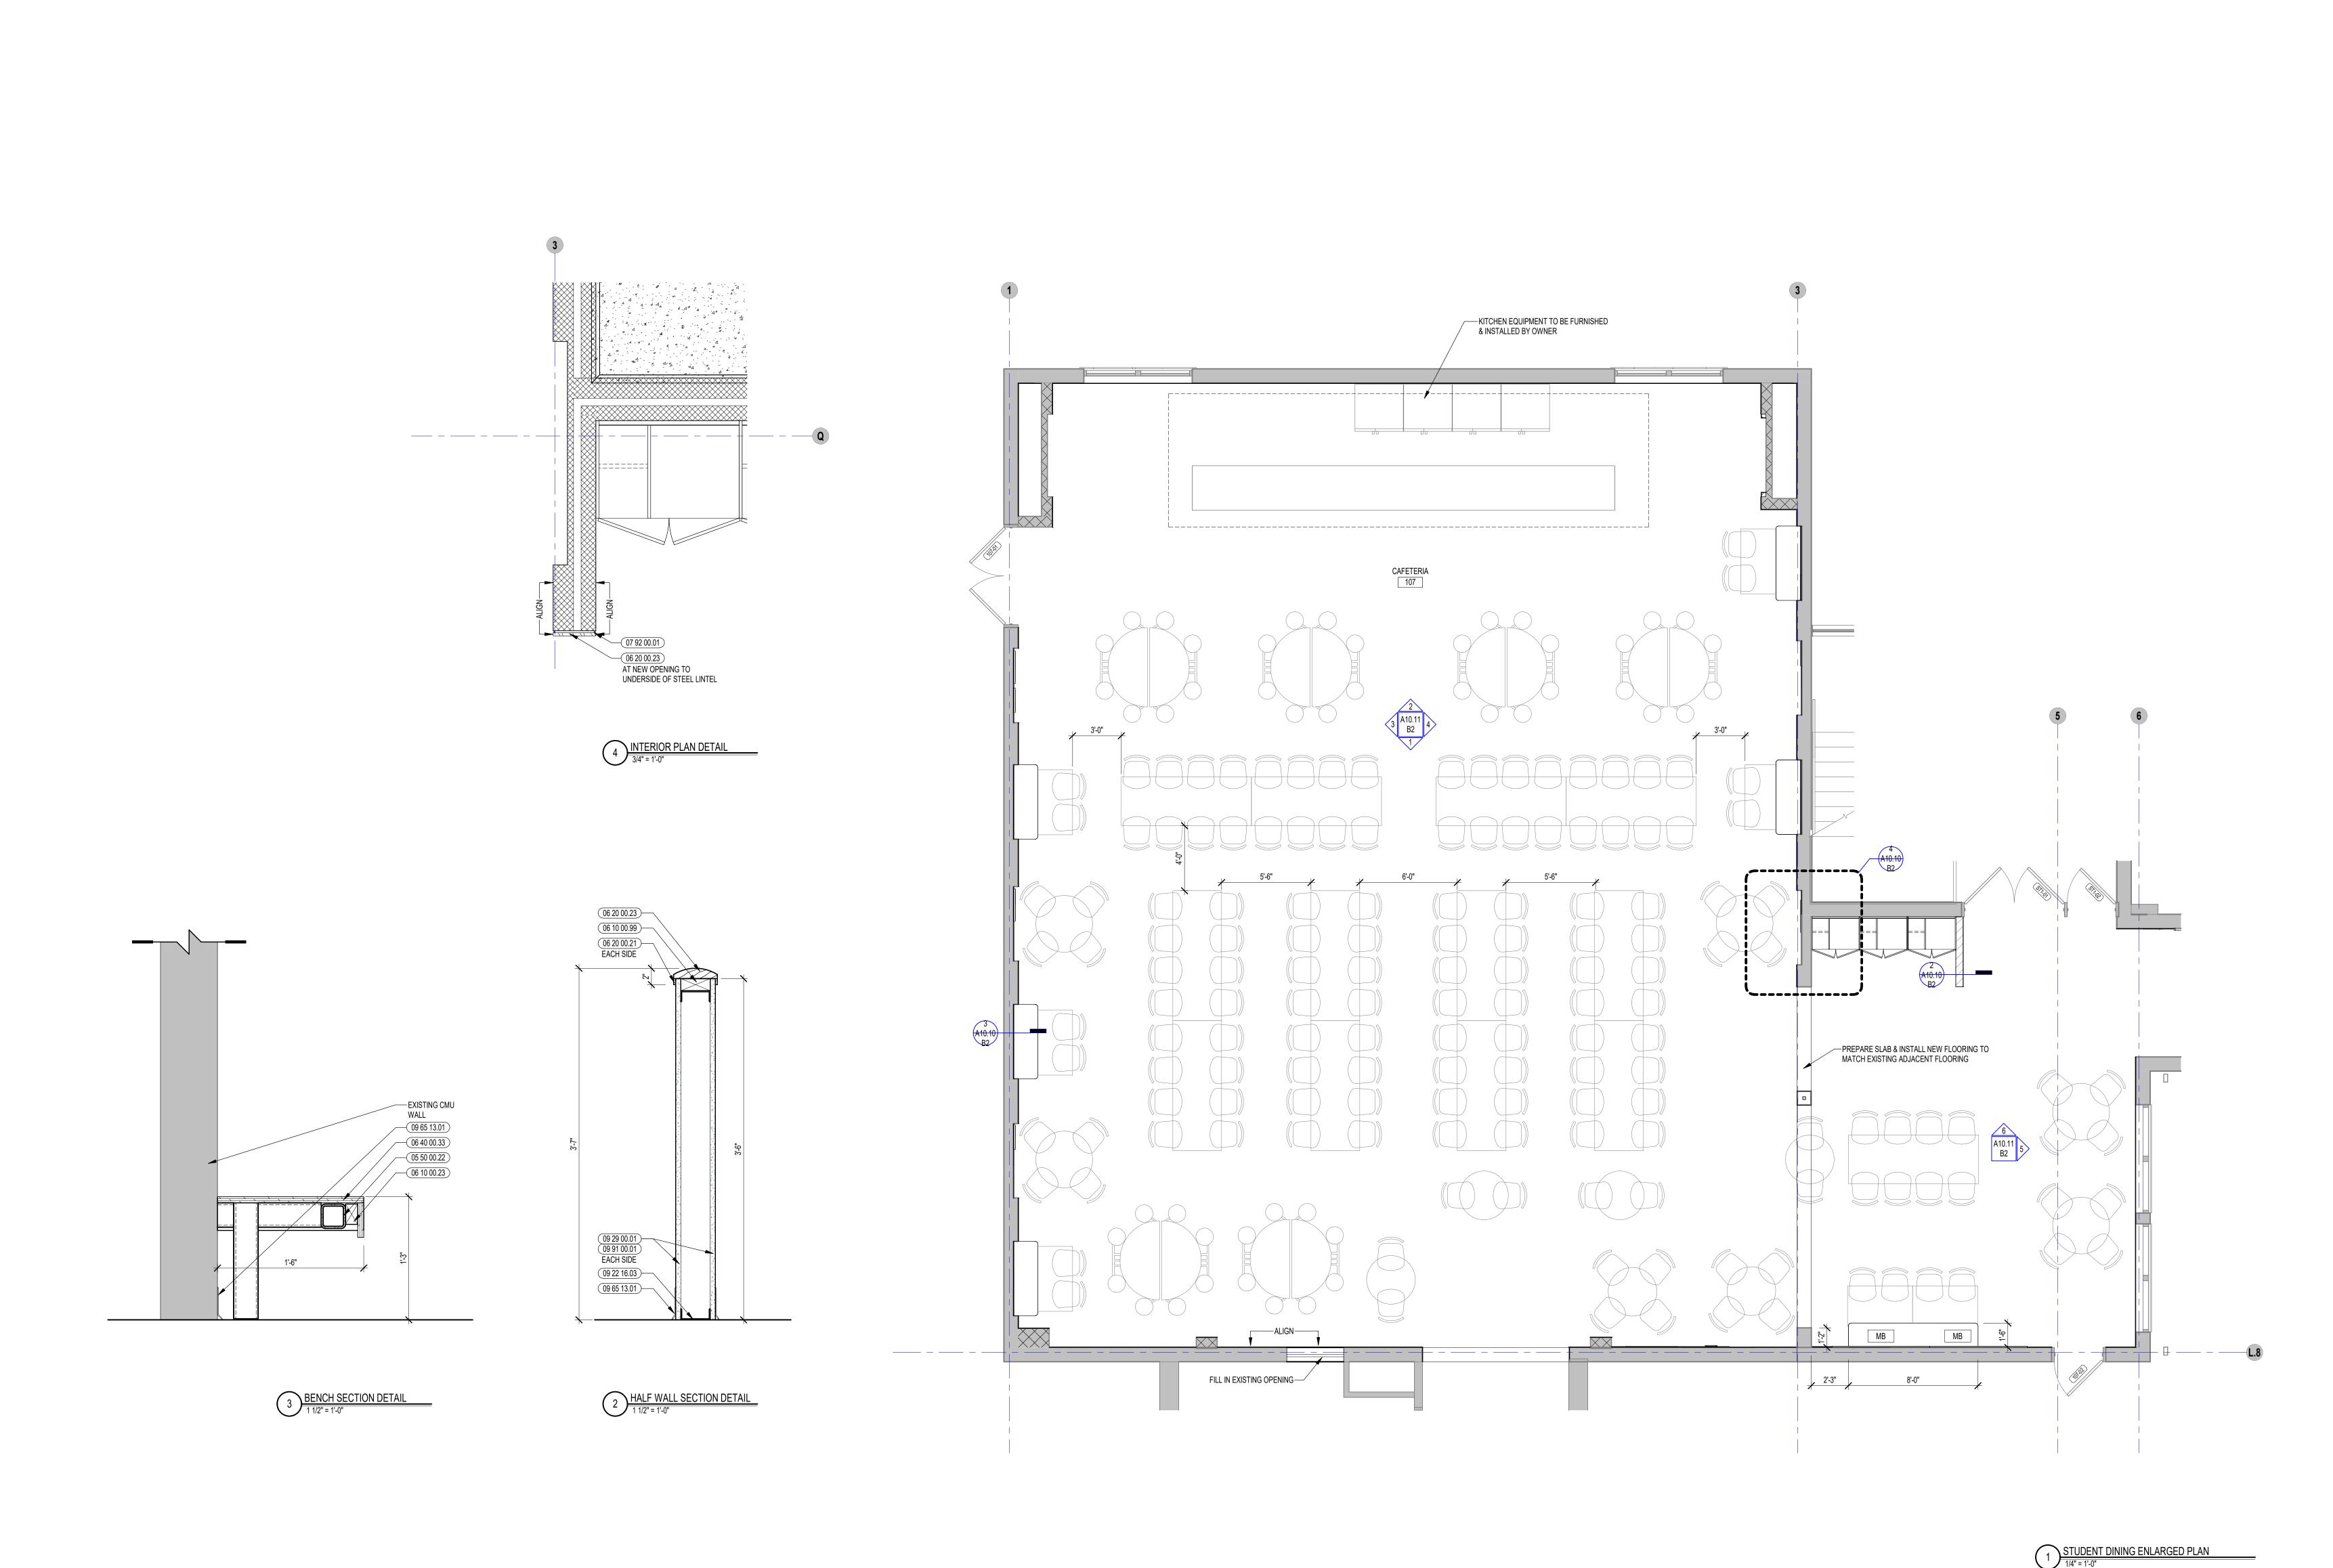
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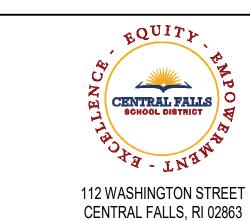
DRAWING NAME:

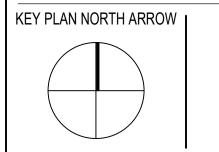DOOR SCHEDULE

DRAWN BY	:	MS
REVIEWED	BY:	JQ
SCALE:	AS INDICATED	DRAWING NUMBER:
JOB NO.:	2202.04	A6.10 B2
DATE:	June 22, 2023	7.0.10 02

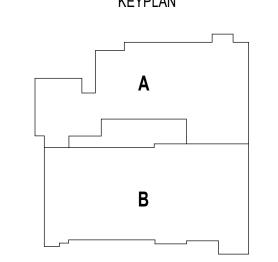





KEYNOTE LEGEND:

05 50 00.22 STEEL TUBE - SIZE AS NOTED OR DRAWN
06 10 00.23 WOOD BLOCKING - FIRE RETARDANT TREATED - SIZE
AS NOTED OR DRAWN
06 10 00.99 WOOD BLOCKING - SIZE AS NOTED OR DRAWN
06 20 00.21 HARDWOOD TRIM - 1/2 INCH - TRANSPARENT FINISH

06 20 00.23 HARDWOOD TRIM - 3/4 INCH - TRANSPARENT FINISH


06 40 00.33 HARDWOOD VENEER PLYWOOD - 3/4 INCH TRANSPARENT FINISH

07 92 00.01 JOINT SEALANT - TYPE AS REQUIRED 09 22 16.03 METAL STUD 3-5/8 INCH - 16 INCHES O.C. M


09 22 16.03 METAL STUD 3-5/8 INCH - 16 INCHES O.C. MAX 09 29 00.01 5/8 INCH GYPSUM BOARD - LEVEL 4 FINISH - 1 LAYER

09 65 13.01 RUBBER BASE - 4 INCH 09 91 00.01 PAINT - SEE SCHEDULE

100% CONSTRUCTION DOCUMENTS
BID PACKAGE #2

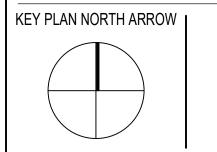




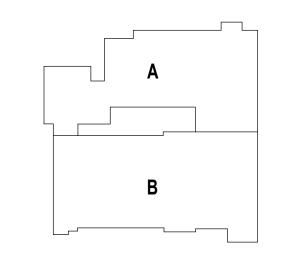


DRAWING NAME:

STUDENT DINING ENLARGED PLAN

DRAWN BY	:	MS
REVIEWED	BY:	JQ
SCALE:	AS INDICATED	DRAWING NUMBER:
JOB NO.:	2202.04	A10.10 B2
DATE:	June 22, 2023	7110.10 02

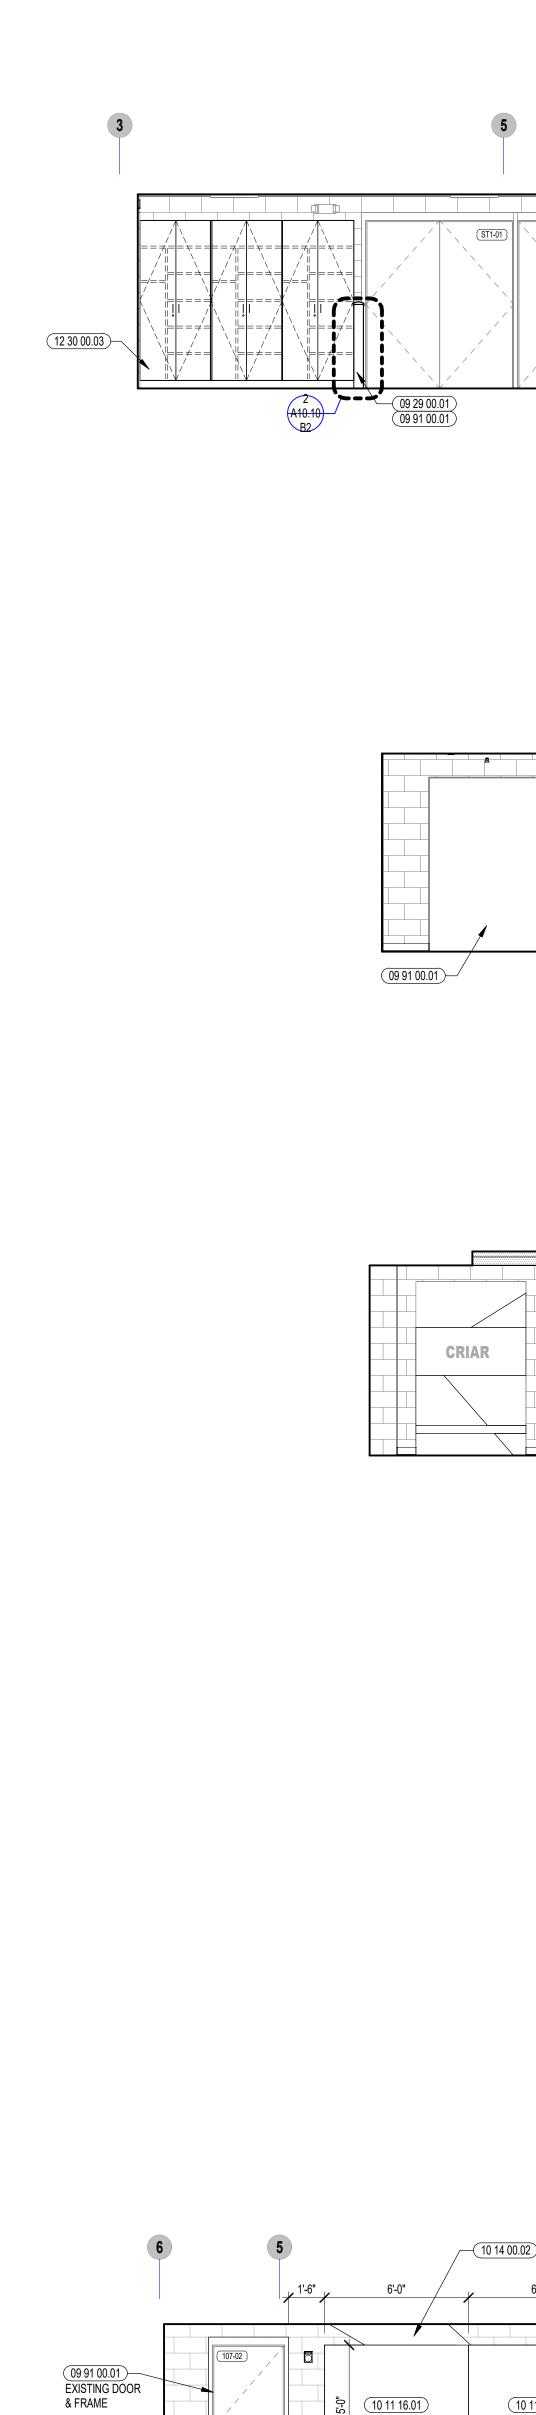

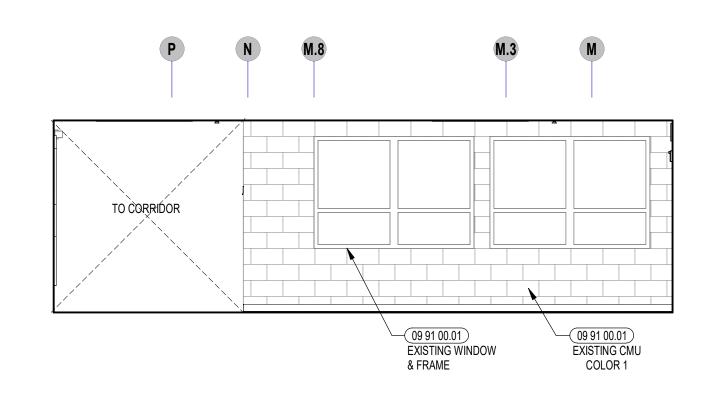


6 STUDENT DINING INTERIOR ELEVATION


1/4" = 1'-0"


09 91 00.01 EXISTING DOORS & FRAME 10 14 00.02

5 STUDENT DINING INTERIOR ELEVATION

1/4" = 1'-0"

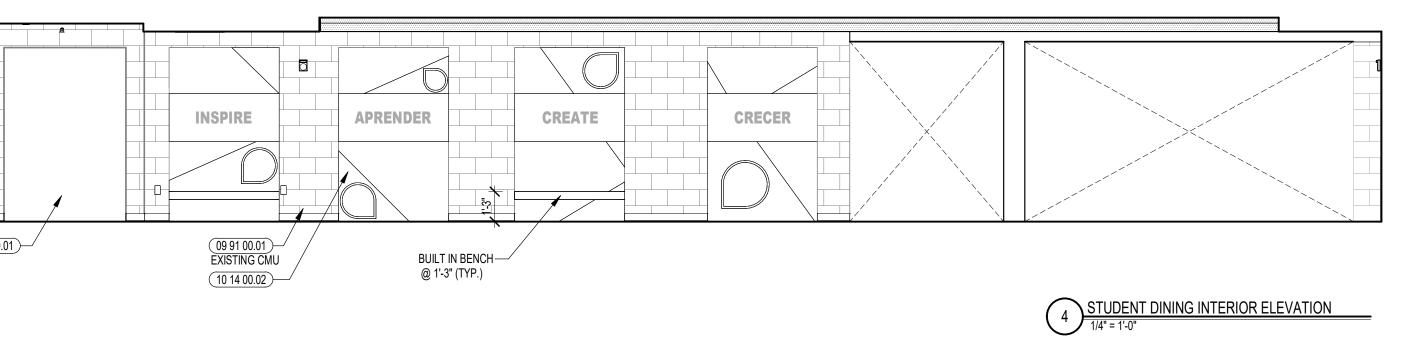


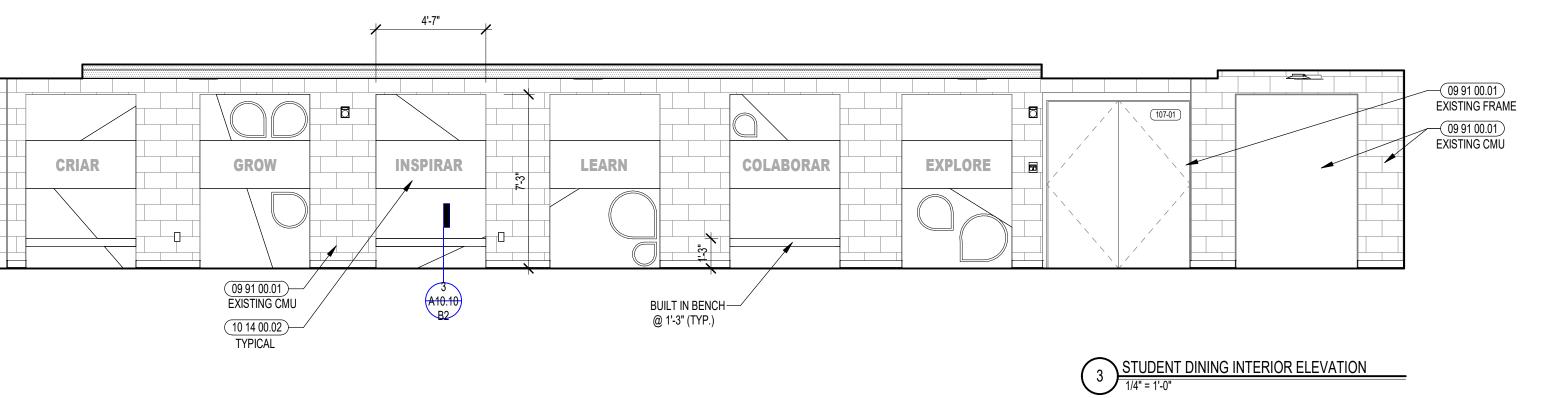

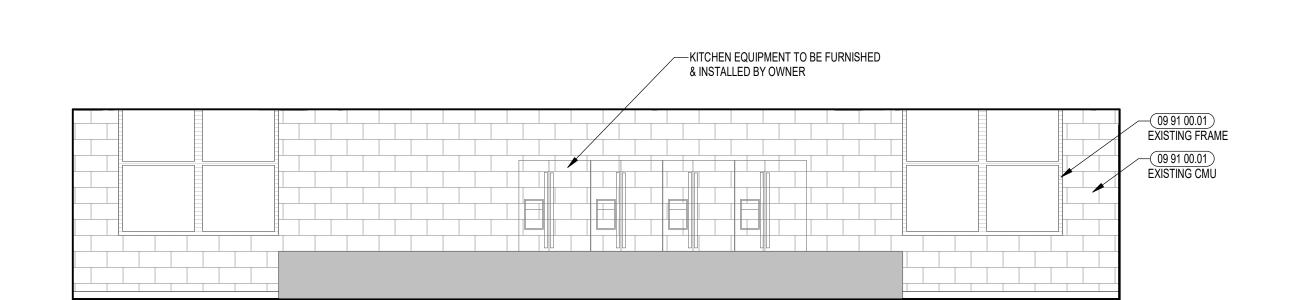


2 STUDENT DINING INTERIOR ELEVATION

1/4" = 1'-0"

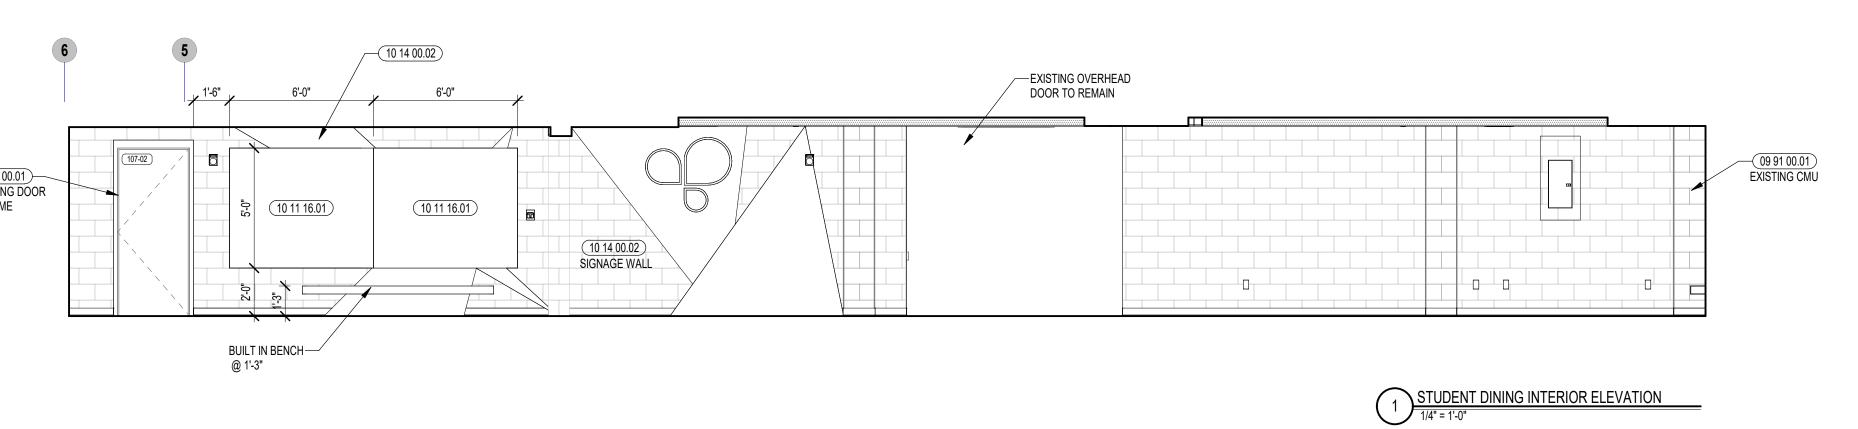



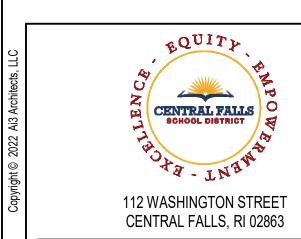



KEYNOTE LEGEND:

12 30 00.03 TALL CABINET

09 29 00.01 5/8 INCH GYPSUM BOARD - LEVEL 4 FINISH - 1 LAYER
09 91 00.01 PAINT - SEE SCHEDULE
10 11 16.01 DRY MARKER BOARD
10 14 00.02 INTERIOR SIGNAGE - VINYL WALL GRAPHIC

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DRAWING NAME:

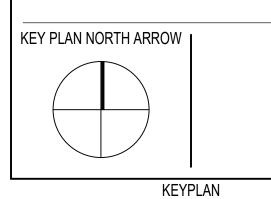STUDENT DINING INTERIOR ELEVATIONS

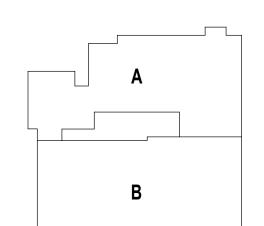
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	REVIEWED	BY:	JQ
	SCALE:	AS INDICATED	DRAWING NUMBER:
	JOB NO.:	2202.04	A10.11 B2
	DATE:	June 22, 2023	/ (10.11 DZ

C. STRUCTURAL STEEL A. GENERAL STRUCTURAL REQUIREMENTS 1. ALL METHODS OF CONSTRUCTION, DETAILS, NOTES, ETC., INDICATED ON THE DRAWINGS ARE TO BE CONSIDERED TYPICAL FOR ALL SIMILAR 1. DESIGN FABRICATION AND ERECTION SHALL BE IN ACCORDANCE WITH AISC SPECIFICATION FOR BUILDINGS. CONDITIONS. 2. NEW STRUCTURAL STEEL SHALL CONFORM TO THE FOLLOWING: 2. CONSTRUCTION SHALL BE MADE FROM APPROVED SHOP DRAWINGS ONLY. ASTM A36 A. TYPICAL PLATES AND ANGLES Fy=36 KSI 3. ANY DISCREPANCIES ON THESE PLANS WITH REGARD TO DIMENSIONS OR CONDITIONS SHALL BE BROUGHT TO THE ATTENTION OF THE ASTM A500, GR.B B. STRUCTURAL TUBING Fy=46 KSI Fy=92 KSI ENGINEER BEFORE PROCEEDING WITH THE AFFECTED PORTION OF WORK. C. DRILL & EPOXY ANCHOR RODS D. HEADED STUDS A108 GR. 50 Fy=50 KSI 4. ALL APPLICABLE FEDERAL, STATE, AND MUNICIPAL REGULATIONS SHALL BE FOLLOWED, INCLUDING THE FEDERAL DEPARTMENT OF LABOR OCCUPATIONAL SAFETY AND HEALTH ACT AND THE RHODE ISLAND STATE BUILDING CODE. 3. ALL NEW STRUCTURAL STEEL SHALL BE GIVEN ONE COAT OF AN APPROVED SHOP PRIMER AND PAINT APPLIED IN ACCORDANCE WITH MANUFACTURER'S RECOMMENDATIONS, UNLESS NOTED OTHERWISE. SHOP PAINTING OF STRUCTURAL STEEL SHALL CONFORM TO SSPC-SP2 5. THE LATEST EDITION OF THE FOLLOWING LISTED CODES SHALL APPLY. IN CASE OF CONFLICT, THE MORE RIGID REQUIREMENTS AND CODES (INTERIOR SURFACES) OR SSPC-SP6 (EXTERIOR SURFACES). SHALL GOVERN. 4. AFTER ERECTION IS COMPLETE, TOUCH-UP ALL SHOP PRIMED COATS DAMAGED DURING TRANSPORT AND ERECTION, AND PRIME ALL FIELD A. RHODE ISLAND STATE BUILDING CODE (STATE CODE): INTERNATIONAL BUILDING CODE, 2018 EDITION AND ITS APPLICABLE REFERENCED WELDS USING THE SAME PAINT USED FOR SHOP PRIMING. 5. ANY STRUCTURAL STEEL TO RECEIVE SPRAY-ON FIREPROOFING SHALL BE FABRICATED WITHOUT ANY PRIMER OR PAINT COATINGS. B. AMERICAN INSTITUTE OF STEEL CONSTRUCTION SPECIFICATIONS AND ITS CODE OF STANDARD PRACTICE (AISC). COORDINATE WITH THE ARCHITECT REGARDING ADDITIONAL INFORMATION RELATED TO FIREPROOFING. C. AMERICAN CONCRETE INSTITUTE BUILDING CODE REQUIREMENTS FOR REINFORCED CONCRETE, ACI 318. 6. FIELD CUTTING OR MODIFICATION OF STRUCTURAL STEEL IS PROHIBITED UNLESS PRIOR WRITTEN APPROVAL IS RECEIVED FROM THE D. AMERICAN CONCRETE INSTITUTE BUILDING CODE REQUIREMENTS FOR CONCRETE MASONRY STRUCTURES, ACI 530 AND ACI 530.1. 7. WELDING: IN ACCORDANCE WITH LATEST EDITION OF AWS D1.1 CODE FOR WELDING IN BUILDING CONSTRUCTION. USE E70 SERIES 6. THE DESIGN LOADS ARE RESISTED BY THE COMPLETED STRUCTURE ACTING AS A UNIT. THE CONTRACTOR SHALL DESIGN AND PROVIDE ANY ELECTRODES UNLESS NOTED OTHERWISE. AND ALL TEMPORARY BRACING, SHORING, OR ADDITIONAL REINFORCEMENT NECESSARY TO RESIST LOADS IMPOSED ON ANY PORTION OF THE STRUCTURE THROUGHOUT ALL STAGES OF CONSTRUCTION. THE SHORING SHALL BE DESIGNED TO RESIST ALL DEAD LOADS AND ANY 8. MINIMUM FILLET WELD (LEG) SIZE SHALL BE 3/16", UNLESS NOTED OTHERWISE. APPLICABLE CONSTRUCTION LOADS. 9. ALL STRUCTURAL STEEL CONNECTIONS NOT SPECIFICALLY DETAILED ON THE PLANS SHALL BE DESIGNED BY THE CONTRACTOR IN ACCORDANCE 7. ALL SHORING DESIGNS AND PLANS SHALL BE STAMPED BY A RHODE ISLAND REGISTERED PROFESSIONAL ENGINEER. WITH THE CURRENT EDITION OF THE AISC "MANUAL OF STEEL CONSTRUCTION - ALLOWABLE STRENGTH DESIGN (ASD)". DESIGN FOR ALL CONNECTIONS SHALL BE STAMPED BY A RHODE ISLAND PROFESSIONAL ENGINEER ENGAGED BY THE CONTRACTOR AND SUBMITTED TO THE 8. NOTES AND TYPICAL DETAILS APPLY TO ALL STRUCTURAL WORK UNLESS OTHERWISE NOTED. FOR CONDITIONS NOT SPECIFICALLY SHOWN ARCHITECT/ENGINEER FOR REVIEW PRIOR TO FABRICATION. CONNECTIONS SHALL BE DESIGNED TO DEVELOP (1/2) OF MEMBER'S TOTAL PROVIDE DETAILS OF SIMILAR NATURE. VERIFY APPLICABILITY BY SUBMITTING SHOP DRAWINGS FOR REVIEW. UNIFORM LOAD CAPACITY, TYPICAL UNLESS NOTED OTHERWISE. 9. PLANS SHALL NOT BE SCALED FOR DIMENSIONS. 10. ARCHITECTURAL AND MEP DRAWINGS MUST BE USED IN CONJUNCTION WITH THE STRUCTURAL DRAWINGS DURING ALL PHASES OF CONSTRUCTION. EXIST. 8" CMU WALL-1'-2" +/- (V.I.F.) **B. MASONRY** 1/4" X 6" HIGH X 2 1/2" WIDE PLATE AT 4'-0" O.C. (MAX). ATTACH TO 1. CONCRETE MASONRY UNITS SHALL BE ASTM C90, TYPE I, NORMAL WEIGHT HOLLOW LOAD BEARING UNITS, UNLESS NOTED OTHERWISE. THE —SOLID-GROUTED CMU WITH 1/2" DIA. DRILL & EPOXY AVERAGE ASTM C1314 PRISM STRENGTH SHALL BE A MINIMUM OF 1,900 PSI. **BOTTOM COURSE** ANCHOR (4.5" EMBED), HILTI HIT-HY 270 OR EQUAL-2. JOINT REINFORCEMENT SHALL BE PREFABRICATED FROM 9-GAUGE DEFORMED WIRE CONFORMING TO ASTM A1064, JOINT REINFORCEMENT —EXIST. BRICK SHALL BE HOT-DIPPED GALVANIZED IN CONFORMANCE WITH ASTM A153. USE EXTRA HEAVY DUTY LADDER TYPE AT 16" O.C. VERTICAL - 3/16" VENEER WALL SIDE RODS AND 9 GA. CROSS RODS. 3. REINFORCING BARS SHALL CONFORM TO ASTM A615, GRADE 60. 4. MORTAR SHALL BE ASTM C270, TYPE M OR S PORTLAND CEMENT MORTAR. DO NOT USE CALCIUM CHLORIDE IN MORTAR OR GROUT. -3/8" X 14" +/- WIDE CONT. STEEL PLATE (VERIFY WALL 5. MASONRY SHALL BE SET ON FULL MORTAR BED. CONT. L3X3X3/8-HSS LINTEL— WIDTH IN FIELD) 6. GROUT FILL FOR MASONRY CELLS, LINTELS, AND BOND BEAMS SHALL CONFORM TO ASTM C476 AND HAVE A MINIMUM 28-DAY COMPRESSIVE BOT. OF LINTEL, SEE NOTE STRENGTH OF 2,500 PSI. 3/16 / 2-12 7. ALL REINFORCING SHALL BE GROUTED SOLID CONTINUOUSLY IN 4" OR WIDER CELLS OR BOND BEAMS. 8. ALL MASONRY WALLS SHALL BE LATERALLY BRACED AGAINST FAILURE OR COLLAPSE UNTIL ANCHORED BY THE STRUCTURE. BEARING PLATE— 9. SPECIAL INSPECTOR SHALL INSPECT ALL GROUTING OPERATIONS AND THE INSTALLATION OF REINFORCING IN LOAD BEARING CONCRETE BOTTOM OF LINTEL ELEVATION WILL BE BASED ON NEEDLE MASONRY WALLS. BEAM DEPTH AND ELEVATION. INTENDED BOTTOM OF 3/4" DIA., 6" LG. HEADED STUD LINTEL IS AT LEAST 7'-4" ABOVE FINISH FLOOR (A.F.F.), WELDED TO PLATE, SET IN 10. REINFORCE WALLS AS SHOWN ON PLANS. SET HIGHER IF POSSIBLE. DO NOT SET LOWER THAN 7'-4" GROUT. CENTER ON CMU WALL-A.F.F. WITHOUT APPROVAL BY THE ARCHITECT. SECTION SCALE: 1" = 1'-0" TYPICAL HSS LINTEL BEARING DETAIL #3 BAR WITH STD. 90-DEG HOOK INTO NEW BLOCK, 10" LG., SPACED 24" O.C. (VERTICALLY). DRILL & GROUT INTO EXISTING CMU WALL WITH HILTI HIT HY 270 OR EQUAL. 4" EMBED., SET IN MORTAR BED (1) "LINTEL BAR"--1'-4" JAMB, GROUT STEEL SHIM PLATES (TYP.) NEW AND EXISTING CENTERED OVER FOUNDATION **BLOCKS SOLID** EXIST. PILE CAP ELEMENT, (LO) BEAMS SHALL (1) "FULL HEIGHT BAR"-NOT LOAD SLAB BETWEEN FOUNDATION ELEMENTS— ackslash EXIST. CMU WALL (BELOW) A DETAIL SCALE: 1" = 1'-0" SUPPORT BEAM (HI)— BEAM (LO) EXIST. PILE CAP (BELOW)-BEAM (LO) EXIST. 2ND -APPROX. LIMITS OF FLOOR FRAMING-MASONRY DEMO SUPPORT BEAM -NEEDLE BEAM (HI) (HI), TYP.-BEAM (LO) -EXIST. PILE CAP (BELOW) BEAM (LO) EXIST. MASONRY WALL--SHORING TOWER SUPPORTED BY LO NEEDLE BEAM (HI) SUPPORT BEAMS BEAMS (TYP.) [AT 4'-0" O.C. MAX BEAM (LO) SHIM DOWN TO FOUNDATION BEAM (LO) ELEMENT BELOW--SHIM DOWN TO FOUNDATION **ELEMENT BELOW**

ELEMENT (TYP.)

<u>SECTION</u>

NOT TO SCALE

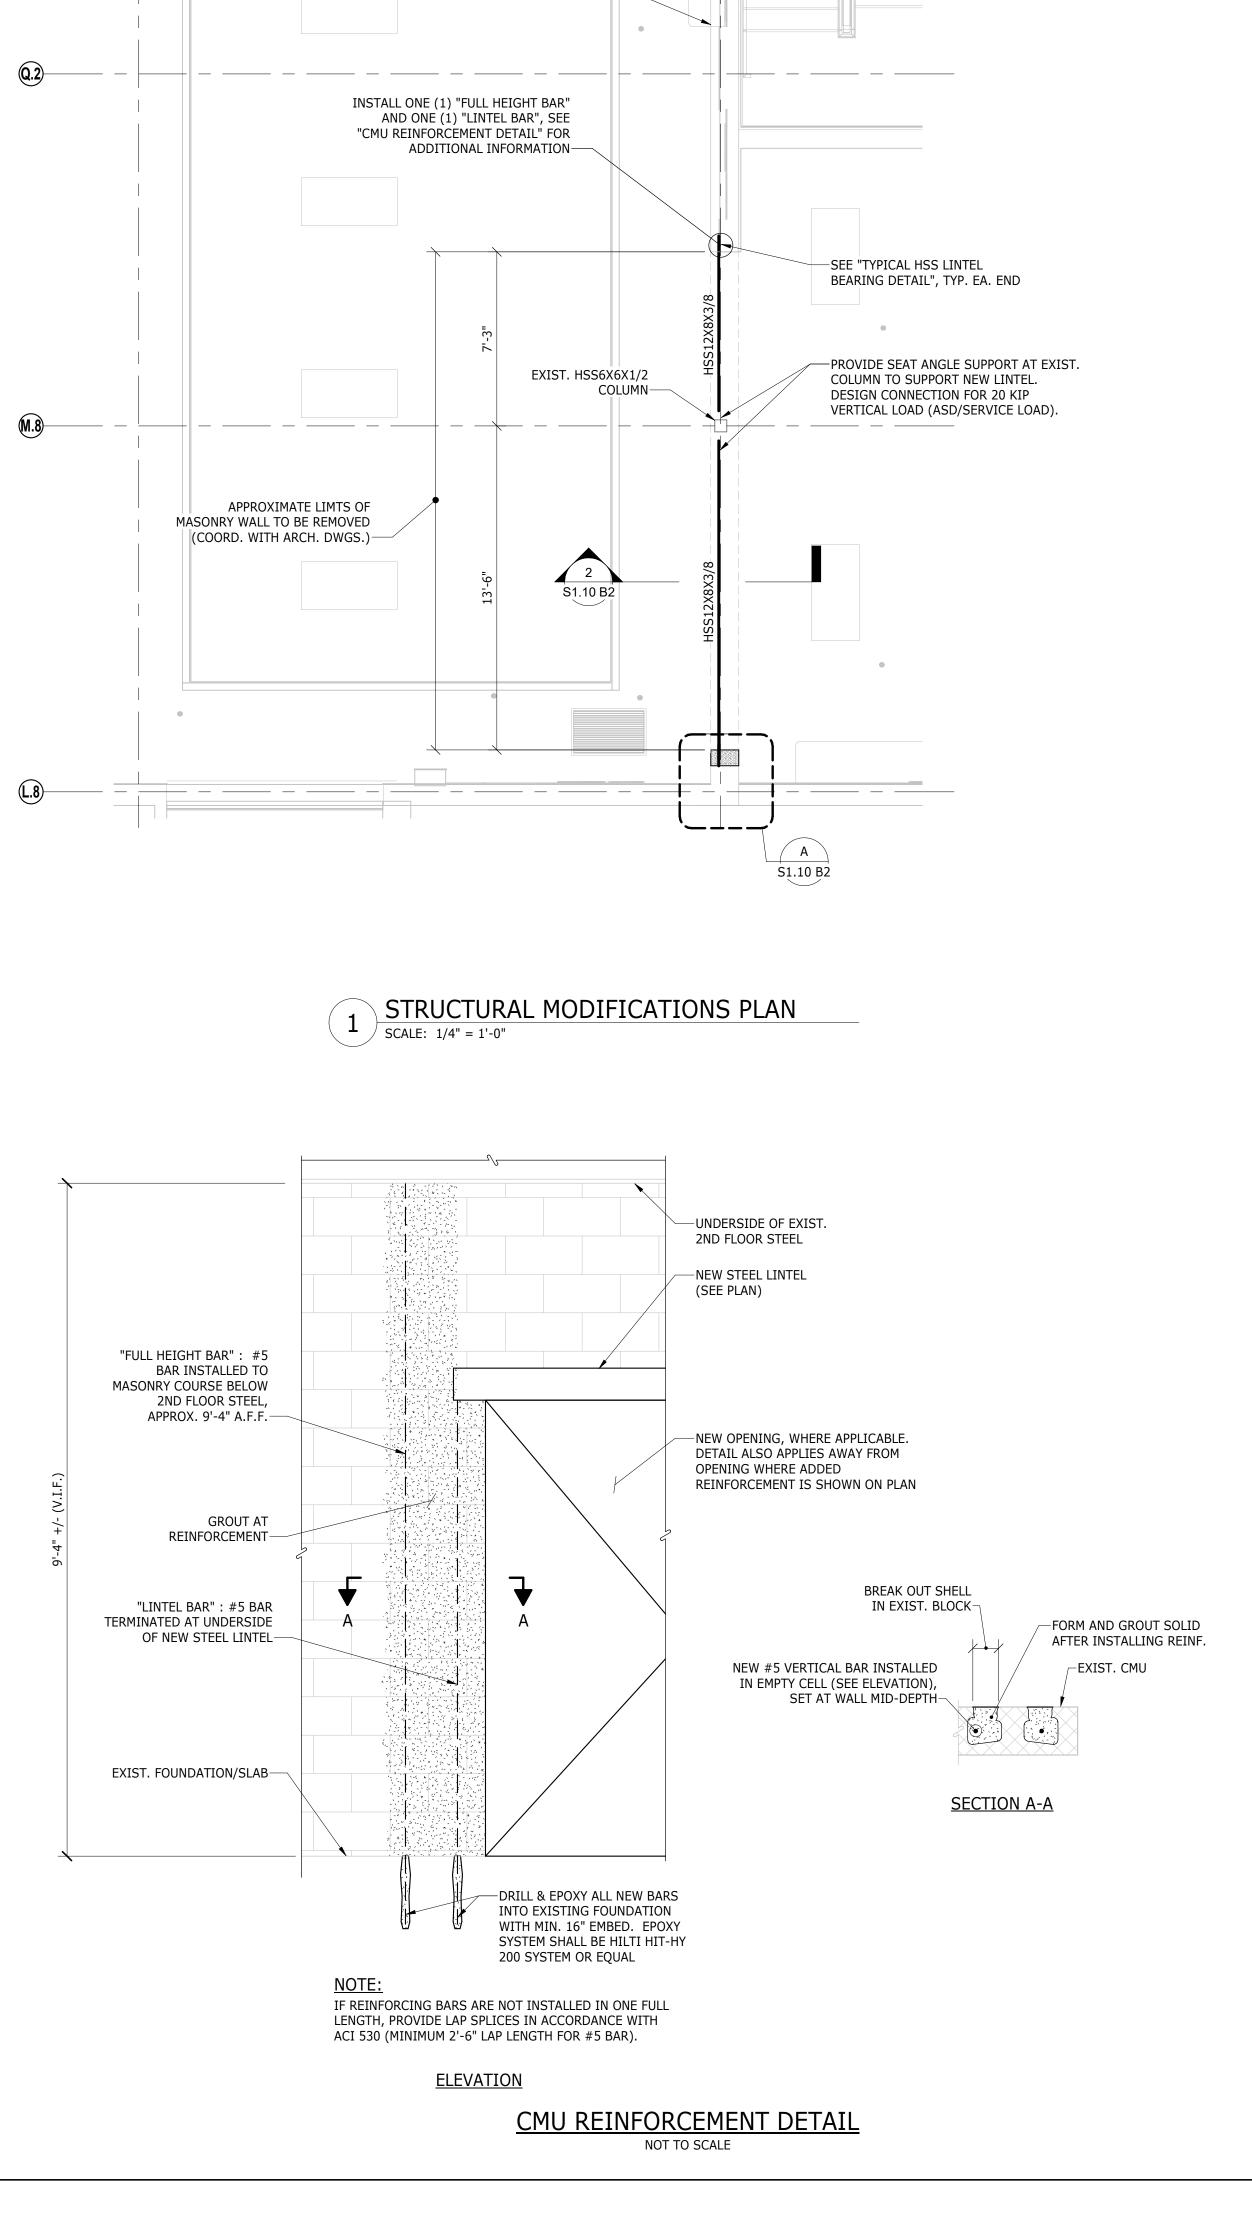

INSTALL ONE (1) "FULL HEIGHT BAR",

EXIST. CMU WALL-

SEE "CMU REINFORCEMENT DETAIL"

FOR ADDITIONAL INFORMATION—





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DRAWING NAME:

CMU WALL OPENING PLAN AND DETAILS

DRAWN BY: JDB

REVIEWED BY: KMC

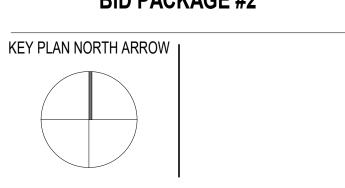SCALE: AS INDICATED DRAWING NUMBER:

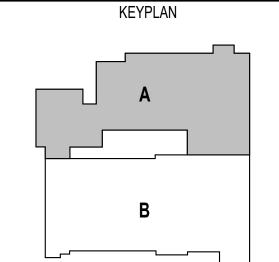JOB NO.: 2202.00
DATE: June 22, 2023 S1.10 B2

6 CONCEPTUAL SHORING LAYOUT

SCALE: 1/4" = 1'-0"

POCKET INTO MASONRY WALL—

1. EXISTING FOUNDATION ELEMENTS SHOWN ARE BASED UP ON RECORD DRAWINGS PROVIDED BY THE OWNER (SEE "STRUCTURAL

FOUNDATION PLAN" DATED 3/18/98 BY ODEH ENGINEERS, INC.). CONTRACTOR SHALL UTILIZE GPR OR SIMILAR METHOD TO LOCATE EXISTING FOUNDATION ELEMENTS PRIOR TO INSTALLING SHORING. SHORING SHALL BE SUPPORTED BY FOUNDATION

2. SHORING LAYOUT IS CONCEPTUAL ONLY. CONTRACTOR TO SUBMIT A FINAL DESIGN STAMPED BY A PROFESSIONAL ENGINEER REGISTERED IN RHODE ISLAND TO MEET DESIGN INTENT. SHORING SHALL REMAIN IN PLACE UNTIL NEW LINTEL INSTALLATION

AND MASONRY RECONSTRUCTION IS COMPLETE. PATCH ALL TEMPORARY OPENINGS MADE IN CMU WALL TO INSTALL SHORING.

SHORING TOWER

<u>PLAN</u>

ELEMENTS AND SHALL NOT LOAD THE SLAB BETWEEN THESE ELEMENTS.

NOTES:

	GENERAL		DEVICES		ABE	REVIATIONS	
	EXISTING PIPING TO BE REMOVED	Ø	DELUGE ALARM VALVE ASSEMBLY	AFF	ABOVE FINISH FLOOR	GWB	GYPSUM WALL BOARD
	HEAVY LINE INDICATES NEW WORK		DDV ALADMANALVE AGGENDLY	AFG	ABOVE FINISH GRADE	HMR	HYDRAULICALLY MOST REMOTE
	LIGHT LINE INDICATES EXISTING WORK		DRY ALARM VALVE ASSEMBLY	AP	ACCESS PANEL	INV	INVERT
	PIPING INTERRUPTED OR TO BE CONTINUED		PREACTION ALARM VALVE ASSEMBLY	AC AC	ABOVE CEILING	JP	JOCKEY PUMP
	CAP OR END OF PIPE		WET ALARM VALVE ASSEMBLY	ARCH	ARCHITECT	KW	KILOWATTS
⊕ CTE	CONNECT TO EXISTING			BLDG	BUILDING	MAX	MAXIMUM
_		#	KEYNOTE TAG	BOP	BOTTOM OF PIPE		MECHANICAL
IIL # 1 IG # P7.1	DETAIL DESIGNATION TAG	#>	HYDRAULIC REFERENCE NODE	BOR	BOTTOM OF RISER	MECH MIN	MINIMUM
			SIGNALING DEVICES	Cl	CAST IRON		
DN	ELBOW DOWN OR DROP		OIGITA EIITO DE TIGEO	CLNG	CEILING	MISC N/A	MISCELLANEOUS NOT APPLICABLE
———	ELBOW UP OR RISE	FM	FLOWMETER		CEILING CEMENT LINED DUCTILE IRON	NC NC	NORMALLY CLOSED
	FLOW IN DIRECTION OF ARROW	T FS	FLOW METER	CLDI		NO	NORMALLY OPEN
////	HEAT TRACE	P	FS FLOW SWITCH	CP	CHROME PLATED	NTS	NOT TO SCALE
	TEE LOOKING DOWN	Ø	PRESSURE GAUGE	CNR	CONCENTRIC REDUCER		
	TEE LOOKING UP	TS		CONT	CONTINUATION	NIC	NOT IN CONTRACT
	WATER TIGHT SLEEVE	₽	TS TAMPER SWITCH	DIA	DIAMETER	PA	PRE-ACTION
				DWG	DRAWING	PIV	POST INDICATING VALVE
	SYSTEMS		SPRINKLERS	EA	EACH	POS	PROVIDED UNER OTHER SECTION
				ECC	ECCENTRIC REDUCER	SCH	SCHEDULE
= F ===	BURIED FIRE SERVICE	•	CONCEALED SPRINKLER HEAD	EL OR ELEV.	ELEVATION	SC	SITE CONTACTOR
— F ——	FIRE SERVICE, MAIN DISTRIBUTION AND/OR	• _D	CONCEALED SPRINKLER (DRY SYSTEM)	ELEC	ELECTRIC	SPEC	SPECIFICATION
	STANDPIPE FEED	Φ _F	EXISTING SPRINKLER TO REMAIN	EMER	EMERGENCY	ST. ST.	STAINLESS STEEL
F(DRY)	DRY DISTRIBUTION AND/OR STANDPIPE FEED	8	EXISTING SPRINKLER TO BE REMOVED	ETBR	EXISTING TO BE REMOVED	STD	STANDARD
— FDC ———	FIRE DEPARTMENT INLET CONNECTION	•	EXTENDED COVERAGE SIDEWALL SPRINKLER	ETR	EXISTING TO REMAIN	STL	STEEL
— SPR ———	WET SPRINKLER		INSTITUTIONAL SIDEWALL SPRINKLER	FFE	FINISH FLOOR ELEVATION	TH	TEST HEADER
SPR(PA)	PREACTION SPRINKLER	~	INSTITUTIONAL SPRINKLER HEAD	FLR	FLOOR	TOR	TOP OF RISER
SPR(DRY)	DRY SPRINKLER	*	PENDENT SPRINKLER	FT	FOOT	TOS	TOP OF STAIRS
— SPD ———— SPD	SPRINKLER DRAIN	⊕ _D	PENDENT SPRINKLER (DRY SYSTEM)	FURN	FURNISHED	TYP	TYPICAL
— тн — — — т н	(FIRE PUMP) TEST HEADER	(e)	PENDENT SPRINKLER W/CAGE	GALV	GALVANIZED	UNO	UNLESS NOTED OTHERWISE
		•	SEMI-RECESSED SPRINKLER	GC	GENERAL CONTRACTOR	VIV	VALVE IN VERTICAL
	VALVES		SIDEWALL SPRINKLER	GPH	GALLONS PER HOUR	W/	WITH
			UPRIGHT SPRINKLER	GPM	GALLONS PER MINUTE	W/O	WITHOUT
T BV	BALL VALVE	• _D	UPRIGHT SPRINKLER (DRY SYSTEM)				
CV	CHECK VALVE	(a)	UPRIGHT SPRINKLER W/CAGE				
DCVA	DOUBLE CHECK VALVE ASSEMBLY	9	WINDOW WASH SPRINKLER				
────── GV	GATE VALVE	~	WINDOW WASH SPRINKLER				
├ ── FDC	FIRE DEPARTMENT CONNECTION SIEMESE						
I— FDC	FIRE DEPARTMENT CONNECTION STORZ						
─── FVC	FIRE DEPARTMENT VALVE						
FHC	FIRE HOSE CABINET						
FCV	FLOOR CONTROL VALVE ASSEMBLY						
	SUPERVISED OUTSIDE SCREW & YOLK VALVE						
	STRAINER						
○→ VIV	VALVE IN VERTICAL						
						1	

TYPICAL NOTES (APPLICABLE TO ALL DRAWINGS)

- I. ALL SPRINKLER HEADS IN 2'x4' CEILING TILES TO BE ON CENTERLINE OF 2'-O" DIMENSION AND TO BE AT 1'-O" OFF EITHER END OR IN THE EXACT CENTER OF THE 4'-O"
- DIMENSION.
 2. ALL SPRINKLER HEADS IN 2'x2' CEILING TILES TO BE
- CENTERED IN THE EXACT CENTER OF THE TILE.

 3. ALL PIPING SHALL RUN HIGH THRU THE STRUCTURE WITH OFFSETS UP OR DOWN, AS REQUIRED


MINIMUM DESIGN CRITERIA

I. ALL CLASSROOMS, HALLWAYS, OFFICES, GYMNASIUM, ETC.
SHALL BE PROTECTED WITH A LIGHT HAZARD, WET SYSTEM
EMPLOYING PENDANT HEADS DESIGNED TO DELIVER A
MINIMUM DENSITY OF O. I O GPM/SF. OVER THE MOST
HYDRAULICALLY REMOTE I,500 SQ. FT.




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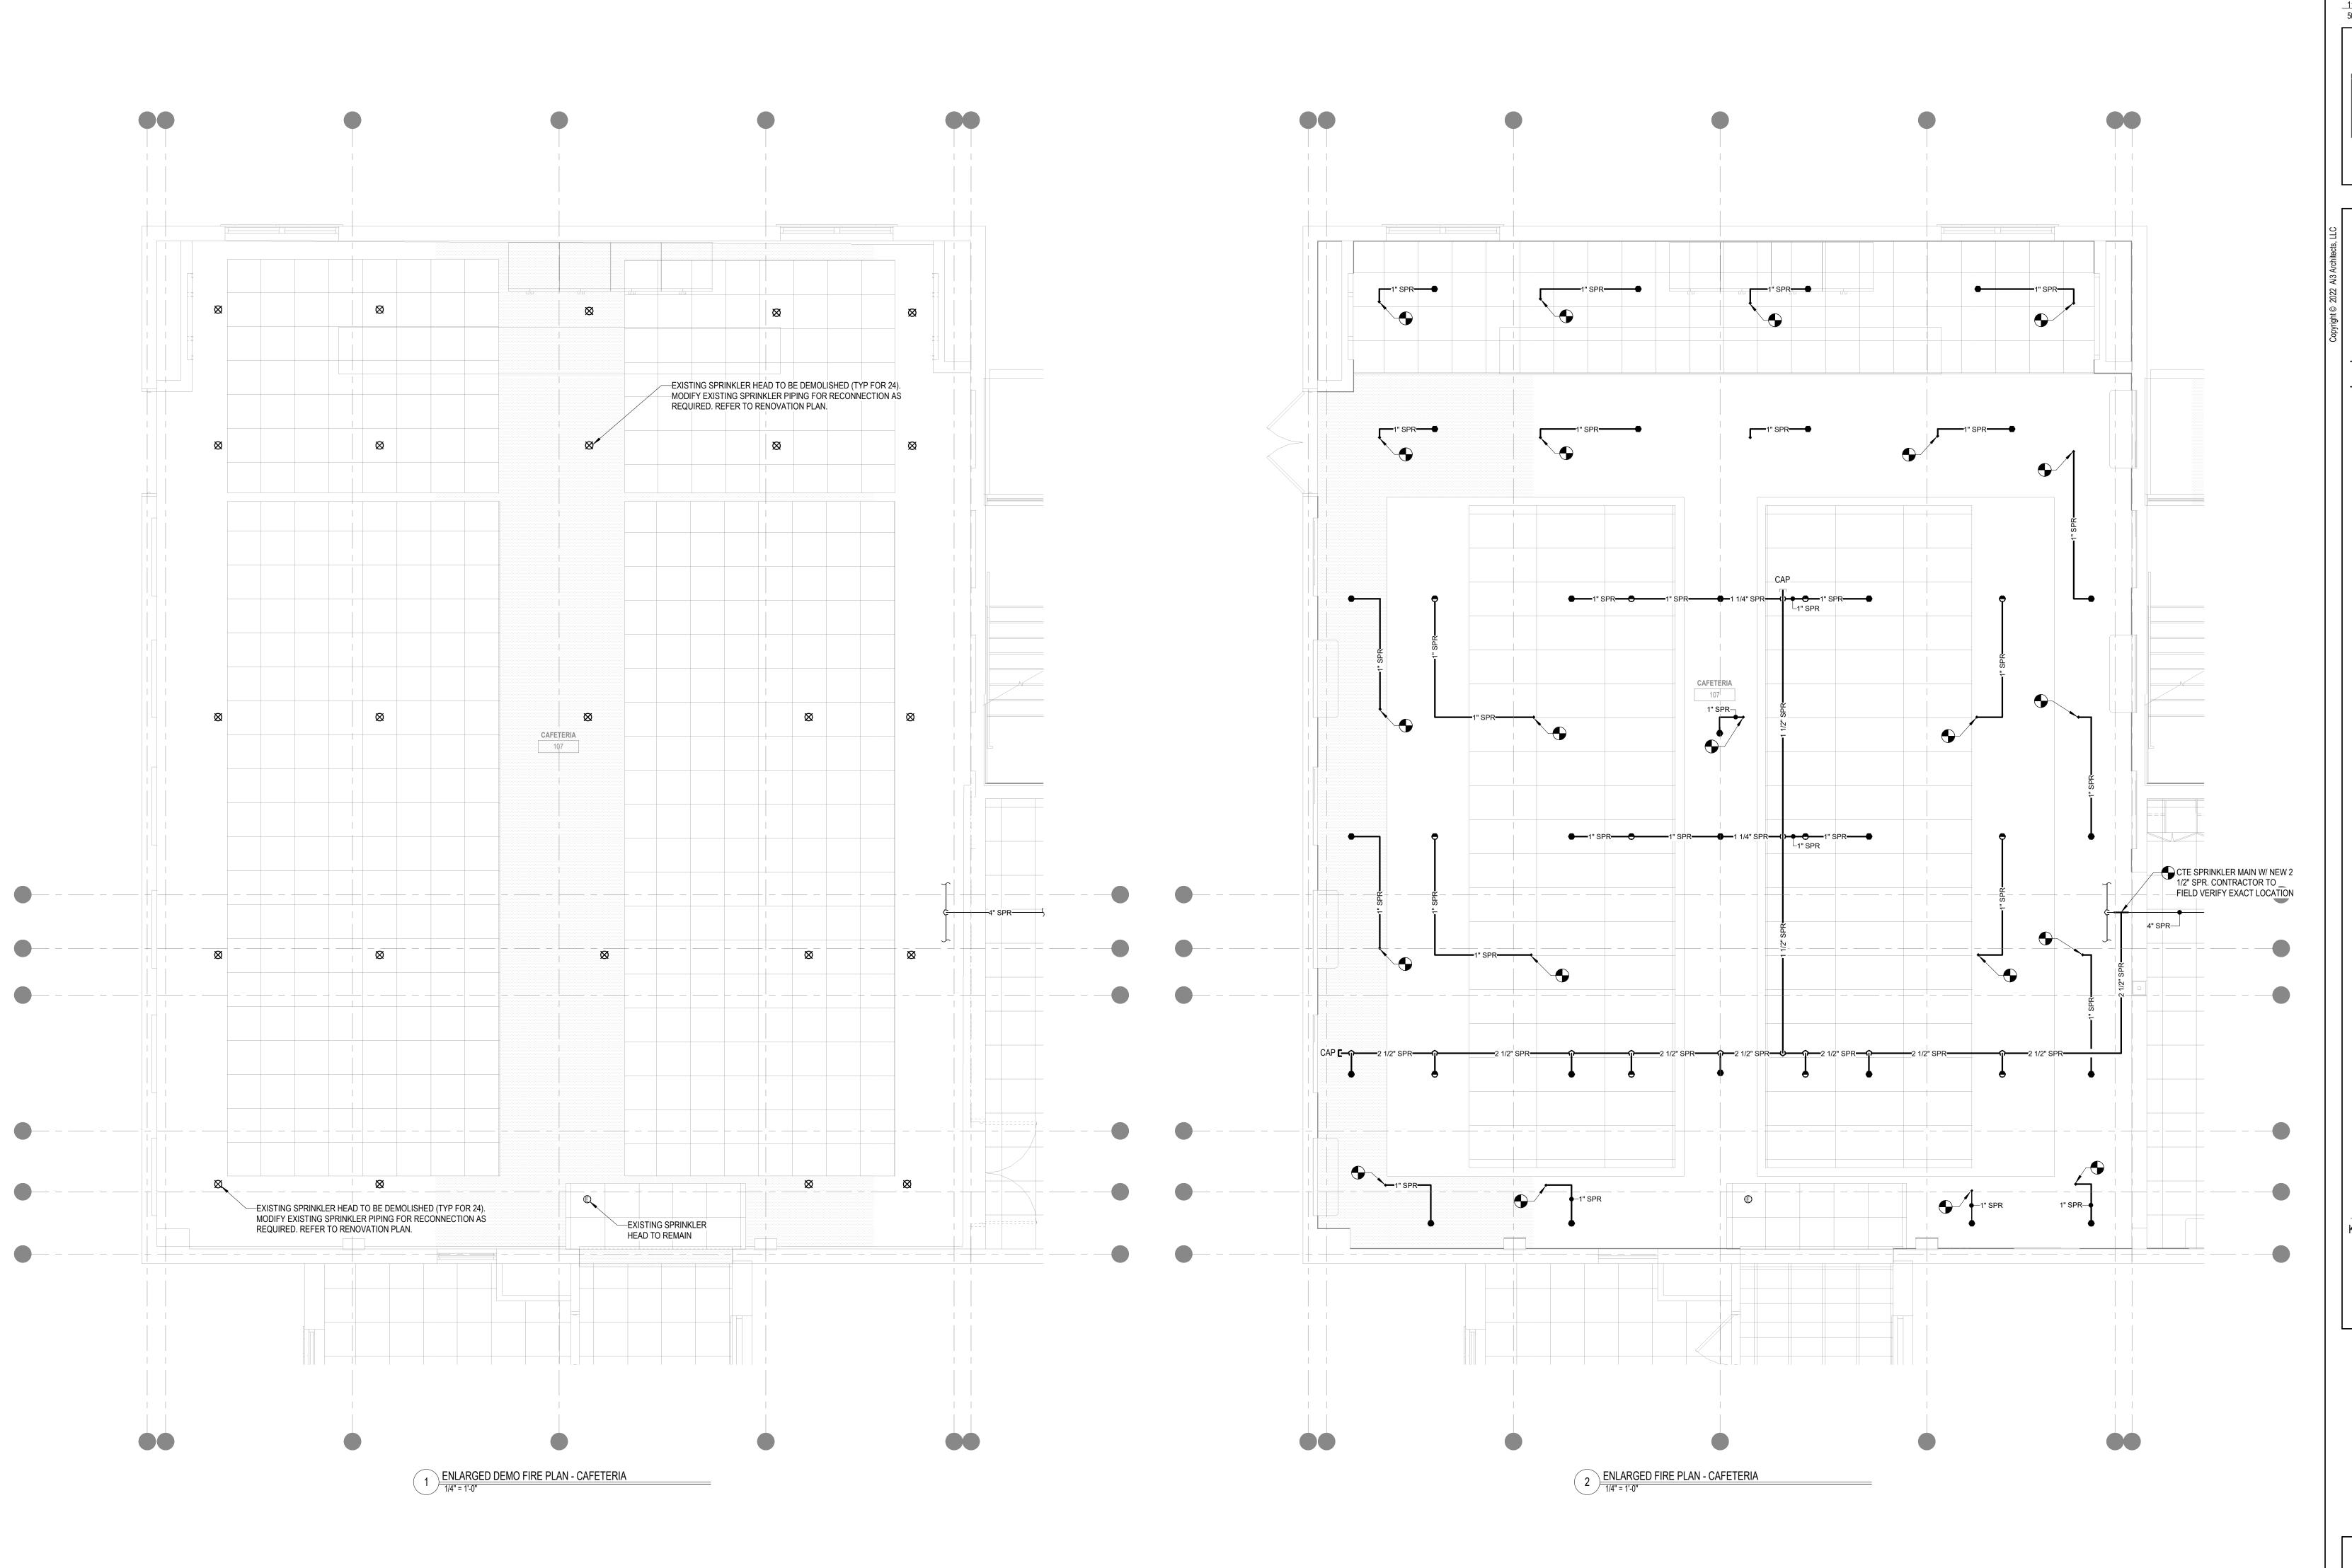


A B

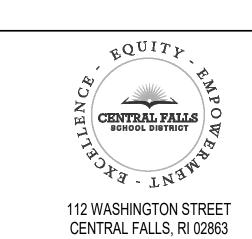DRAWING NAME:

FIRE PROTECTION LEGEND & GENERAL NOTES

	DRAWN BY:		SPD
	REVIEWED	BY:	AMD
	SCALE:	AS NOTED	DRAWING NUMBER:
	JOB NO.: DATE:	2202.04 June 22, 2023	FP0.01 B2
	DITTE.	00110 ZZ, Z0Z0	

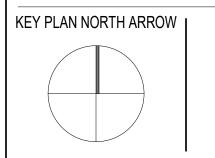






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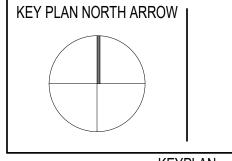
Consulting Engineers


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KEYNOTE LEGEND:

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DRAWING NAME:

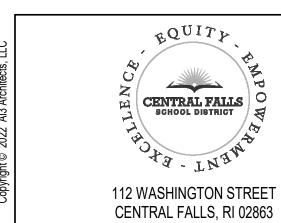FIRE PROTECTION ENLARGED CAFETERIA PLANS

	DRAWN BY:		SPD
	REVIEWED	BY:	AMD
	SCALE:	AS NOTED	DRAWING NUMBER:
	JOB NO.:	2202.04	FP3.01 B2
	DATE:	June 22, 2023	110.0102

ABBREVIATIONS

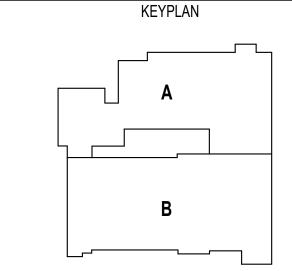MAXIMUM CFM CUBIC FEET PER MINUTE MINIMUM EXHAUST AIR DEVICE PLUMBING CONTRACTOR ELECTRICAL CONTRACTOR RETURN AIR DEVICE EXHAUST FAN SUPPLY AIR DEVICE GENERAL CONTRACTOR HEATING, VENTILATING & AIR

GENERAL MECHANICAL NOTES APPLICABLE TO ALL DRAWINGS

THE HVAC SUBCONTRACTOR SHALL REFER TO THE ARCHITECTURAL DRAWINGS FOR THE CEILING HEIGHTS WHICH SHALL BE MAINTAINED.

CONDITIONING CONTRACTOR

- 2. THE HVAC SUBCONTRACTOR SHALL INVESTIGATE AVAILABLE SPACE FOR ALL EQUIPMENT IN CEILINGS BEFORE SUBMISSION OF SHOP DRAWINGS.
- 3. HVAC SUBCONTRACTOR SHALL COORDINATE ALL DIFFUSER, REGISTER AND GRILLE LOCATIONS WITH REFLECTED CEILING PLANS, AND ANY RELOCATIONS DUE TO FIELD CONDITIONS SHALL BE APPROVED BY THE ARCHITECT AND/OR ENGINEER.
- 4. DUCT SIZES INDICATED ON THE DRAWINGS ARE TO BE NET FREE AREA. ALL DUCTWORK SHALL BE CONSTRUCTED, INSTALLED AND SEALED (CLASS A), PER THE LATEST SMACNA REQUIREMENTS.
- 5. ALL SQUARE ELBOWS AND BULLHEAD TEES SHALL HAVE TURNING VANES.
- 6. THE DUCTWORK SYSTEMS SHOWN ON THE DRAWINGS ARE SHOWN DIAGRAMMATICALLY WITHOUT EVERY OFFSET AND TRANSITION REQUIRED TO INSTALL THE WORK. OBVIOUS OFFSETS AND TRANSITIONS, AS RELATED TO HVAC, ARE SHOWN WHERE POSSIBLE WITHOUT AFFECTING THE CLARITY OF THE DRAWINGS.
- 7. ALL DUCTWORK SHALL BE RUN ABOVE THE CEILINGS UNLESS NOTED OTHERWISE.
- 8. ALL MATERIALS INSTALLED IN THIS WORK SHALL BE NEW UNLESS SPECIFICALLY NOTED FOR RE-USE
- 9. ALL WORK PERFORMED SHALL BE GUARANTEED FREE FROM DEFECTS IN WORKMANSHIP AND MATERIALS FOR A PERIOD OF ONE (1) YEAR FROM DATE OF FINAL ACCEPTANCE BY THE OWNER, UNLESS SUCH DEFECTS ARE CLEARLY THE RESULT OF MISUSE OF EQUIPMENT BY PERSONS NOT UNDER THE CONTROL OF THE SUBCONTRACTOR.

- 10. ALL EQUIPMENT TO BE INSTALLED EXPOSED IN FINISHED AREAS (REGISTERS, GRILLES, DIFFUSERS, ETC.) SHALL BE LOCATED AS INDICATED ON THE ARCHITECTURAL DRAWINGS. FINAL LOCATIONS SHALL BE AS SELECTED BY THE ARCHITECT UNLESS OTHERWISE NOTED.
- 11. ALL EQUIPMENT TO BE INSTALLED EXPOSED IN FINISHED AREAS (REGISTERS, GRILLES, DIFFUSERS, ETC.) SHALL HAVE COLORS SELECTED BY THE ARCHITECT UNLESS OTHERWISE NOTED.
- 12. ALL HVAC EQUIPMENT SHALL BE INSTALLED, COORDINATED WITH ALL TRADES, IN SUCH A WAY SO THAT LIGHTS, CONDUITS, SPRINKLERS, SUPPLY AND/OR DRAIN PIPING DO NOT BLOCK ACCESS TO
- 13. THE HVAC CONTRACTOR SHALL BE RESPONSIBLE FOR ALL RIGGING AND

UNITS AND RELATED ACCESSORIES.

- STAGING REQUIRED FOR THE INSTALLATION OF THE HVAC SYSTEMS. 14. UNDERCUT DOORS AND DOOR LOUVERS ARE BY THE GENERAL CONTRACTOR.
- 15. HVAC CONTRACTOR SHALL BE RESPONSIBLE FOR ALL SHEETMETAL TRANSITIONS AT AIR TERMINAL UNITS, FANS, COILS AND OTHER SIMILAR HVAC EQUIPMENT.

SHEETMETAL

SUPPLY DIFFUSER OR GRILLE


GENERAL

EQUIPMENT DESIGNATION

RETURN/EXHAUST REGISTER OR GRILLE

DIFFUSER, REGISTER & GRILLE SCHEDULE								
ITEM	MFG'R ①	MODEL	SIZE	NECK	CFM MAX.	THROW	BORDER TYPE	REMARKS
S-1	NAILOR	6500	_	9x9	280	SEE PLANS	S, L	
R-1	NAILOR	61554-0	30"x30"	1	850	N/A	S	MATCH EXISTING SIZE, FIELD VERIFY
R-2	NAILOR	61554-0	36"x24"	_	850	N/A	S	MATCH EXISTING SIZE, FIELD VERIFY
E-1	NAILOR	61554-0	40"x40"	_	_	N/A	S	MATCH EXISTING SIZE, FIELD VERIFY

1) ACCEPTABLE ALT. MANUFACTURERS: METAL-AIRE, PRICE, NAILOR OR APPROVED EQUAL.

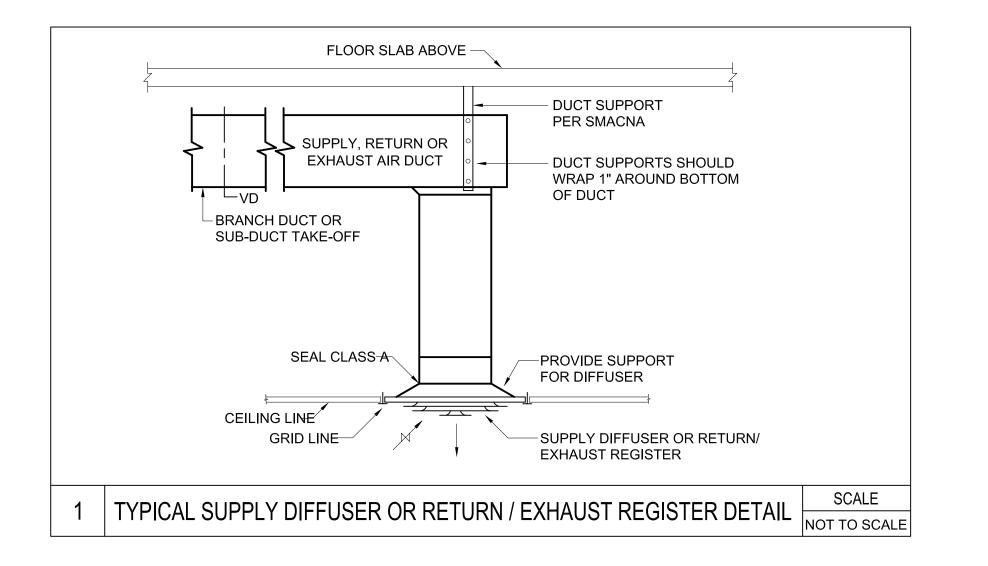



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KEYNOTE LEGEND:


100% CONSTRUCTION DOCUMENTS BID PACKAGE #2 KEY PLAN NORTH ARROW

KEYPLAN

DRAWING NAME:

MECHANICAL LEGEND, SCHEDULES & **DETAILS**

REVIEWED BY:

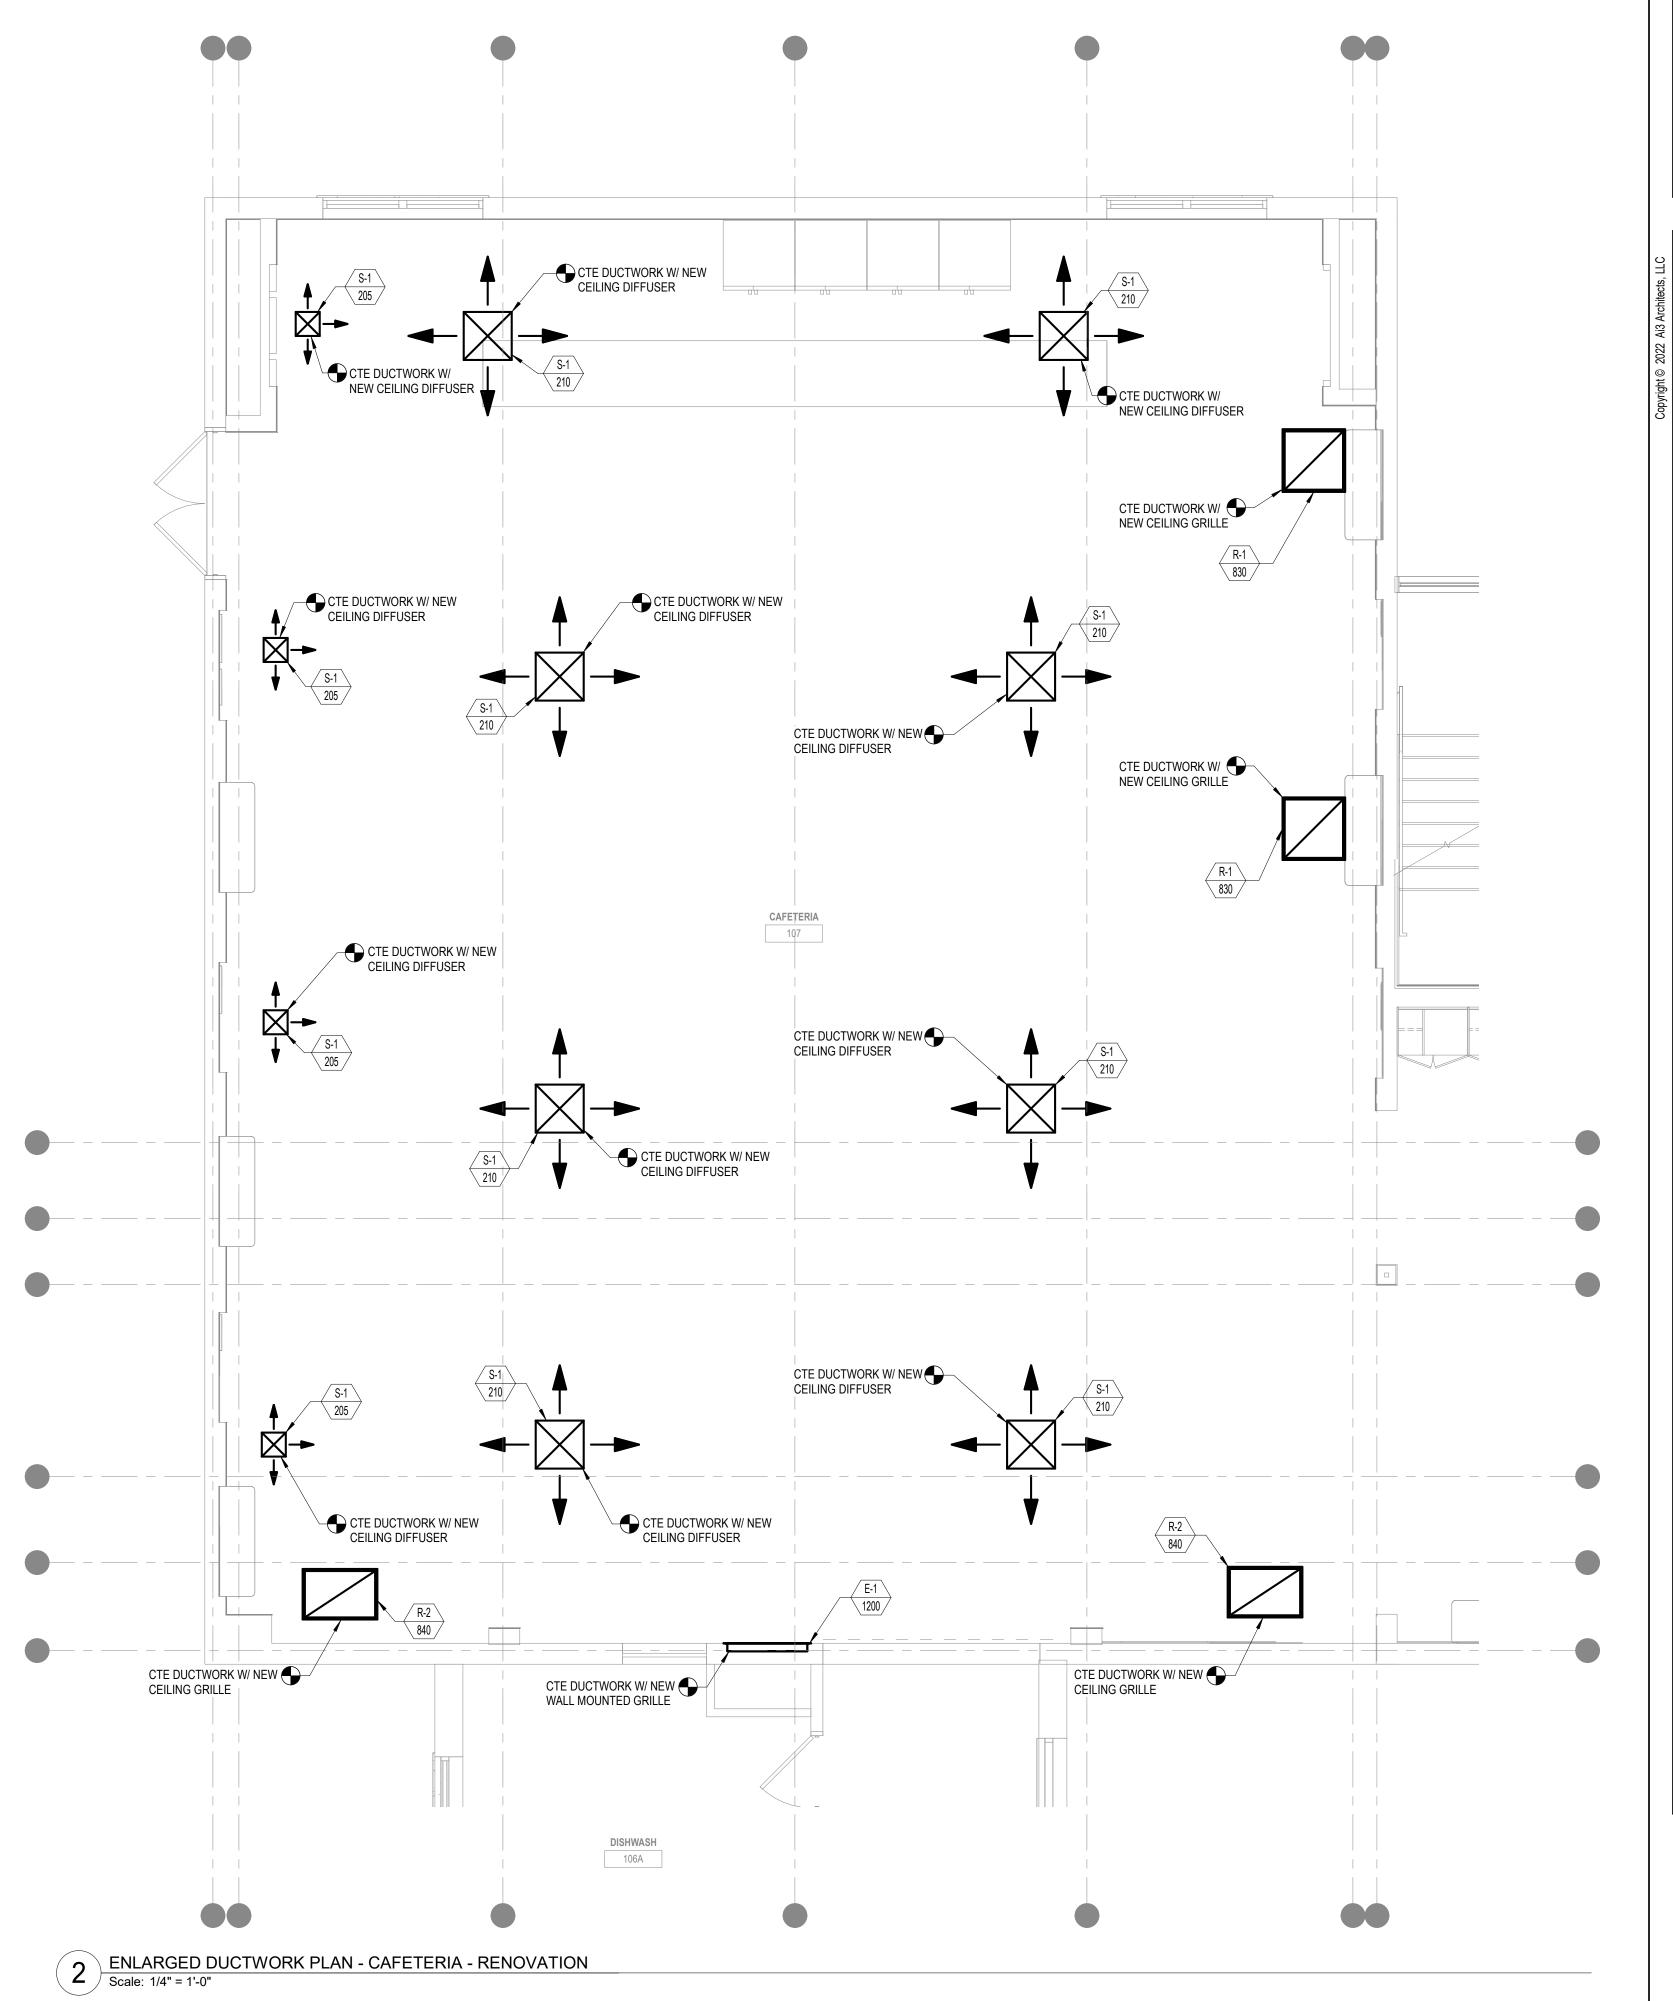

1 ENLARGED DUCTWORK PLAN - CAFETERIA - DEMOLITION
Scale: 1/4" = 1'-0"

EXISTING CEILING GRILLE TO BE DISCONNECTED & REMOVED. SEAL EXISTING DUCTWORK AIR TIGHT DURING DEMOLITION STAGE. MODIFY EXISTING DUCTWORK FOR RECONNECTION AS REQUIRED. REFER TO RENOVATION PLANS. (TYP. FOR 16)

EXISTING WALL MOUNTED GRILLE TO BE DISCONNECTED & REMOVED. SEAL EXISTING DUCTWORK AIR TIGHT DURING DEMOLITION

STAGE. MODIFY EXISTING DUCTWORK FOR RECONNECTION AS REQUIRED. REFER TO RENOVATION PLANS.

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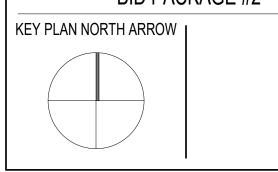


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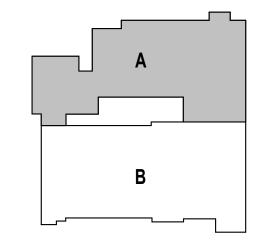


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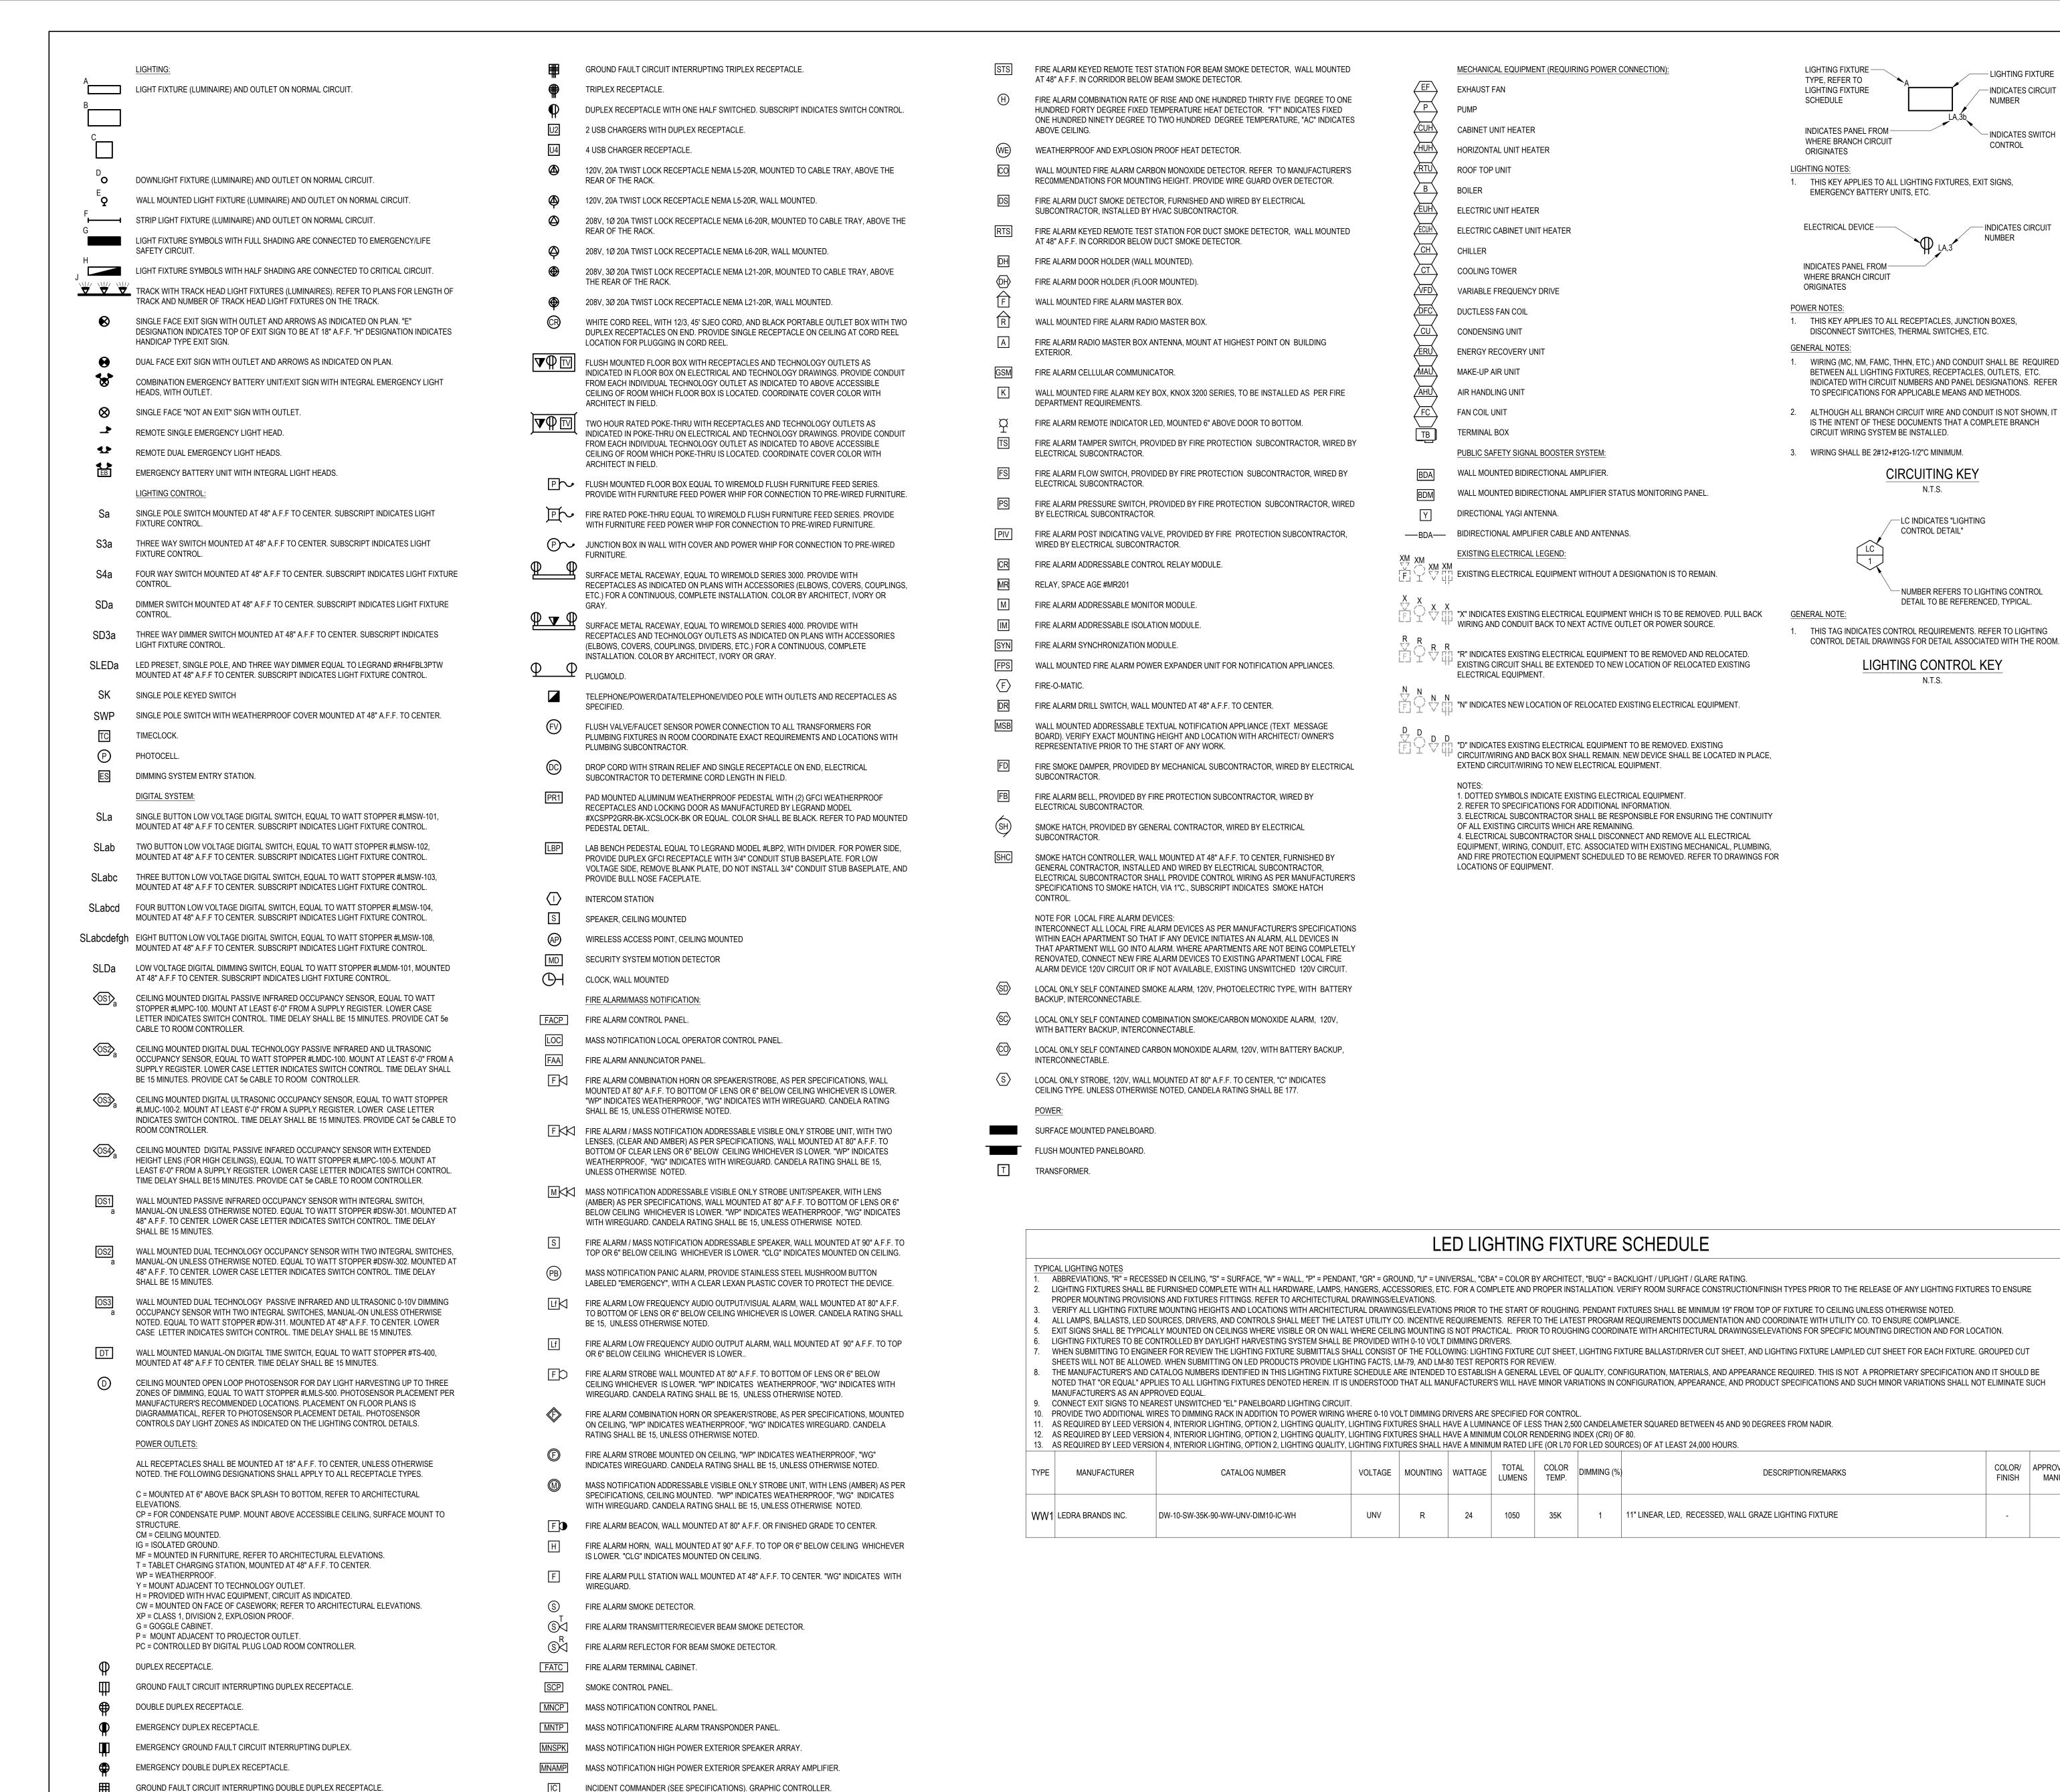
KEYPLAN



DRAWING NAME:

MECHANICAL **ENLARGED CAFETERIA PLANS**

DRAWN BY:		SPD
REVIEWED	BY:	DAH
SCALE:	AS NOTED	DRAWING NUMBER:
JOB NO.: DATE:	2202.04 June 22, 2023	M3.01 B2



SPECIAL PURPOSE RECEPTACLE. RECEPTACLE TO MATCH EQUIPMENT REQUIREMENTS.

RATING AS INDICATED BY CIRCUIT BREAKER SIZE.

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- LIGHTING FIXTURE

- INDICATES CIRCUIT

- INDICATES SWITCH

COLOR/ APPROVED ALTERNATE

FINISH MANUACTURER'S

NUMBER

112 WASHINGTON STREE

www.griffithandvary.com

CENTRAL FALLS, RI 02863 **KEYNOTE LEGEND:**

KEYPLAN

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KEY PLAN NORTH ARROW

DRAWING NAME:

DATE:


ELECTRICAL LEGEND & LIGHTING FIXTURE SCHEDULE

DRAWN BY: REVIEWED BY: SCALE: NOT TO SCALE | DRAWING NUMBER:

E0.01 B2 June 22, 2023

KEYED NOTES


1 ELECTRICAL SUB-CONTRACTOR SHALL CONNECT NEW WALL GRAZE LIGHTING FIXTURE TO EXISTING BRANCH LIGHTING CIRCUIT ALREADY SERVING THE CAFETERIA VIA NEW KEYED LIGHTING SWITCH.

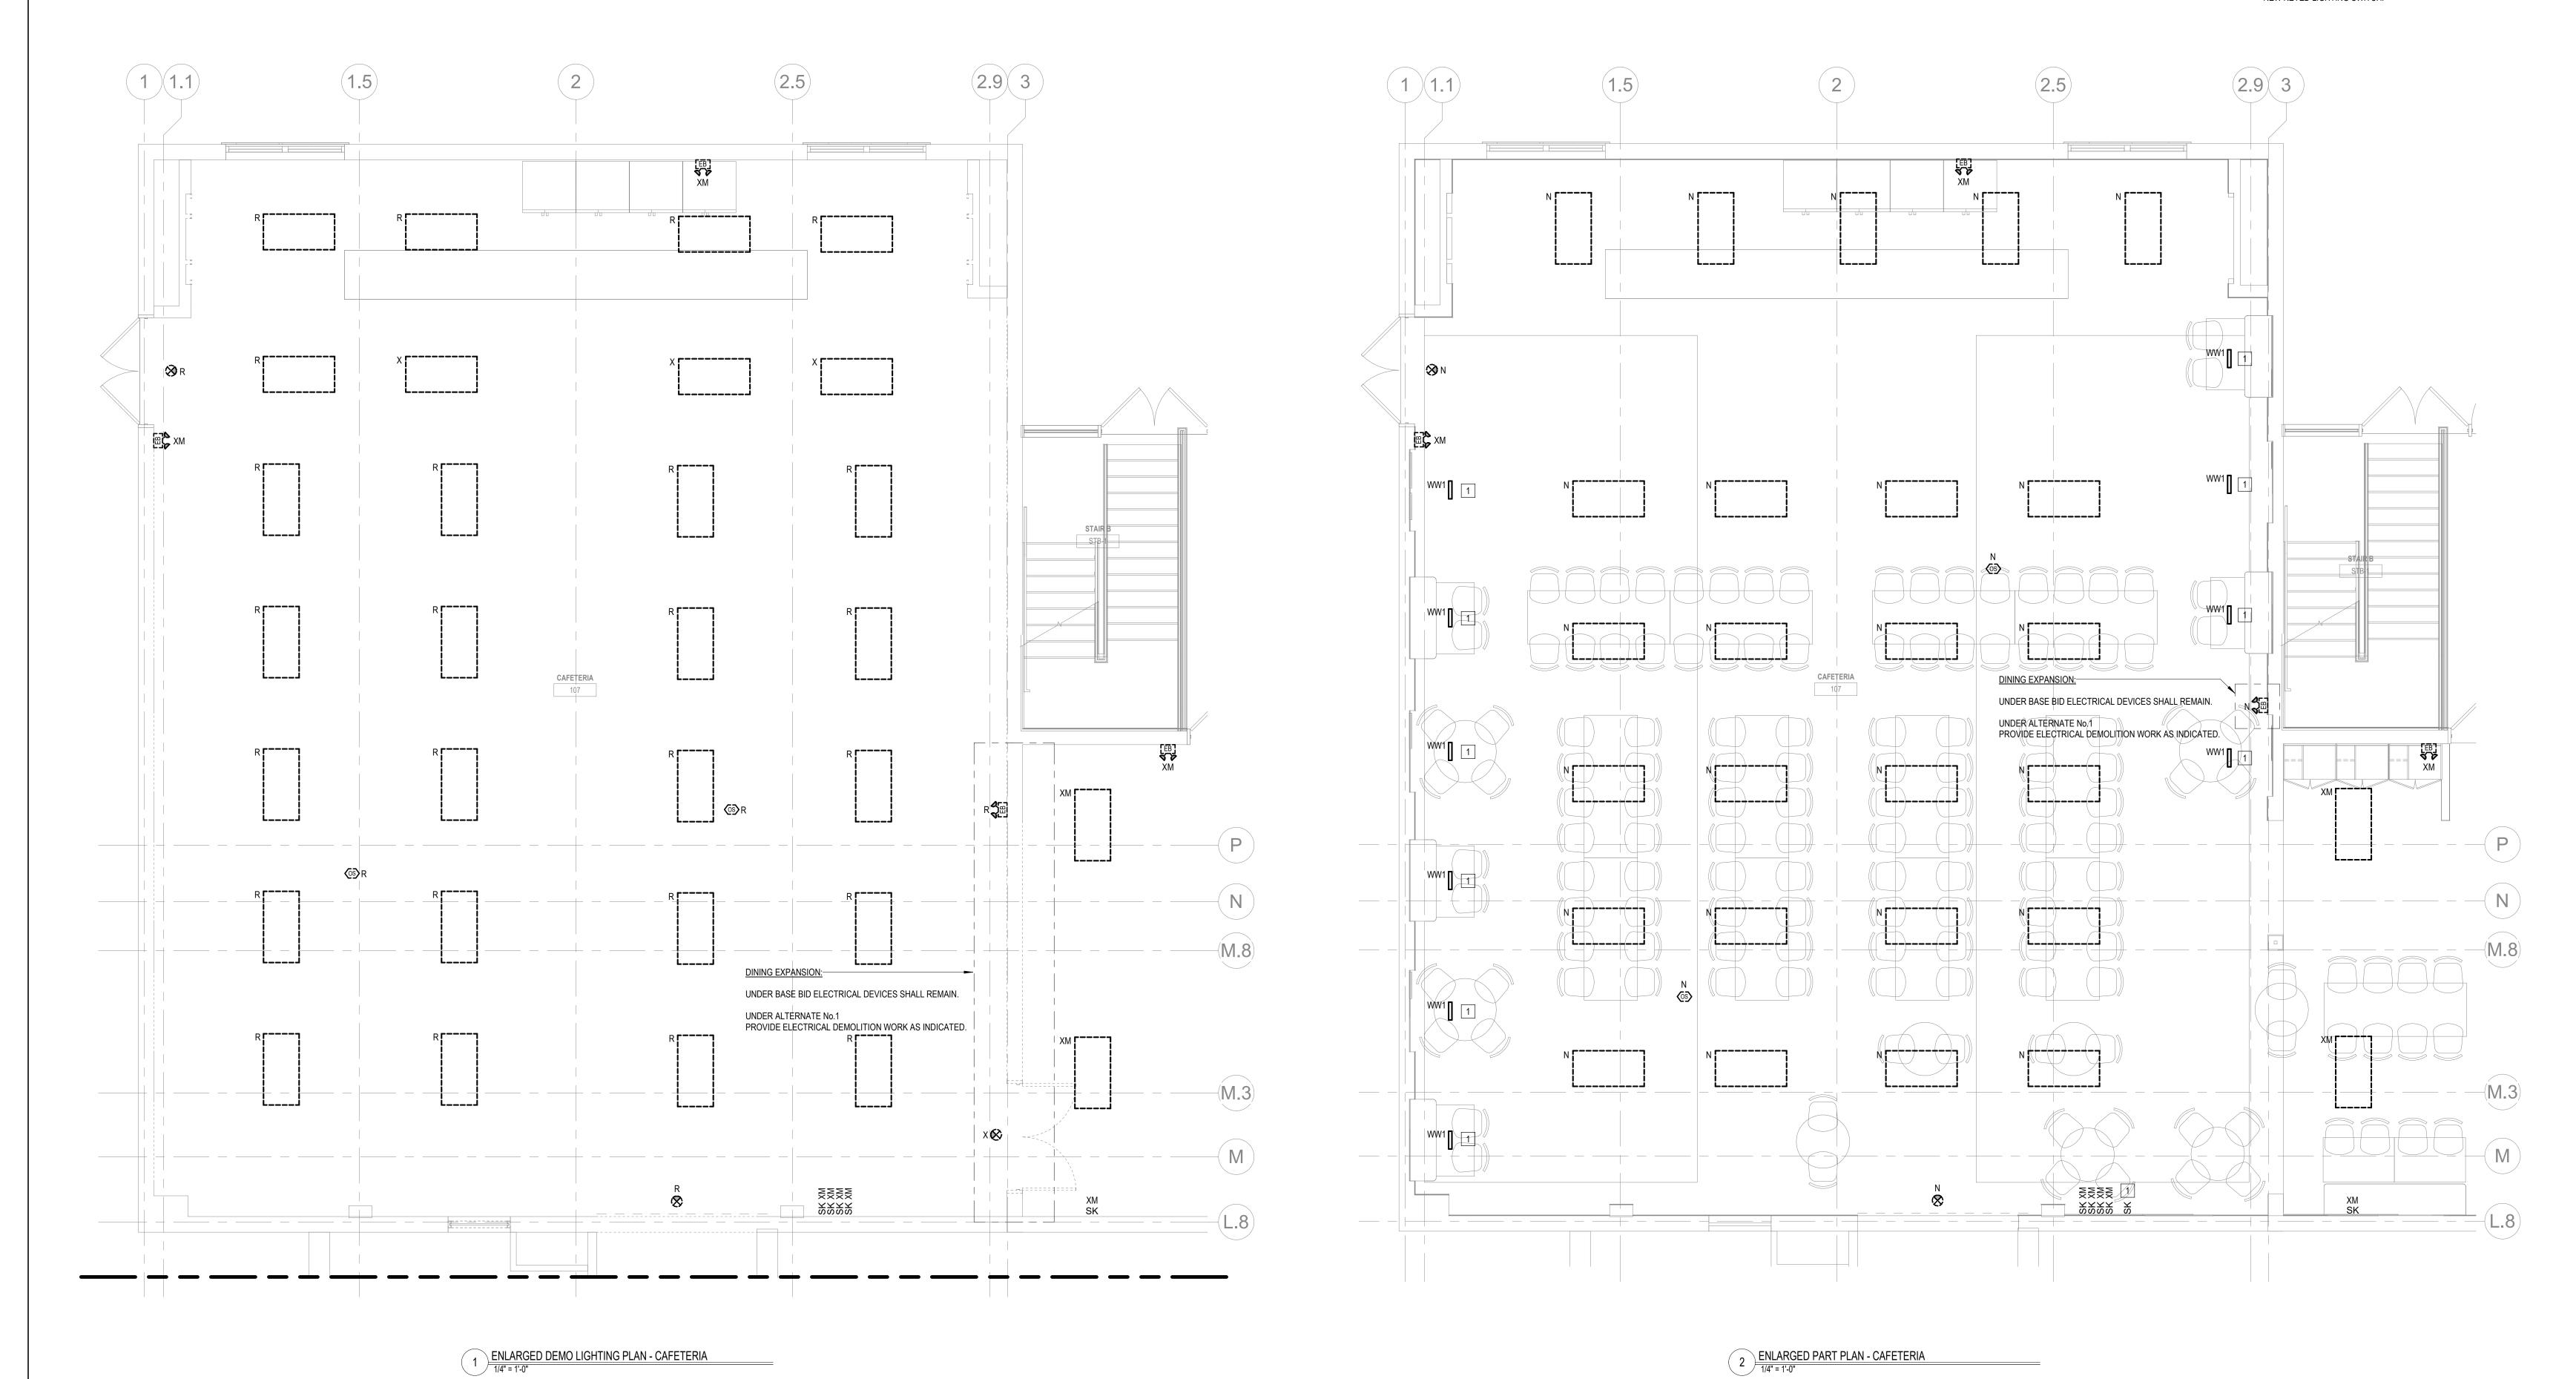

ARCHITECTS


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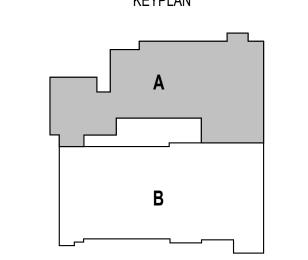


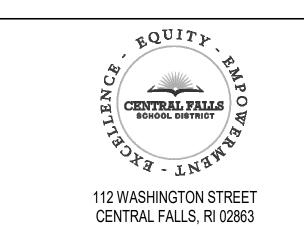

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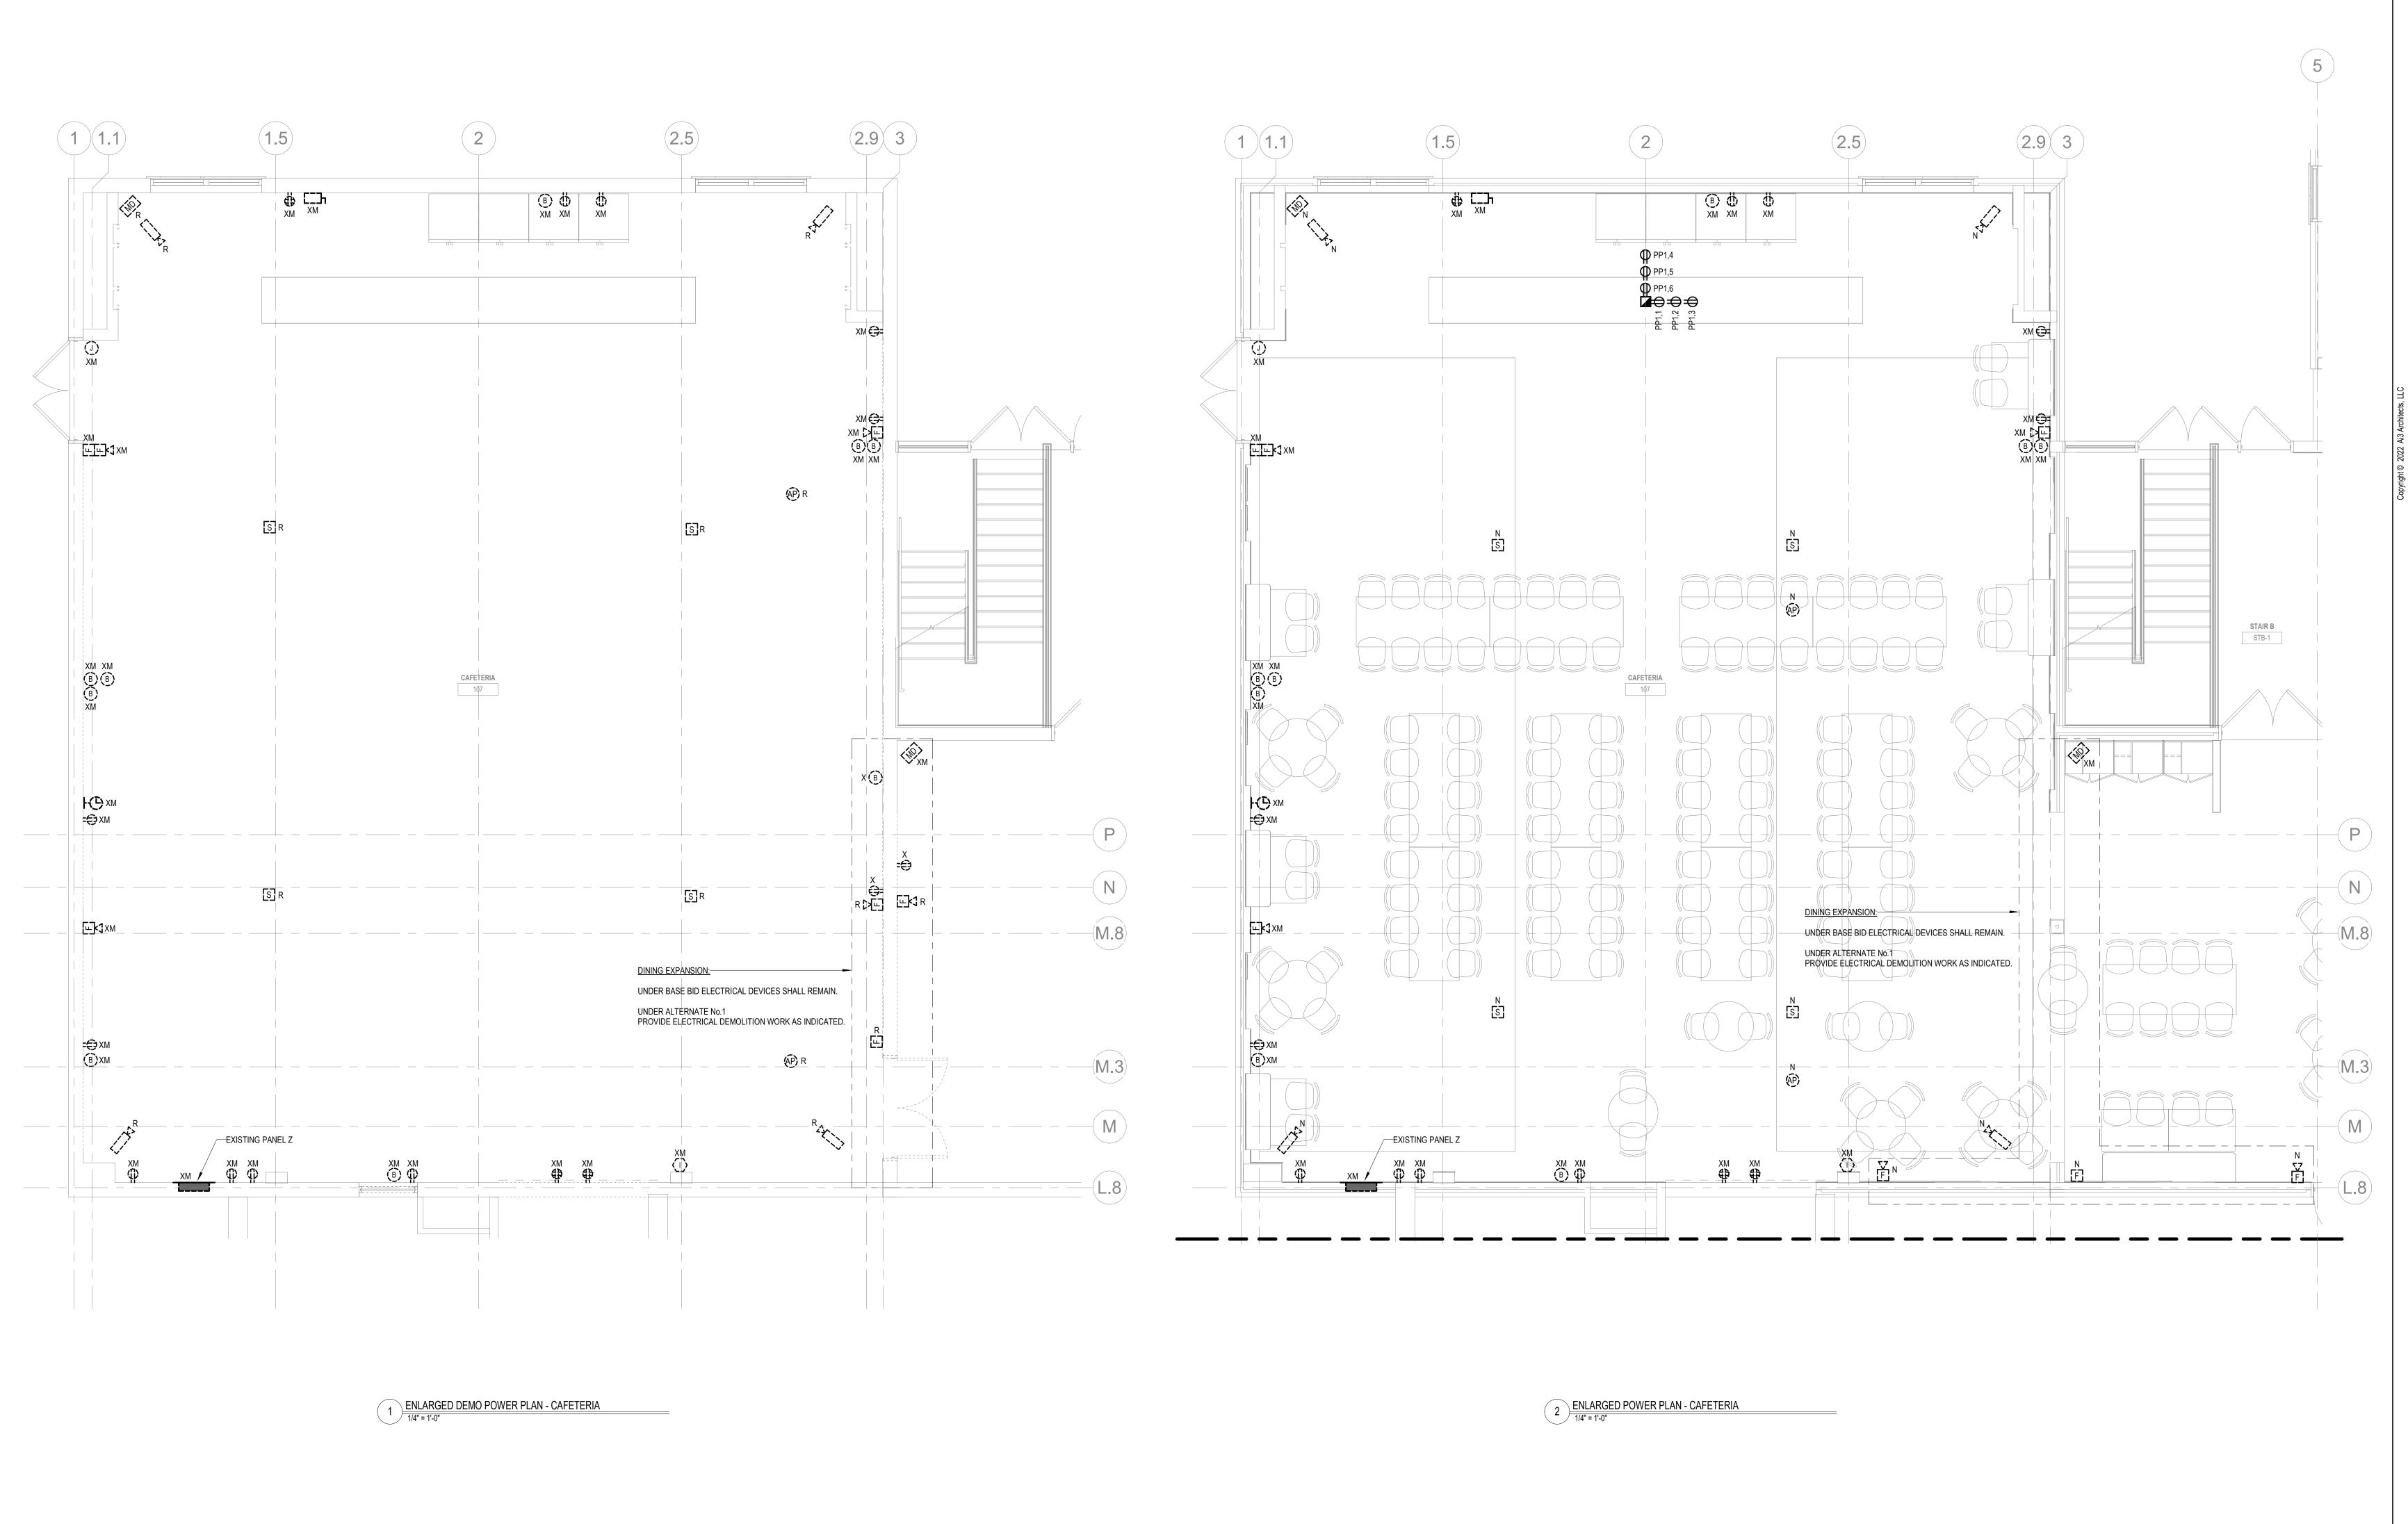




DRAWING NAME:

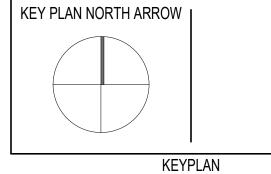ELECTRICAL ENLARGED CAFETRIA LIGHTING PLANS

DRAWN BY:		JGM
REVIEWED E	BY:	RCB
SCALE:	AS NOTED	DRAWING NUMBER:
JOB NO.:	2202.04	E3.01 B2
DATE:	June 22, 2023	






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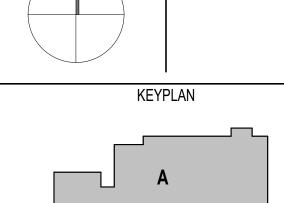



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KEYNOTE LEGEND:

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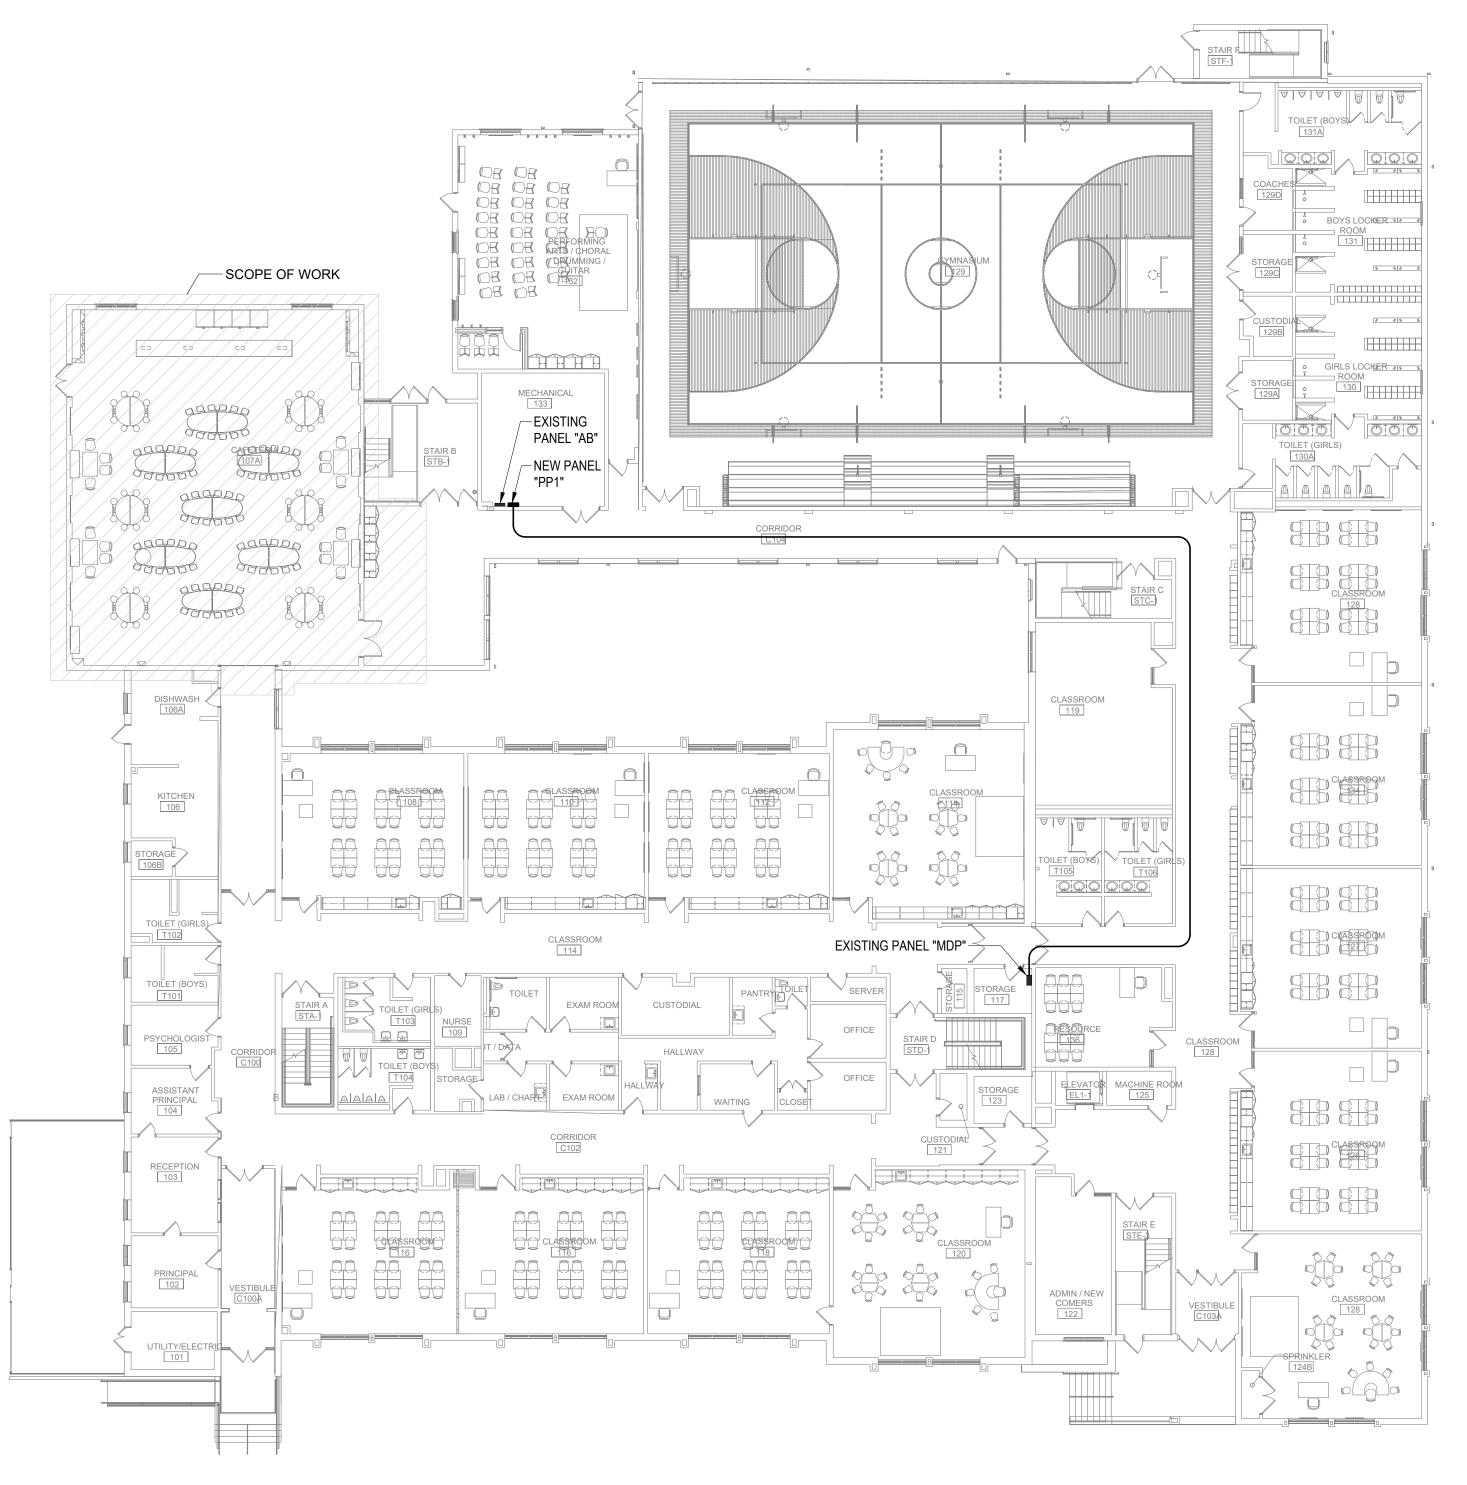


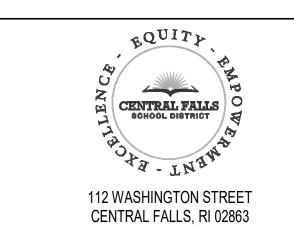


DRAWING NAME:

ELECTRICAL **ENLARGED CAFETRIA** POWER PLANS

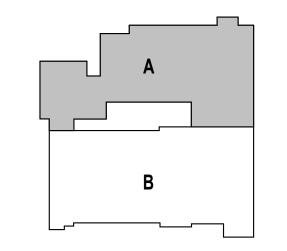DRAWN BY:		JGM
REVIEWED	BY:	RCB
SCALE:	AS NOTED	DRAWING NUMBER:
JOB NO.: DATE:	2202.04 June 22, 2023	E3.02 B2



2 FIRST FLOOR OVERALL PLAN SCALE: 1/16"=1'-0"

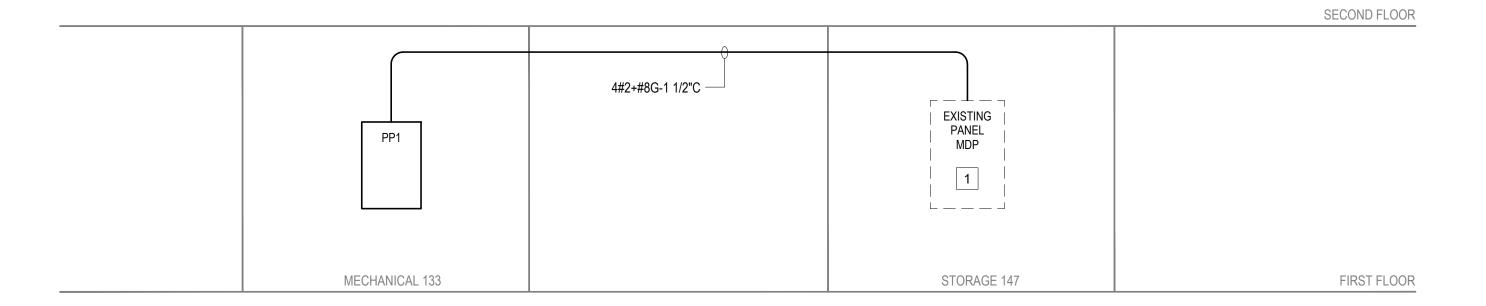

1 POWER RISER DIAGRAM

KEYED NOTES

1 ELECTRICAL SUB-CONTRACTOR SHALL PROVIDE NEW (1) 100A/3P CIRCUIT BREAKER IN EXISTING PANEL MDP TO FEED NEW PANEL "PP1". NEW CIRCUIT BREAKER SHALL MATCH EXISTING PANEL CHARACTERISTICS, FRAME TYPE, AIC

		PANELBOARD: PP1					•	10	0	Α,	2	30	3Y/	120	V, 3PH, 4W, (60H	ΗZ							
	V	MAIN LUG ONLY		SHUNT TRIP MAIN											LC = VIA LIGHTING CONTROL PANEL		GENERAL NOTES							
	65K	MAIN CIRCUIT BREAKER FLUSH MOUNTED SURFACE MOUNTED AIC BUS AMPS RATING		200% RATED NEUTRAL ISOLATED GROUND FEED THRU LUGS 100% RATED MAIN BREAKER GROUND FAULT MAIN C.B. COMPUTER PANEL SURGE PROTECTION DEVICE										NOTES	L = PROVIDE LOCK ON CB IG = ISOLATED GROUND P = GFPE - 30 mA TRIP G = GFCI - 5mA TRIP S = SHUNT TRIP A = ARC FAULT CIRCUIT BREAKER 3 = 3W + G 1. FOR SINGLE POLE CIRCUIT BREAKER PROVIDE 2 WIRES + GROUND, U.O.N 2. FOR TWO POLE CIRCUIT BREAKERS, PROVIDE 3 WIRES + GROUND, U.O.N 4. WIRE SIZES AS SHOWN ON PANEL								N S, N ERS,	
CKT NO.		LOAD DESCRIPTION	NOTE	WIRE SIZE		CIRCU			JIT E	BREAM	KER	ER CKT			LOAD DESCRIPTION	Ш	WIRE	CIRCUIT BREAKER						
						20/1	20/3	1		1	. .	, , NO.		LOAD DESCRIPTION	NOTE	SIZE	20/1	20/3	1			. .	1	
1		HOT FOOD BIN	G	8		1							2		HOT FOOD BIN	G	8	1						
3		HOT FOOD BIN	G	8		1							4		HOT FOOD BIN	G	8	1						
5		HOT FOOD BIN	G	8		1							6		HOT FOOD BIN	G	8	1						
7		SPARE				1							8		SPARE			1						
9		SPARE				1							10		SPARE			1						
11		SPARE				1							12		SPARE			1						
13		SPARE				1							14		SPARE			1						
15		SPARE				1							16		SPARE			1						
17		SPARE				1							18		SPARE			1						
19		SPARE				1							20		SPARE			1						
21		SPARE				1							22		SPARE			1						
23		SPARE				1							24		SPARE			1						
25		SPARE				1							26		SPARE			1						
27		SPARE				1							28		SPARE			1						
29		SPARE				1							30		SPARE			1						
31		SPARE				1							32		SPARE			1						
33		SPARE				1							34		SPARE			1						
35		SPARE				1							36		SPARE			1						
37		SPARE				1							38		SPARE			1						
39		SPARE				1							40		SPARE			1						
41		SPARE				1							42		SPARE			1						



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KEYNOTE LEGEND:

100% CONSTRUCTION DOCUMENTS
BID PACKAGE #2
KEY PLAN NORTH ARROW

KEYPLAN

DRAWING NAME:

ELECTRICAL POWER RISER AND PART PLAN

 DRAWN BY:
 JGM

 REVIEWED BY:
 RCB

 SCALE:
 AS NOTED | DRAWING NUMBER:

 JOB NO.:
 2202.04 | DATE:

 DATE:
 June 22, 2023 | E4.01 B2