

ARCHITECT

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Tel: (508) 358-0790

SPECIFICATIONS

WIL-SPEC, LLC

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CODE CONSULTANT

COSENTINI ASSOCIATES, INC.

101 Federal Street, 6th Floor
Boston, MA 02110
Tel: (617) 748-7800

OWNERS PROJECT MANAGER

PEREGRINE GROUP, LLC

20 Newman Avenue, Suite 1005
Rumford, RI 02916
Tel: (401) 270-0600

MECH. / ELEC. / PLUMB. ENGINEERS

GRIFFITH & VARY, INC.

12 Kendrick Road
Wareham, MA 02571
Tel: (508) 295-0050

COST ESTIMATOR

PROJECT MANAGEMENT & COST

20 Downer Ave., Suite 1C
Hingham, MA 02043
Tel: (781) 740-8007
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ACCESSIBILITY CONSULTANT

KESSLER McGUINESS ASSOCIATES, INC.

1 Bridge St., Suite A102
Newton, MA 02458
Tel: (617) 641-2802

DOOR HARDWARE CONSULTANT

SPEC CONSULTANTS, LLC

16 N. Mark Drive
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Tel: (508) 295-0050



DEMOLITION

- DA1.00 DEMOLITION GENERAL NOTES AND LEGEND
- DA1.11 B1 FIRST FLOOR DEMOLITION PLAN
- DA1.12 B1 SECOND FLOOR DEMOLITION PLAN
- DA1.13 B1 THIRD FLOOR DEMOLITION PLAN
- DA1.21 B1 TOILET ROOMS ENLARGED DEMOLITION PLANS & RCPs

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- A0.0B ABBREVIATIONS, SYMBOLS & MATERIALS INDICATIONS
- A0.0C PARTITION TYPES
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100% CONSTRUCTION DOCUMENTS BID PACKAGE #1

DEMOLITION LEGEND

— EXISTING CONSTRUCTION TO REMAIN

--- EXISTING CONSTRUCTION TO BE REMOVED
REFER TO SCHEDULED DEMOLITION NOTES
FOR SPECIFIC INSTRUCTIONS

- - - DENOTES APPROXIMATE EXTENTS OF
DEMOLITION WORK

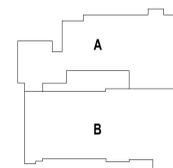
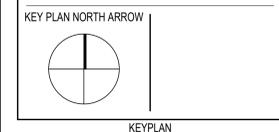
- GENERAL DEMOLITION NOTES**
- 1) Prior to the removal of structural walls, beams, lintels and other items, identify same and properly shore and brace as required keeping the structural integrity of the building. See specifications. Assess and methods of making new penetrations and modifications at existing structure shall be approved by the structural engineer prior to performing the work.
 - 2) Provide all trenching at existing subs for electrical, plumbing, mechanical and other utilities as required for demolition of existing utilities and installation of new work.
 - 3) Unless otherwise noted, all walls scheduled to be removed by Construction Manager, Construction Manager shall remove all electrical devices. For disconnecting and capping of lines and demolition of other electrical devices, please see electrical drawings.
 - 4) See plumbing drawings for removal of plumbing fixtures. Remove piping and other associated work to buried or concealed condition. Patch existing walls to remain to match existing and as required for application of new finish materials. See finish schedule.
 - 5) All existing structural columns to remain unless otherwise noted.
 - 6) Construction Manager shall coordinate the extent of demolition with proposed work.
 - 7) Selective demolition: all items designated for demolition are subject to selective demolition. Coordinate demolition and proposed drawings for the extent of demolition where existing items to remain are subject to new construction and/or refinishing.
 - 8) Refer to civil, fire protections, mechanical, plumbing, and structural drawings for additional demolition requirements.
 - 9) Coordinate with the owner any items to be removed and returned to the owner.
 - 10) Maintain existing required exit ways and establish temporary exit way SIGNAGE where necessary to direct occupants. Provide temporary fire rated enclosures when work requires opening fire rated partitions in progress.
 - 11) Verify existing conditions and report discrepancies to architect prior to commencing contract work. Accomplish all work necessary to permit the completion of contract work whether or not such work is directly referenced in contract documents.
 - 12) Core holes as required through existing roof and floor decks for new pipes. See plumbing drawings and roof plan for pipe sizes and location. Coordinate with specifications 01 73 28 - Cutting and Patching.
 - 13) Construction Manager shall provide temporary protection to exposed cavities, interior spaces and all other areas normally sheltered from weather during construction.
 - 14) Refer to the door schedule for additional (if any) demolition work on doors and/or door frames that are not indicated on plans.
 - 15) Where existing construction is indicated to be replaced it is the intent to remove the existing construction in its entirety as indicated on the drawings. Refer to construction documents for more information.
 - 16) Patch/infill surface for smooth surface in preparation for new surface finish after removal of existing built-in equipment, curbs and floor recesses or projections.
 - 17) Restore existing construction and finishes beyond contract limits where disturbed by contract work.
 - 18) Remove and properly dispose of all items left behind, not identified to be returned over to the owner (i.e. furniture, books, computers, TVs)
 - 19) Remove and dispose of existing door hardware not meeting accessibility requirements. Prepare door and adjacent surfaces for installation of accessible hardware.
 - 20) Salvage and store all existing painted door with Lite glass (offices) in walls being demolished for reuse/ installation. Existing hardwood doors with full lite glass are to remain. See architectural drawing for additional information.
 - 21) Salvage and store all existing six panel wood doors (storage closets) in wall being demolished for reuse/ installation. See architectural drawing for additional information.
 - 22) Salvage and store all existing hardwood trim (casing, base, crown, etc.) for reuse in matching and patching. See architectural drawing for additional information.
 - 23) Remove exposed water and air drops back to a point which would not interfere with the new work. Construction Manager to coordinate extents with scope of the new work and with Owner to confirm line shall not remain in place.

- SCHEDULED DEMOLITION NOTES**
- 1) REMOVE EXISTING FLOORING.
 - 2) REMOVE EXISTING CEILINGS.
 - 3) REMOVE ALL EXISTING PARTITIONS, FLOORS, PLUMBING FIXTURES, AND CASEWORK AS INDICATED.
 - 4) REMOVE ALL CEILING GRIDS AND TILES IN LOCATIONS NOTED PLANS AND COORDINATED WITH THE ROOM FINISH SCHEDULE.
 - 5) REMOVE WINDOW UNIT AND ALL ASSOCIATED WOOD BLOCKING, WINDOW TREATMENTS, INTERIOR WOOD TRIM AND APRON AS REQUIRED FOR INSTALLATION OF NEW WORK.
 - 6) REMOVE EXISTING DOOR HARDWARE INCLUDING TRANSOM PANEL WHERE OCCURS. PREPARE EXISTING DOOR FRAME AS REQUIRED TO RECEIVE SCHEDULED FINISH, DOOR AND HARDWARE. REFER TO DOOR SCHEDULE FOR ADDITIONAL INFORMATION.
 - 7) REMOVE EXISTING DOOR(S), FRAME(S), INCLUDING TRANSOM PANEL(S) AND SIDELITE(S), BLOCKING, TRIM AND THRESHOLDS.
 - 8) REMOVE CEILING MOUNTED DEVICES AND LIGHT FIXTURES. REFER TO ELECTRICAL DRAWINGS FOR ADDITIONAL INFORMATION.
 - 9) REMOVE EXISTING CASEWORK, BUILT-IN SHELVING, LOOSE SHELVING, WARDROBES, BASE AND UPPER CABINETS AND COUNTERTOPS.
 - 10) REMOVE EXISTING PLUMBING FIXTURE(S) AND LINES BACK TO A POINT WHICH WOULD NOT INTERFERE WITH NEW WORK.
 - 11) REMOVE EXISTING GYM EQUIPMENT INCLUDING BUT NOT LIFTED TO PULL UP BAGS, CURTAIN + TRACK, WALL PADS + FASTENERS, BLEACHERS, ROPES. PATCH & PREPARE SURFACE FOR NEW FINISH.
 - 12) REMOVE EXISTING WALL MOUNTED PARTITIONS AND ACCESSORIES. PROVIDE BLOCKING AND FURRING AT RECESSES TO ALIGN WITH EXISTING WALL FINISH TO RECEIVE NEW.
 - 13) REMOVE ALL WALL MOUNTED ITEMS AND PREPARE SURFACE FOR NEW FINISH.
 - 14) REMOVE EXISTING TECTUM WALL PANELS. PATCH & PREPARE SURFACE FOR NEW FINISH.
 - 15) REMOVE DOOR FRAME + HARDWARE IN ITS ENTIRETY.
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 - 18) PREPARE EXISTING FLOOR FOR INSTALLATION OF NEW POURED EPOXY FLOOR. SEE ARCHITECTURAL DRAWINGS FOR MORE INFORMATION.
 - 19) REMOVE & DISPOSE OF ALL WALL MOUNTED ITEMS NOT SCHEDULED TO REMAIN & PREPARE FOR NEW FINISH MATERIAL. SEE ARCHITECTURAL DRAWINGS FOR MORE INFORMATION.
 - 20) REMOVE & DISPOSE OF EXISTING ACOUSTICAL CEILING TILES. ALL ITEMS ASSOCIATED WITH EXISTING SUSPENSION SYSTEM ARE TO REMAIN. REFER TO ARCHITECTURAL, MECHANICAL, ELECTRICAL, PLUMBING DRAWINGS FOR MORE INFORMATION.
 - 21) REMOVE & DISPOSE OF ALL FINISHED CEILING MATERIALS NOT SCHEDULED TO REMAIN, INCLUDING GWB, AND ALL ITEMS ASSOCIATED WITH CEILING SUSPENSION SYSTEM, ACOUSTICAL TILES, ETC. REFER TO ARCHITECTURAL, MECHANICAL, ELECTRICAL, PLUMBING DRAWINGS FOR MORE INFORMATION. LEAVE EXPOSED STRUCTURE ABOVE CLEAN + FREE OF ALL ITEMS SCHEDULED FOR DEMOLITION FOR INSTALLATION OF NEW WORK.

112 WASHINGTON STREET
CENTRAL FALLS, RI 02863

KEYNOTE LEGEND:

**100% CONSTRUCTION DOCUMENTS
BID PACKAGE #1**



DRAWING NAME:


**DEMOLITION GENERAL
NOTES AND LEGEND**

DRAWN BY: MS

REVIEWED BY: JQ

SCALE: AS INDICATED | DRAWING NUMBER:
JOB NO.: 2202.04
DATE: June 22, 2023 | **DA1.00**

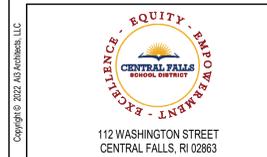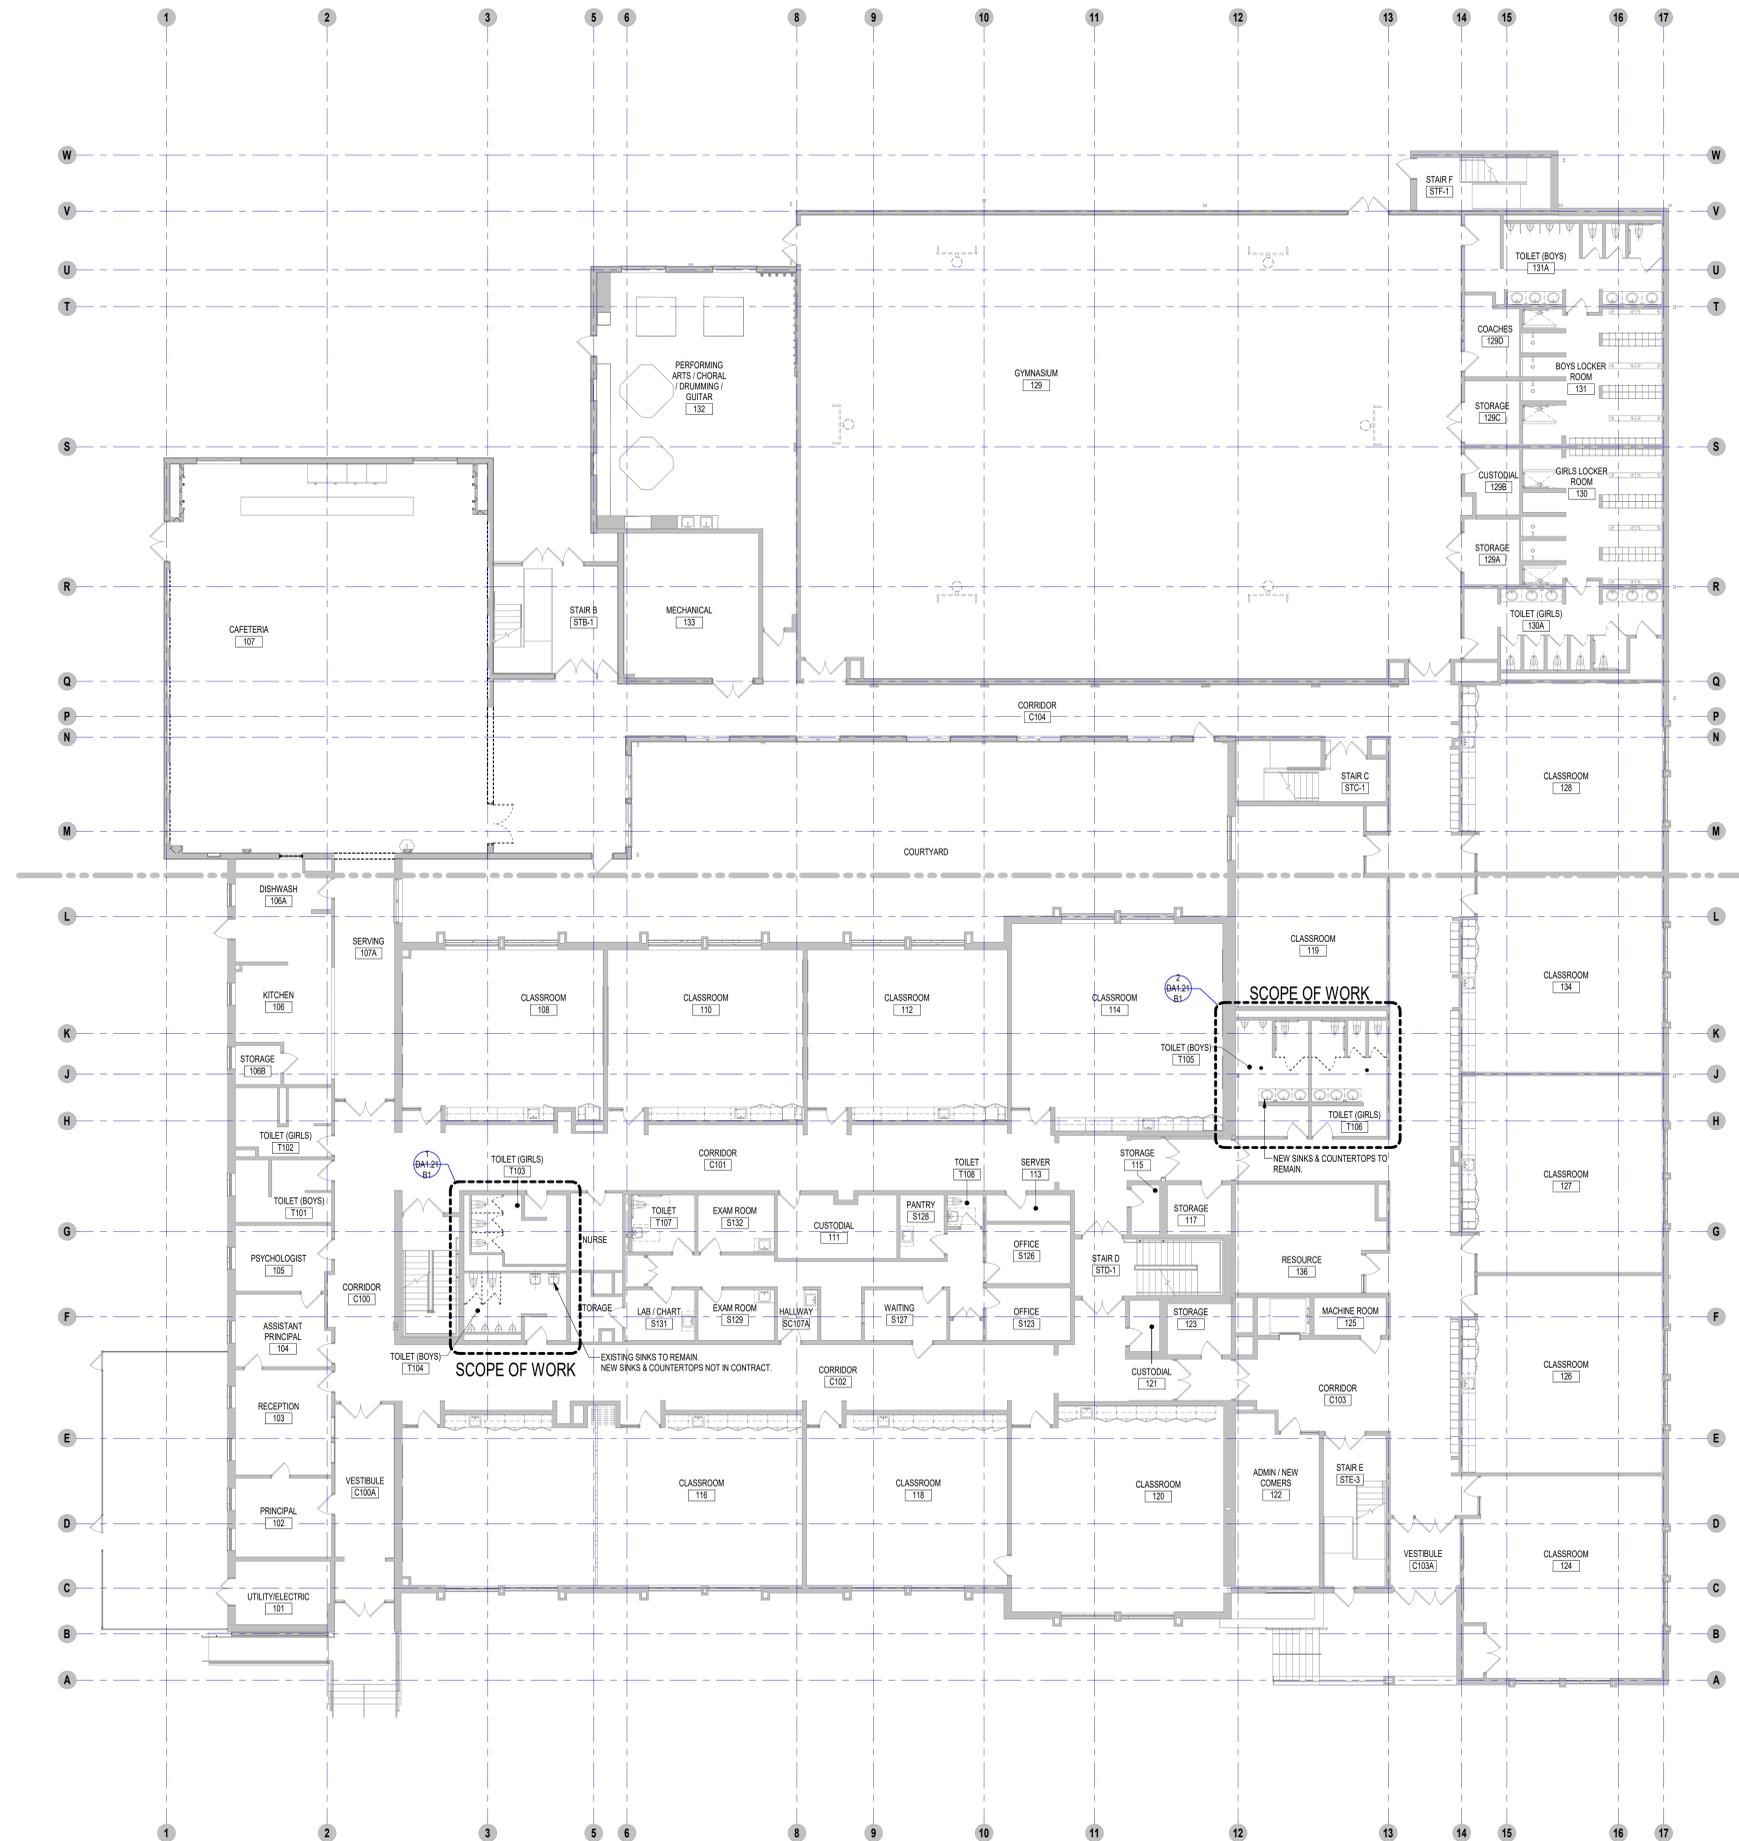
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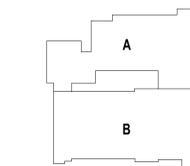


100% CONSTRUCTION DOCUMENTS
BID PACKAGE #1

KEY PLAN NORTH ARROW



KEYPLAN



DRAWING NAME:

FIRST FLOOR DEMOLITION
PLAN

DRAWN BY: MS / NS

REVIEWED BY: JQ

SCALE: AS INDICATED | DRAWING NUMBER:
JOB NO.: 2202.04
DATE: June 22, 2023 | DA1.11 B1

1 DEMO PLAN-1 FIRST FLOOR, BP1
3/32" = 1'-0"

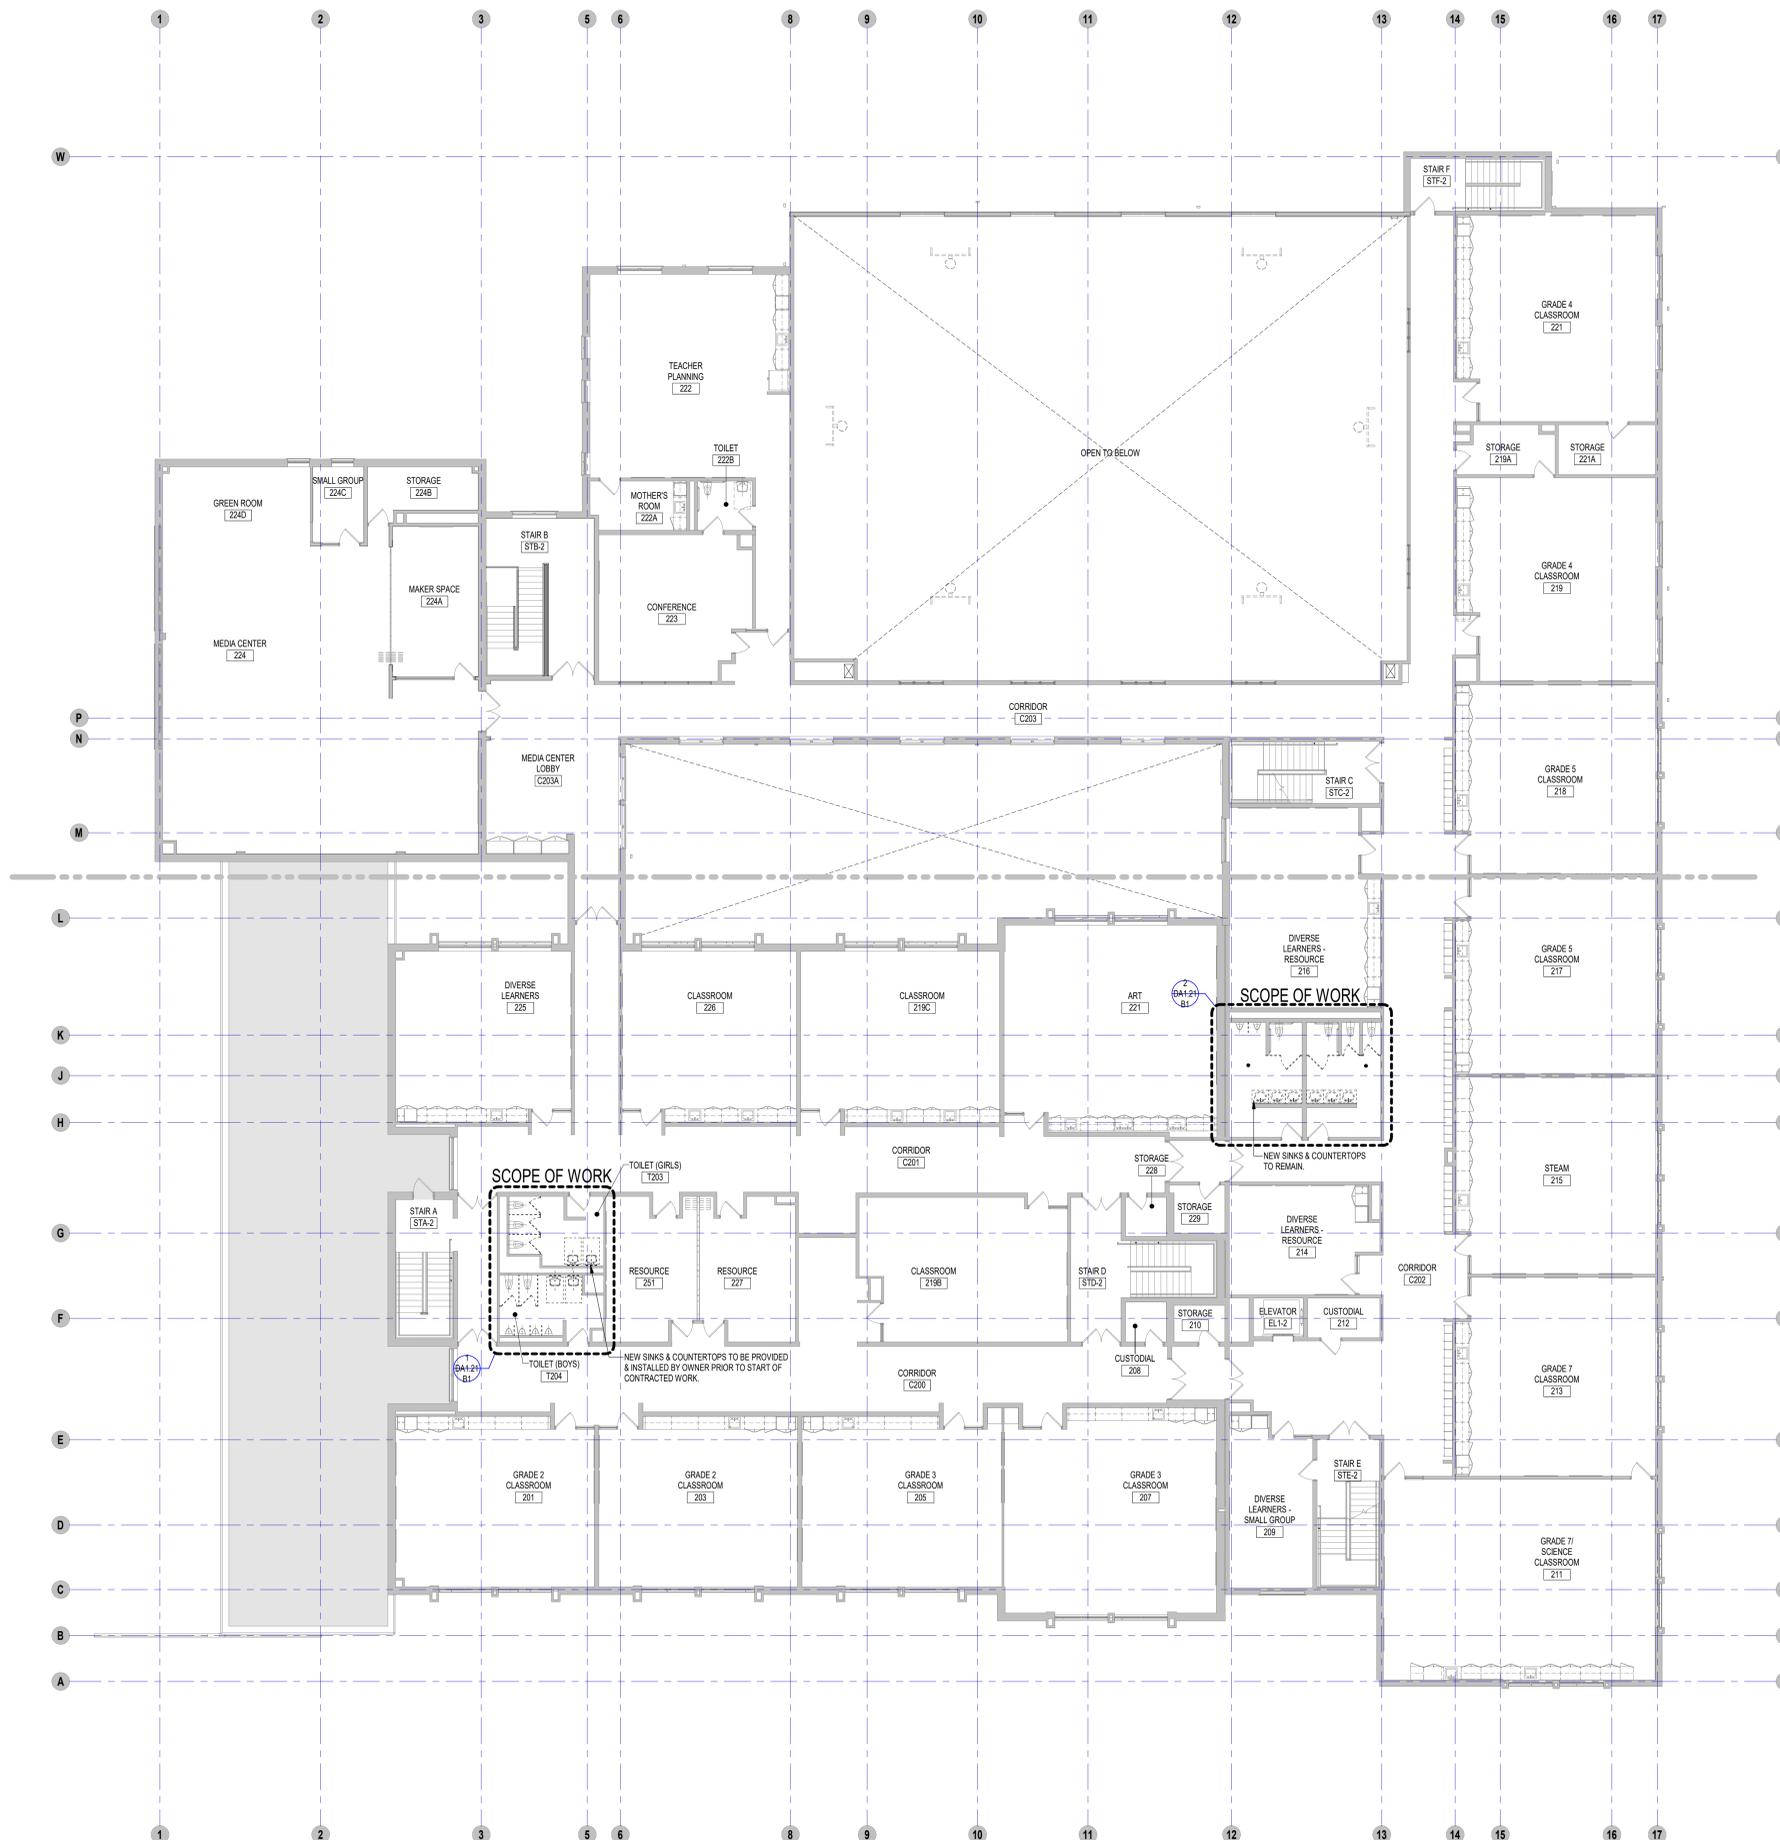
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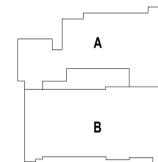


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BID PACKAGE #1

KEY PLAN NORTH ARROW



KEYPLAN



DRAWING NAME:

SECOND FLOOR
DEMOLITION PLAN

DRAWN BY: MS / NS

REVIEWED BY: JQ

SCALE: AS INDICATED | DRAWING NUMBER:
JOB NO.: 2202.04
DATE: June 22, 2023 | DA1.12 B1



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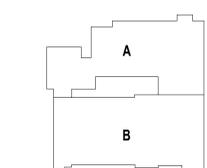
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KEYPLAN




DRAWING NAME:

THIRD FLOOR
DEMOLITION PLAN

DRAWN BY: MS / NS


REVIEWED BY: JQ

SCALE: AS INDICATED | DRAWING NUMBER:
JOB NO.: 2202.04
DATE: June 22, 2023 | DA1.13 B1

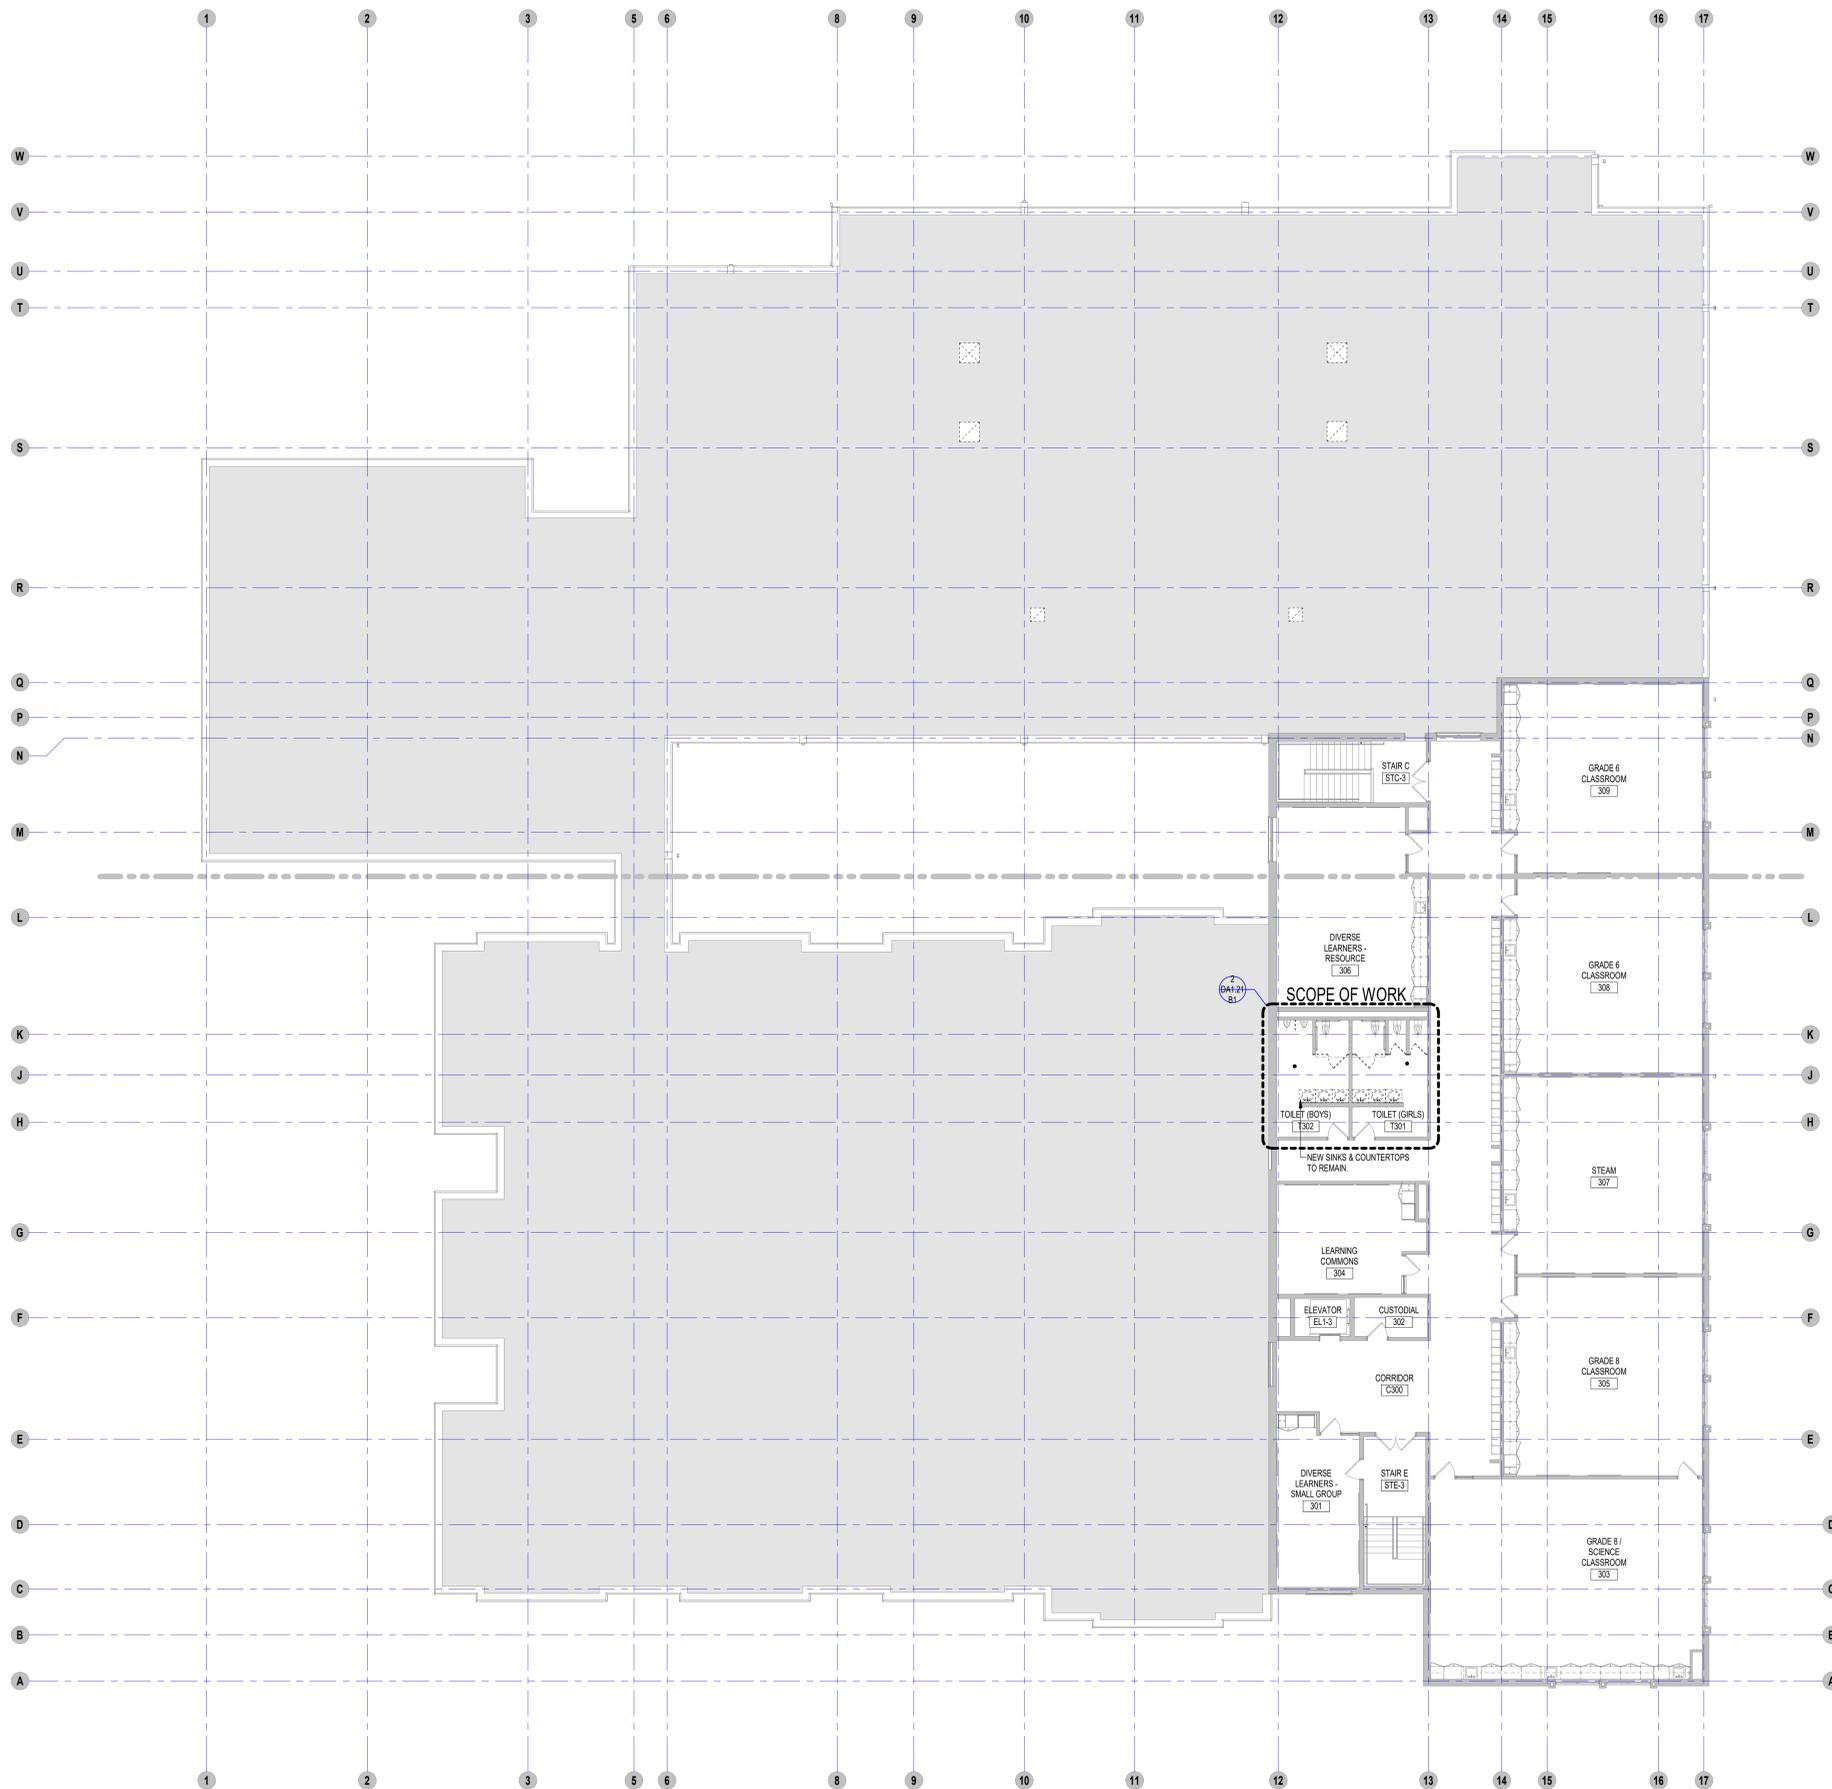


1 OVERALL THIRD FLOOR PLAN
3/32" = 1'-0"


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13	REMOVE ALL WALL MOUNTED ITEMS, RESTORE FOR REUSE, AND PREPARE SURFACE FOR NEW FINISH.
14	REMOVE EXISTING TECTUM WALL PANELS. PATCH + PREPARE SURFACE FOR NEW FINISH.
15	REMOVE DOOR, FRAME + HARDWARE IN ITS ENTIRETY.
16	REMOVE DOOR + HARDWARE + PREPARE FRAME FOR NEW DOOR + HARDWARE.
17	REMOVE HARDWARE + PREPARE DOOR + FRAME FOR NEW HARDWARE.
18	PREPARE EXISTING FLOOR FOR INSTALLATION OF NEW POURED EPOXY FLOOR. SEE ARCHITECTURAL DRAWINGS FOR MORE INFORMATION.
19	REMOVE + DISPOSE OF ALL WALL MOUNTED ITEMS NOT SCHEDULED TO REMAIN + PREPARE FOR NEW FINISH MATERIAL. SEE ARCHITECTURAL DRAWINGS FOR MORE INFORMATION.
20	REMOVE + DISPOSE OF EXISTING ACOUSTICAL CEILING TILES. ALL ITEMS ASSOCIATED WITH EXISTING SUSPENSION SYSTEM ARE TO REMAIN. REFER TO ARCHITECTURAL, MECHANICAL, ELECTRICAL, PLUMBING DRAWINGS FOR MORE INFORMATION.
21	REMOVE + DISPOSE OF ALL FINISHED CEILING MATERIALS NOT SCHEDULED TO REMAIN, INCLUDING GWB, AND ALL ITEMS ASSOCIATED WITH CEILING SUSPENSION SYSTEM, ACOUSTICAL TILES, ETC. REFER TO ARCHITECTURAL, MECHANICAL, ELECTRICAL, PLUMBING DRAWINGS FOR MORE INFORMATION. LEAVE EXPOSED STRUCTURE ABOVE CLEAN + FREE OF ALL ITEMS SCHEDULED FOR DEMOLITION FOR INSTALLATION OF NEW WORK.

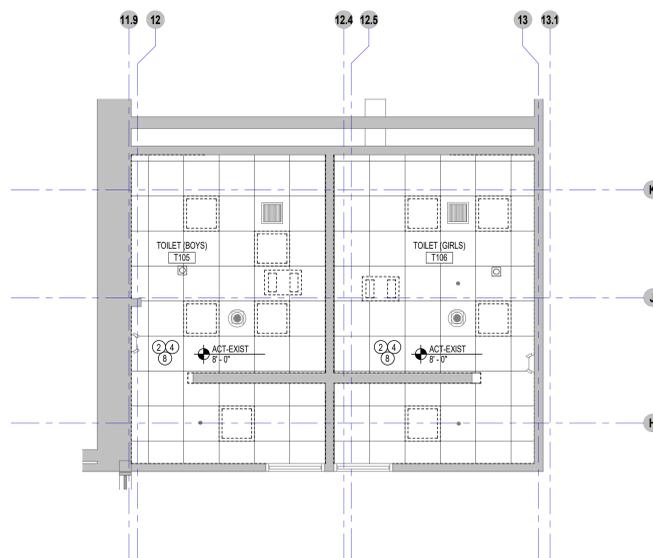

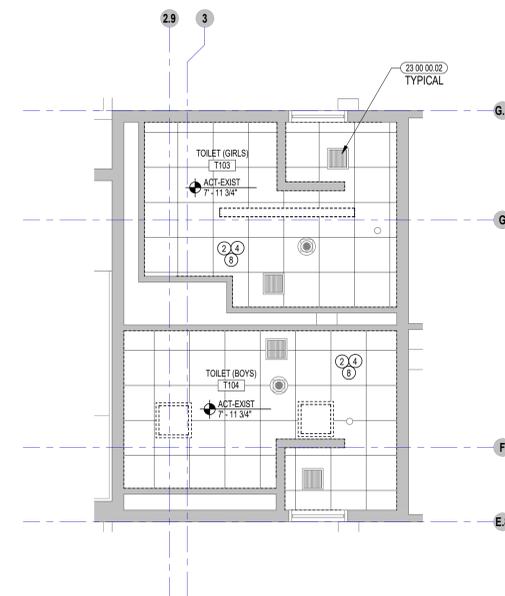
4 TYPICAL ENLARGED TOILET ROOM DEMO RCP
1/4" = 1'-0"



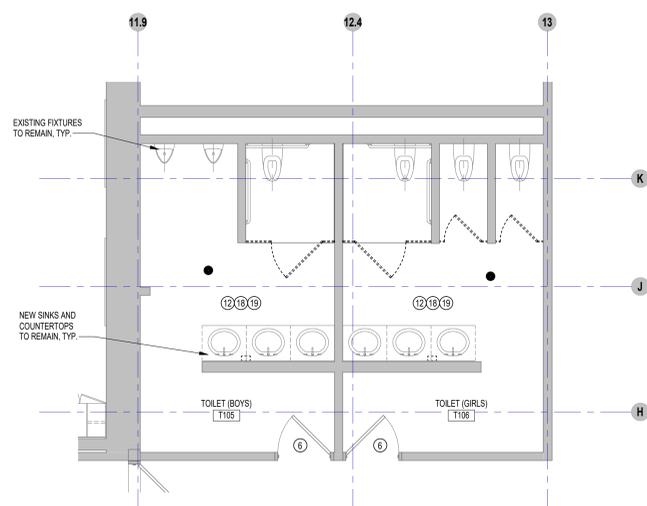3 TYPICAL ENLARGED TOILET ROOM DEMO RCP
1/4" = 1'-0"



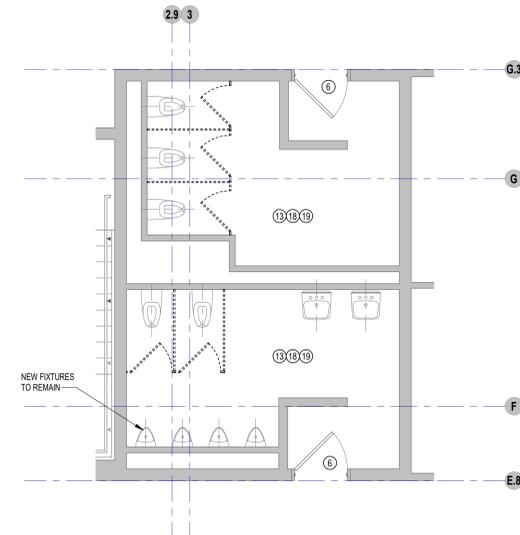2 TYPICAL ENLARGED TOILET ROOM DEMO PLAN
1/4" = 1'-0"




1 TYPICAL ENLARGED TOILET ROOM DEMO PLAN
1/4" = 1'-0"

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BID PACKAGE #1

KEY PLAN NORTH ARROW



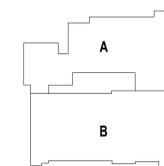KEYPLAN



DRAWING NAME:

TOILET ROOMS
ENLARGED DEMOLITION
PLANS & RCPs

DRAWN BY: MS / NS

REVIEWED BY: JQ

SCALE: AS INDICATED | DRAWING NUMBER:

JOB NO.: 2202.04

DATE: June 22, 2023 | DA1.21 B1

KEYNOTES_MASTER LEGEND

03 30 00.01	CONCRETE
03 30 00.03	CONCRETE SLAB ON DECK - SEE STRUCTURAL
04 20 00.01	FACE BRICK - REFERENCE ELEVATIONS FOR TYPE AND COURSING
04 20 00.31	CMU - STANDARD - NORMAL WEIGHT - REFERENCE DRAWINGS FOR DEPTH SIZE AND FIRE RATING
04 20 00.32	CMU BOND BEAM - SEE STRUCTURAL
04 20 00.51	GROUT FILL
05 31 00.01	COMPOSITE STEEL DECK - SEE STRUCTURAL
05 31 00.11	STEEL ROOF DECK - 3 INCH GALVANIZED - SEE STRUCTURAL
05 40 00.03	STEEL STUDS - 3/8 INCH - 16 INCHES O.C. MAX
05 40 00.19	STEEL Z-CLIP - 16 GAGE MIN. - 1 INCH MIN. DEPTH - 16 INCHES O.C. MAX
05 40 00.21	ISOLATION HANGER
05 50 00.10	STEEL ANGLE - SEISMIC CLIP - SEE STRUCTURAL
05 50 00.22	STEEL TUBE - SIZE AS NOTED OR DRAWN
05 50 00.32	STEEL BENT PLATE - SEE STRUCTURAL
05 50 00.41	STEEL PLATE - 1/4 INCH THICK - SIZE AS NOTED OR DRAWN
05 50 00.92	EXPANSION BOLT
06 10 00.23	WOOD BLOCKING - FIRE RETARDANT TREATED - SIZE AS NOTED OR DRAWN
06 10 00.99	WOOD BLOCKING - SIZE AS NOTED OR DRAWN
06 20 00.03	HARDWOOD TRIM - EASED EDGE 1/4 INCH RADIUS - TRANSPARENT FINISH
06 20 00.04	HARDWOOD TRIM - BULLNOSE - TRANSPARENT FINISH
06 20 00.21	HARDWOOD TRIM - 1/2 INCH - TRANSPARENT FINISH
06 20 00.23	HARDWOOD TRIM - 3/4 INCH - TRANSPARENT FINISH
06 20 00.62	FLAG HOOK STANDOFF WITH CAP
06 20 00.71	GROUT/MET - 3 INCH - PLASTIC
06 20 00.72	WIRE MANAGEMENT HOOKS - 12 INCHES O.C. - UNDER COUNTER
06 20 00.73	STEEL UNDER COUNTER SUPPORT BRACKET - SIZE AS NOTED OR DRAWN
06 20 00.81	PLASTIC LAMINATE - TYPE 1
06 20 00.82	PLASTIC LAMINATE BACKSPASH - 4 INCH
06 20 00.95	REMOVABLE ACCESS PANEL - MATCH ADJACENT FINISH
06 20 00.99	WOOD BLOCKING - SIZE AS NOTED OR DRAWN
06 40 00.33	HARDWOOD VENEER PLYWOOD - 3/4 INCH - TRANSPARENT FINISH
07 21 00.20	GLASS FIBER BLANKET INSULATION - MATCH DEPTH OF STUD - UNFACED
07 21 00.22	GLASS FIBER ACOUSTICAL BLANKET INSULATION - MATCH DEPTH OF STUD - UNFACED
07 21 00.29	MINERAL WOOL INSULATION
07 21 00.32	MINERAL WOOL ACOUSTICAL INSULATION - 3 1/2 INCH
07 84 00.01	FIRE SAFING MINERAL WOOL
07 84 00.02	CAULK - CAULK AND PUTTY
07 84 00.03	FIRE STOP MORTAR
07 84 00.04	FIRE STOP PILLOWS
07 92 00.01	JOINT SEALANT - TYPE AS REQUIRED
07 92 00.02	BACKER ROD AND SEALANT - TYPE AS REQUIRED
07 92 00.03	EXPANSION JOINT COVER - 4 INCH - INTERIOR - FLOOR / FLOOR
08 11 13.10	STEEL DOOR - SEE SCHEDULE FOR TYPES
08 11 13.11	STEEL FRAME - SEE SCHEDULE FOR TYPES
08 11 13.20	STEEL FRAME CLIP BY FRAME INSTALLER
08 11 13.21	STEEL FRAME ANCHOR
08 14 16.01	SOLID CORE FLUSH WOOD DOOR - SEE DOOR SCHEDULE
08 71 00.11	ALUMINUM THRESHOLD
09 21 23.11	METAL SHAFTWALL C-H STUD - 2 1/2 INCH - 24 INCHES O.C. MAX
09 21 23.12	METAL SHAFTWALL J-RUNNER
09 21 23.21	GYPSPUM SHAFTWALL LINER PANEL - 1 INCH
09 21 23.31	GYPSPUM BOARD - 5/8 INCH TYPE X - 1 LAYER
09 21 23.32	GYPSPUM BOARD - 5/8 INCH TYPE X - 2 LAYERS
09 21 23.41	METAL SHAFTWALL C-STUD TRACK - 2 INCH
09 21 23.42	METAL SHAFTWALL H-STUD - 2 INCH
09 21 23.51	ALUMINUM 2002-12 INCH BREAKAWAY CLIP - MAX 10 FEET O.C. VERTICALLY
09 22 16.01	METAL STUD 1-5/8 INCH - 16 INCHES O.C. MAX
09 22 16.03	METAL STUD 3-5/8 INCH - 16 INCHES O.C. MAX
09 22 16.06	METAL STUD 6 INCH - 16 INCHES O.C. MAX
09 22 16.08	METAL STUD 8 INCH - 16 INCHES O.C. MAX
09 22 16.20	METAL STUD - REFER TO FLOOR PLANS FOR DEPTH
09 22 16.21	METAL FURRING CHANNEL - 7/8 INCH - 16 INCHES O.C. MAX
09 22 16.31	BOXED HEADER
09 22 16.41	METAL DEFLECTION TRACK ASSEMBLY
09 22 16.42	METAL DEFLECTION TRACK ASSEMBLY - FIRE RATED
09 22 16.51	METAL STUD BRACE
09 22 16.99	METAL CLIP FOR WALL FRAMING - 16 GA - 24 INCHES O.C. MAX
09 29 00.01	5/8 INCH GYPSPUM BOARD - LEVEL 4 FINISH - 1 LAYER
09 29 00.02	5/8 INCH GYPSPUM BOARD - LEVEL 4 FINISH - 2 LAYERS
09 29 00.09	
09 29 00.11	5/8 INCH PLYWOOD - FIRE RETARDANT TREATED
09 29 00.21	5/8 INCH GYPSPUM BOARD - LEVEL 4 FINISH - SAG-RESISTANT
09 29 00.31	5/8 INCH GYPSPUM BOARD - LEVEL 4 FINISH - IMPACT RESISTANT
09 29 00.43	CORNER BEAD
09 29 00.99	GYPSPUM BOARD SYSTEM - LEVEL 4 FINISH - REFER TO FLOOR PLANS AND WALL TYPES FOR COMPONENTS
09 30 13.01	
09 30 13.11	
09 30 16.01	
09 30 19.01	
09 30 19.51	
09 51 00.01	ACT TYPE-1 - REFERENCE REFLECTED CEILING PLANS FOR GRID PATTERN
09 51 00.02	ACT TYPE-2
09 51 00.04	ACT TYPE-4
09 51 00.51	ACT SUSPENSION SYSTEM
09 51 00.52	EDGE MOLDING SYSTEM
09 51 00.61	PERIMETER EDGE TRIM SYSTEM - VERTICAL PROFILE - HEIGHT AS NOTED
09 51 00.99	ACOUSTICAL CEILING - REFERENCE REFLECTED CEILING PLANS FOR TYPE AND HEIGHT
09 64 29.01	WOOD STRIP AND PLANK FLOOR
09 64 66.01	WOOD ATHLETIC FLOOR
09 64 66.02	RUBBER COVE WALL BASE - VENTED
09 64 66.05	GAME LINES - COURT MARKINGS - PAINTED
09 64 66.07	STENCIL LETTERING - PAINTED

KEYNOTES_MASTER LEGEND

09 64 66.08	BORDER - PAINTED
09 64 66.09	ACCENT - PAINTED
09 65 13.01	RUBBER BASE - 4 INCH
09 65 16.01	RESILIENT SHEET FLOORING - RSF-1
09 65 16.11	TRANSITION STRIP
09 65 19.01	RESILIENT TILE FLOORING - RTF-1
09 65 19.11	TRANSITION STRIP
09 65 23.02	RUBBER FLOOR TILE - HAMMERED PROFILE
09 65 23.03	RUBBER FLOOR TILE - ATHLETIC
09 65 23.11	TRANSITION STRIP
09 65 23.12	TRANSITION STRIP - REDUCING STRIP
09 65 36.01	STATIC-CONTROL COMPOSITE TILE
09 65 36.11	TRANSITION STRIP
09 67 23.01	FLUID APPLIED FLOORING - UCF-1
09 67 23.02	FLUID APPLIED FLOORING - UCF-2
09 68 00.01	CARPET
09 68 00.11	RUBBER CARPET REDUCING STRIP
09 68 13.01	TILE CARPET - OPT-1
09 68 13.11	RUBBER CARPET REDUCING STRIP
09 77 33.01	GLASS FIBER REINFORCED PLASTIC PANEL
09 84 00.21	ACOUSTICAL PANEL - WALL MOUNTED - TECTUM - TYPE 1
09 91 00.01	PAINT - SEE SCHEDULE
10 11 16.01	DRY MARKER BOARD
10 14 00.01	INTERIOR SIGNAGE - TYPE AS SCHEDULED
10 14 00.02	INTERIOR SIGNAGE - VINYL WALL GRAPHIC
10 21 13.01	TOILET COMPARTMENT
10 21 13.11	TOILET PARTITION - PANEL
10 21 13.31	URINAL SCREEN
10 21 23.01	CURTAIN TRACK AND CURTAIN
10 28 41.01	BULLETPROOF RESISTANT PANEL - LEVEL 4 - ILL 752
10 44 00.01	FIRE EXTINGUISHER CABINET - FULLY RECESSED
10 44 00.11	FIRE EXTINGUISHER
11 61 00.21	
11 61 00.41	PIPE GRID - TV STUDIO
11 66 23.01	WALL PADDING - TYPE 1
11 66 23.11	VOLLEYBALL STANDARD FLOOR INSERT
12 30 00.03	TALL CABINET
12 30 00.20	PLASTIC LAMINATE COUNTERTOP
12 30 00.21	PLASTIC LAMINATE BACKSPASH - 4 INCH
12 30 00.22	PLASTIC LAMINATE BACKSPASH - 6 INCH
12 48 13.01	RECESSED ENTRANCE MAT - REFERENCE DRAWINGS FOR SIZE
12 48 13.10	EXTRUDED ALUMINUM RECESSED FRAMING - L SHAPE
12 66 13.01	TELESCOPING POWER ASSISTED BLEACHERS
22 00 00.01	SNK - SEE PLUMBING
22 00 00.03	WATER FOUNTAIN - SEE PLUMBING
22 00 00.21	FLOOR DRAIN - SEE PLUMBING
23 00 00.02	DIFFUSER - SEE HVAC
23 00 00.25	RADIANT PANEL - SEE HVAC





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KEYNOTE LEGEND:
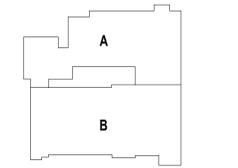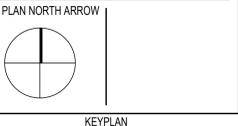
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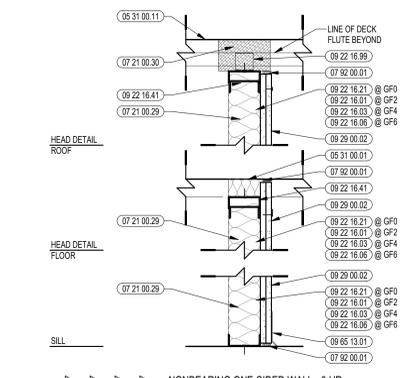
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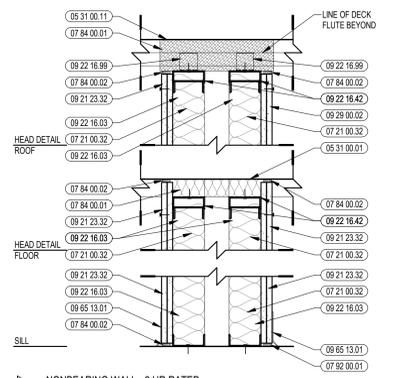
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REVIEWED BY:	KRK	
SCALE:	AS INDICATED	DRAWING NUMBER:
JOB NO.:	2202.04	A0.0A
DATE:	June 22, 2023	

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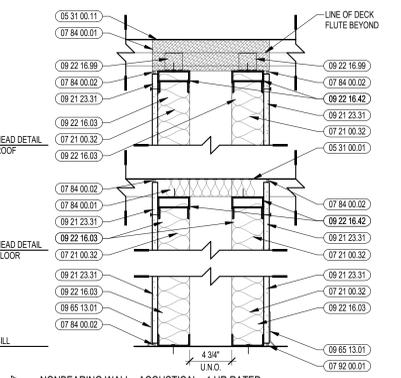
- 05 31 00.01 COMPOSITE STEEL DECK - SEE STRUCTURAL
- 05 31 00.11 STEEL ROOF DECK - 3 INCH GALVANIZED - SEE STRUCTURAL
- 05 40 00.03 STEEL STUDS - 3/8 INCH - 16 INCHES O.C. MAX
- 05 40 00.19 STEEL Z-CLIP - 1/8 GAGE MIN - 1 INCH MIN. DEPTH - 1/8 INCHES O.C. MAX
- 07 21 00.20 GLASS FIBER BLANKET INSULATION - MATCH DEPTH OF STUD - UNFACED
- 07 21 00.22 GLASS FIBER ACOUSTICAL BLANKET INSULATION - MATCH DEPTH OF STUD - UNFACED
- 07 21 00.29 MINERAL WOOL INSULATION
- 07 21 00.30 MINERAL WOOL ACOUSTICAL INSULATION - 3 1/2 INCH
- 07 40 00.01 FIRE SAFING MINERAL WOOL
- 07 84 00.02 CAULK - CALK AND PUTTY
- 07 92 00.01 JOINT SEALANT - TYPE AS REQUIRED
- 09 21 23.21 GYPSUM SHAFTWALL LINER PANEL - 1 INCH
- 09 21 23.31 GYPSUM BOARD - 5/8 INCH TYPE X - 1 LAYER
- 09 21 23.32 GYPSUM BOARD - 5/8 INCH TYPE X - 2 LAYERS
- 09 21 23.41 METAL SHAFTWALL C-STUD TRACK - 2 INCH
- 09 21 23.42 METAL SHAFTWALL H STUD - 2 INCH
- 09 21 23.51 ALUMINUM 2002-1/2 INCH BREAKAWAY CLIP - MAX 10 FEET O.C. VERTICALLY
- 09 22 16.01 METAL STUD 1-5/8 INCH - 16 INCHES O.C. MAX
- 09 22 16.03 METAL STUD 3-5/8 INCH - 16 INCHES O.C. MAX
- 09 22 16.06 METAL STUD 6 INCH - 16 INCHES O.C. MAX
- 09 22 16.08 METAL STUD 10 INCH - 16 INCHES O.C. MAX
- 09 22 16.21 METAL FURRING CHANNEL - 7/8 INCH - 16 INCHES O.C. MAX
- 09 22 16.41 METAL DEFLECTION TRACK ASSEMBLY
- 09 22 16.42 METAL DEFLECTION TRACK ASSEMBLY - FIRE RATED
- 09 22 16.99 METAL CLIP FOR WALL FRAMING - 1/8 GA. - 24 INCHES O.C. MAX
- 09 29 00.01 5/8 INCH GYPSUM BOARD - LEVEL 4 FINISH - 1 LAYER
- 09 29 00.02 5/8 INCH GYPSUM BOARD - LEVEL 4 FINISH - 2 LAYERS
- 09 29 00.03 5/8 INCH GYPSUM BOARD - LEVEL 4 FINISH - IMPACT RESISTANT
- 09 29 00.99 GYPSUM BOARD SYSTEM - LEVEL 4 FINISH - REFER TO FLOOR PLANS AND WALL TYPES FOR COMPONENTS
- 09 30 13.11 RUBBER BASE - 4 INCH
- 09 65 13.01 BULLET RESISTANT PANEL - LEVEL 4 - UL 752
- 19 28 41.01




F23 NONBEARING ONE-SIDED WALL - 0 HR
STUDS ARE INSTALLED MAXIMUM 12" O.C.




F23 NONBEARING WALL - 2 HR RATED
UL DESIGN NO. V446



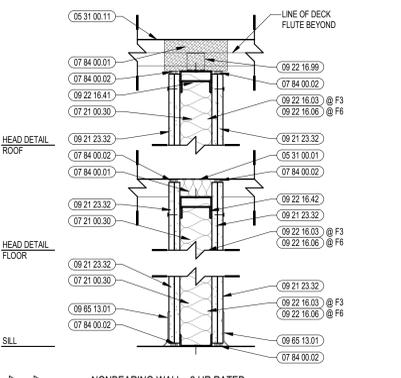F11 NONBEARING WALL - ACOUSTICAL - 1 HR RATED
UL DESIGN NO. U493
STC 53
- EACH ROW OF STUDS TO BE FREESTANDING TO PREVENT TRANSMISSION OF NOISE



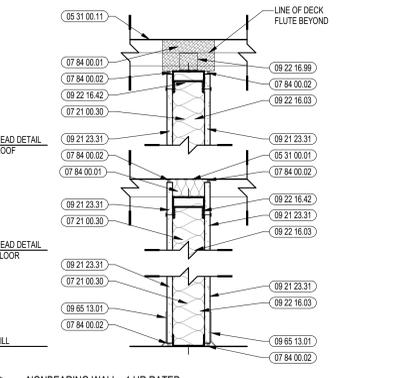
F3 NONBEARING WALL - 2 HR RATED
UL DESIGN NO. U419
STC 50




F4 NONBEARING WALL - 1 HR RATED
UL DESIGN NO. U419
STC 48



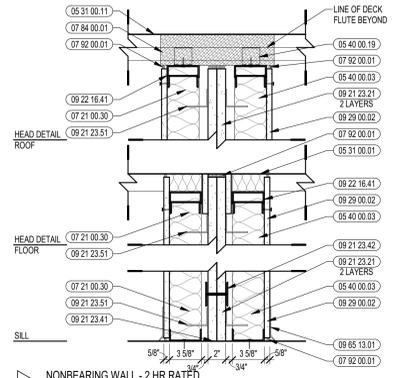
BS NONBEARING WALL - 2 HR RATED
UL DESIGN NO. U347



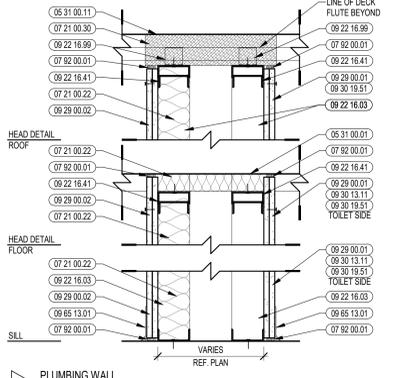
GP PLUMBING WALL
STC 60
- ALL PLUMBING/PIPING CONNECTIONS SHALL BE SECURED EXCLUSIVELY TO THE STUDS ON THE TOILET SIDE OF THE WALL TO PREVENT TRANSMISSION OF STRUCTURE-BORN NOISE TO ADJACENT SPACES
- EACH ROW OF STUDS TO BE FREESTANDING TO PREVENT TRANSMISSION OF NOISE



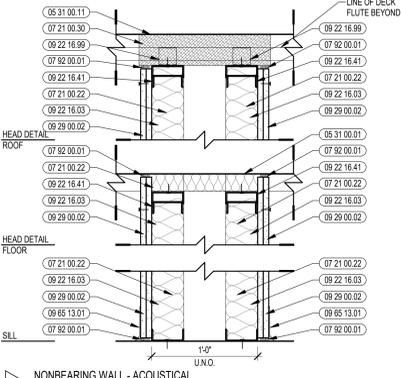
GD NONBEARING WALL - ACOUSTICAL
STC 60
- EACH ROW OF STUDS TO BE FREESTANDING TO PREVENT TRANSMISSION OF NOISE



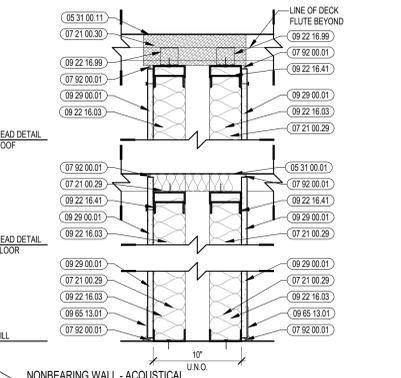
GB NONBEARING WALL - ACOUSTICAL
STC 60
- EACH ROW OF STUDS TO BE FREESTANDING TO PREVENT TRANSMISSION OF NOISE
NOTE: AT CLASSROOM CORRIDORS (CORRIDOR SIDE), ABUSE RESISTANT GYP WILL BE USED FROM ABOVE THE TILE TO 9'-0" A.F.F.



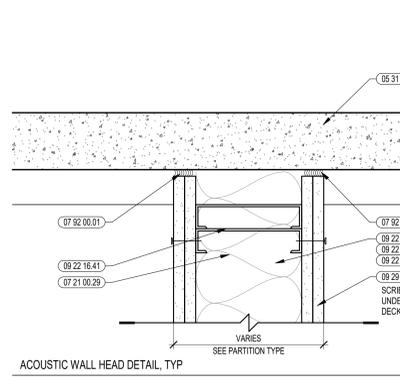
GB NONBEARING WALL - ACOUSTICAL
STC 60
- EACH ROW OF STUDS TO BE FREESTANDING TO PREVENT TRANSMISSION OF NOISE
NOTE: AT CLASSROOM CORRIDORS (CORRIDOR SIDE), ABUSE RESISTANT GYP WILL BE USED FROM ABOVE THE TILE TO 9'-0" A.F.F.



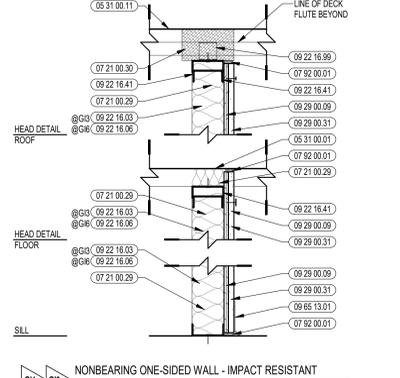
AC ACOUSTIC WALL HEAD DETAIL, TYP
SIM AT NON-ACOUSTIC
SEE PARTITION TYPE



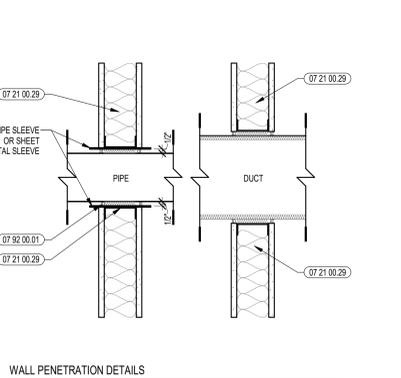
GA NONBEARING ONE-SIDED WALL - IMPACT RESISTANT
AT GYMNASIUM LOCATIONS



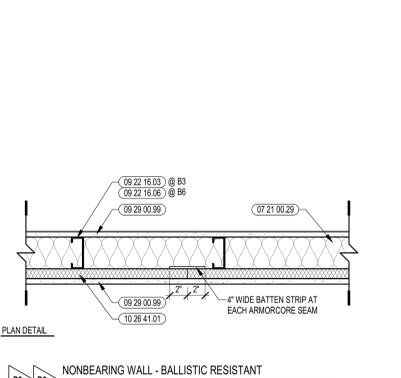
WP WALL PENETRATION DETAILS
COORDINATE WITH WALL TYPE



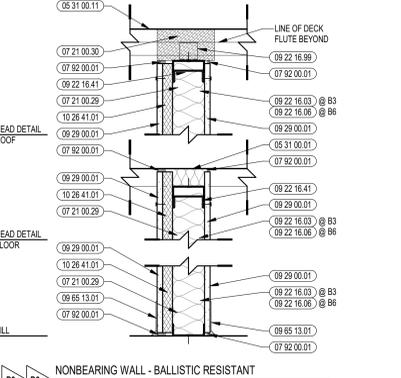
B3 NONBEARING WALL - BALLISTIC RESISTANT
STC 45



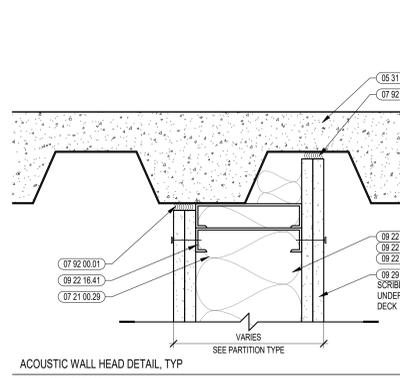
B3 NONBEARING WALL - BALLISTIC RESISTANT
STC 45



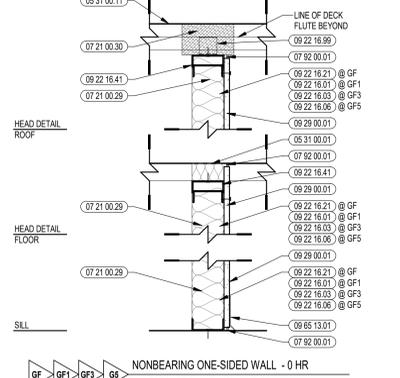
AC ACOUSTIC WALL HEAD DETAIL, TYP
SIM AT NON-ACOUSTIC
SEE PARTITION TYPE



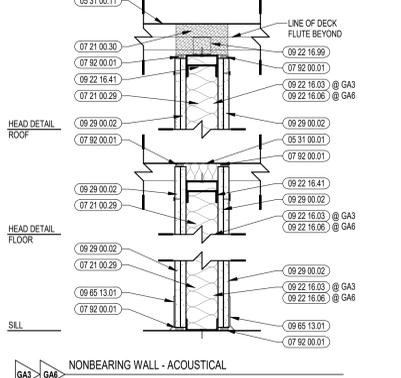
GF NONBEARING ONE-SIDED WALL - 0 HR
STUDS ARE INSTALLED MAXIMUM 12" O.C.



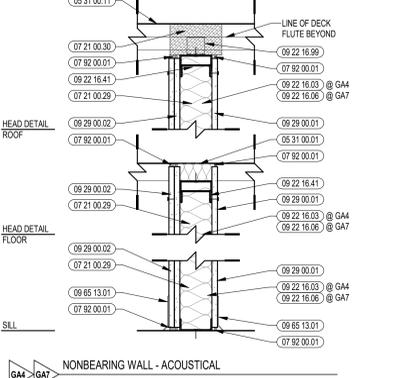GA3 NONBEARING WALL - ACOUSTICAL
STC 50
NOTE 1: STUDS ARE INSTALLED MAXIMUM 12" O.C.
NOTE 2: AT CLASSROOM CORRIDORS (CORRIDOR SIDE), ABUSE RESISTANT GYP WILL BE USED FROM ABOVE THE TILE TO 9'-0" A.F.F.



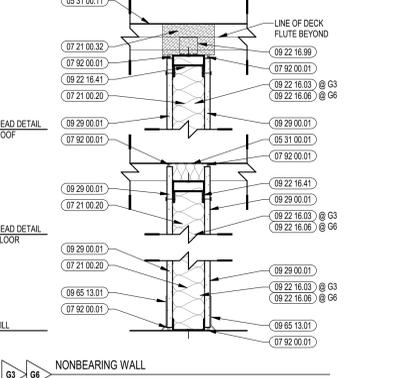GA NONBEARING WALL - ACOUSTICAL
STC 45
NOTE: AT CLASSROOM CORRIDORS (CORRIDOR SIDE), ABUSE RESISTANT GYP WILL BE USED FROM ABOVE THE TILE TO 9'-0" A.F.F.



G3 NONBEARING WALL
STC 45



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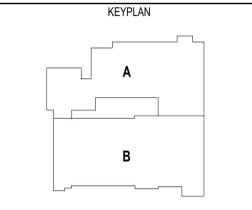
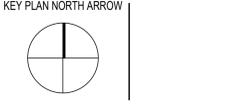


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KEYNOTE LEGEND:



- GENERAL NOTES:**
1. CONTRACTOR SHALL MAINTAIN THE INTEGRITY OF ALL SPRAY FIREPROOFING. PROVIDE PATCHING & TOUCH UP OF SPRAY FIREPROOFING AS REQUIRED. TYP. CLIP FOR WALL FRAMING AT STRUCTURAL STEEL CONDITIONS ROOF DECK, COLUMNS & BRACING KEYNOTED 09 22 16 99 IS REQUIRED TO PROVIDE CLEARANCE FOR SPRAY FIREPROOFING.
 2. SEE MECHANICAL DRAWINGS FOR DAM PARTITION PENETRATIONS BY DUCTS. PROVIDE STEEL LINTELS AS REQUIRED. SEE STRUCTURAL DRAWINGS FOR LINTEL SCHEDULE.
 3. PROVIDE DIAGONAL BRACING @ METAL STUD PARTITIONS ABOVE CEILING AS REQUIRED.
 4. ALL STEEL ANGLE RESTRAINERS & ASSOCIATED STEEL CHANNELS & ANGLES BETWEEN STRUCTURE ARE TO BE FURNISHED BY 05 50.00.
 5. SEE STRUCTURAL DRAWINGS FOR SIZES OF ALL STEEL ANGLE RESTRAINERS AND REQUIREMENTS OF FABRICATION METAL BETWEEN STRUCTURAL MEMBERS.
 6. ALL WALL PENETRATIONS INCLUDING, BUT NOT LIMITED TO PIPING OR DUCTWORK SHOULD BE SEALED. REFER TO WALL PENETRATION DETAILS.
 7. SEE INTERIOR ELEVATIONS & ROOM FINISH SCHEDULE FOR WALL FINISHES OR WALL TILE APPLICATIONS.
 8. ALL INTERIOR WALLS SHALL EXTEND TO UNDERSIDE OF DECK U.O.
 9. DIMENSIONS ARE TO FACE OF FOUNDATION (F.O.F.), FACE OF STUD (F.O.S.) OR FACE OF MASONRY (F.O.M.), UNLESS NOTED AS "HOLD," "CLEAR," "MIN," "MAX," OR OTHERWISE INDICATED. DIMENSION LINES INTERSECTING AT COLUMN LINES WITH T.O.M. MARKS ARE TO BE TAKEN FROM COLUMN CENTER.
 10. ANY METAL STUD PARTITIONS EXCEEDING 14'-0" FLOOR TO FLOOR IN HEIGHT SHALL BE CONSTRUCTED BY COLD-FORMED METAL FRAMING, SECTION 05 40.00, UNLESS NOTED OTHERWISE.
 11. GYPSUM BOARD LAYERS IDENTIFIED ON WALL TYPES SHALL BE REPLACED AS NOTED:
A. ALL TOILET ROOM & LOCKER ROOM LOCATIONS SHALL HAVE MOISTURE RESISTANT GYPSUM BOARD (09 29 00.33).
B. ALL CORRIDORS, STAIRS, VESTIBULES, LOBBIES AND OTHER OPEN CIRCULATION AREAS SHALL HAVE ABUSE RESISTANT GYPSUM BOARD (09 29 00.32) FROM FLOOR LEVEL TO 9'-0" A.F.F.
C. ALL FIRE-RATED WALLS SHALL HAVE TYPE "X" GYPSUM BOARD (09 21 23.31 / 09 21 23.32).
D. ALL GYPSUM BOARD SURFACES WITHIN THE GYMNASIUM SHALL BE IMPACT RESISTANT GYPSUM BOARD (09 29 00.31) FROM FLOOR LEVEL TO 12'-0" A.F.F.

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BID PACKAGE #1



DRAWING NAME:
PARTITION TYPES

DRAWN BY: KRK / CHR
REVIEWED BY: KRK
SCALE: AS INDICATED | DRAWING NUMBER:
JOB NO.: 2202.04
DATE: June 22, 2023
A0.0C

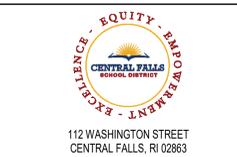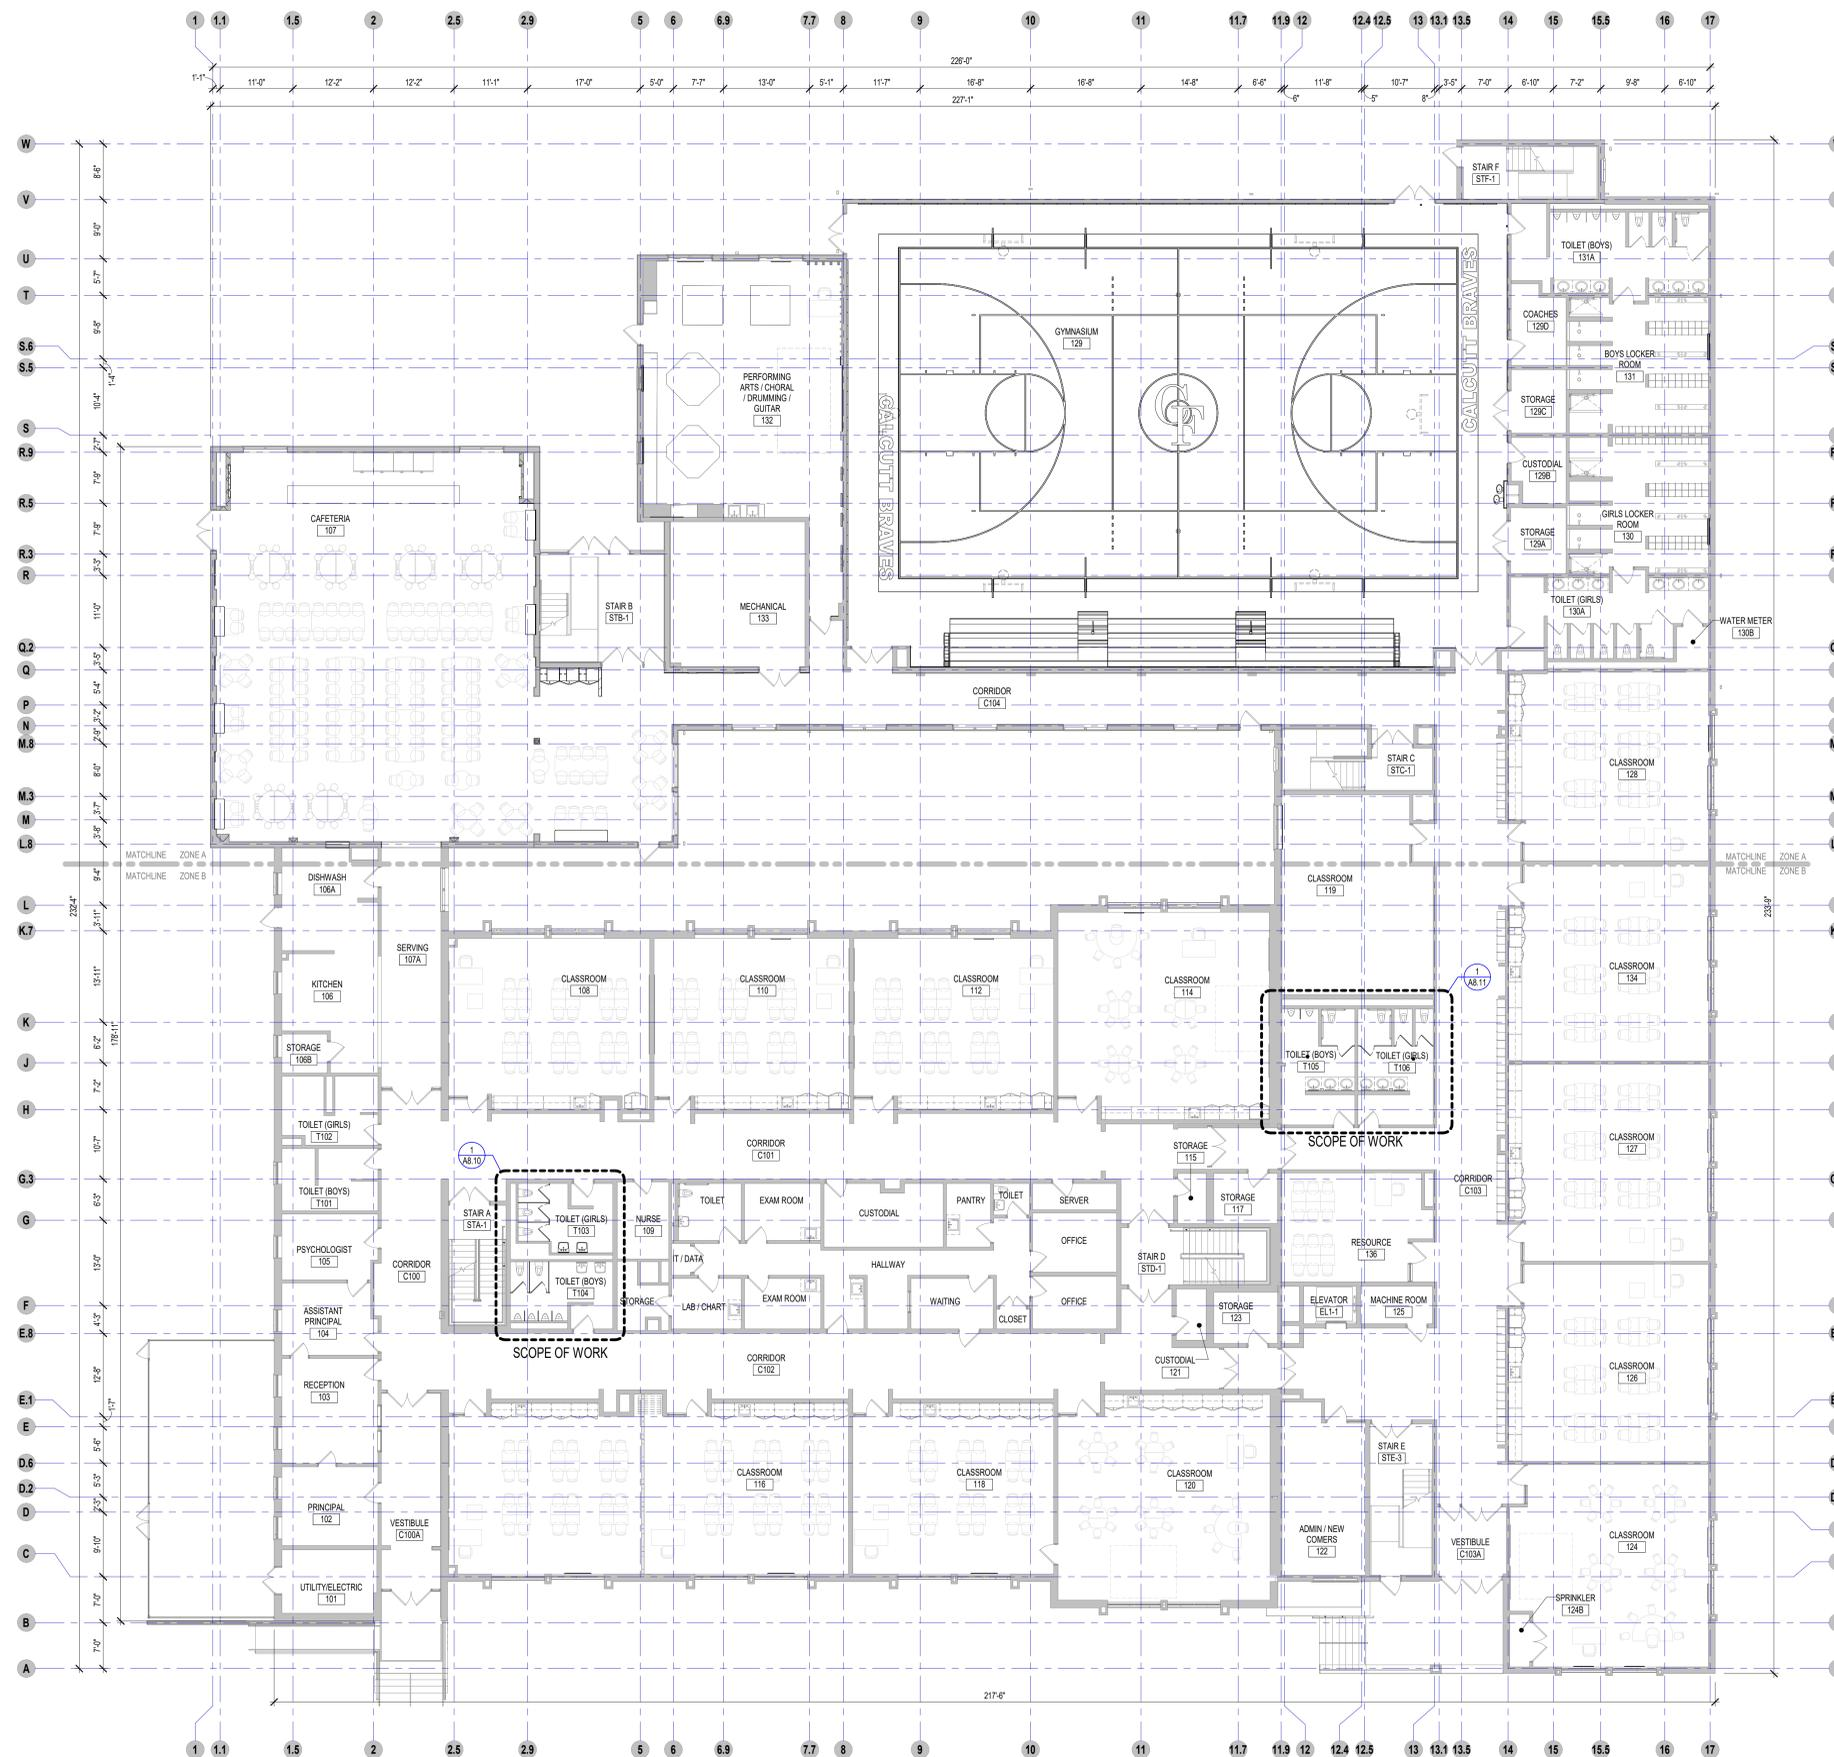



112 WASHINGTON STREET
CENTRAL FALLS, RI 02863

KEYNOTE LEGEND:

GENERAL NOTES:
1. REFER TO ROOM FINISH SCHEDULE ON A7.01 FOR SCOPE OF WORK FOR NEW FINISHES.
2. ALL EXISTING TOILET ROOMS TO RECEIVE NEW PARTITIONS, FINISHES, AND VANITIES.

FLOOR PLAN LEGEND:
— NEW PARTITION
— EXISTING PARTITION TO REMAIN

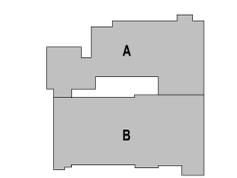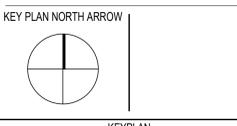**100% CONSTRUCTION DOCUMENTS
BID PACKAGE #1**



DRAWING NAME:
**OVERALL FIRST FLOOR
PLAN**

DRAWN BY: MS
REVIEWED BY: JQ
SCALE: AS INDICATED | DRAWING NUMBER:
JOB NO.: 2202.04
DATE: June 22, 2023 | **A1.11 B1**

1 OVERALL FIRST FLOOR PLAN
3/32" = 1'-0"



112 WASHINGTON STREET
CENTRAL FALLS, RI 02863

KEYNOTE LEGEND:

GENERAL NOTES:

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FLOOR PLAN LEGEND:

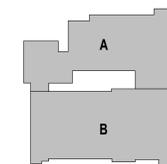
- NEW PARTITION
- EXISTING PARTITION TO REMAIN

**100% CONSTRUCTION DOCUMENTS
BID PACKAGE #1**

KEY PLAN NORTH ARROW



KEYPLAN




DRAWING NAME:

**OVERALL SECOND FLOOR
PLAN**

DRAWN BY: MS

REVIEWED BY: JQ

SCALE: AS INDICATED | DRAWING NUMBER:
JOB NO.: 2202.04 | DATE: June 22, 2023 | A1.12 B1

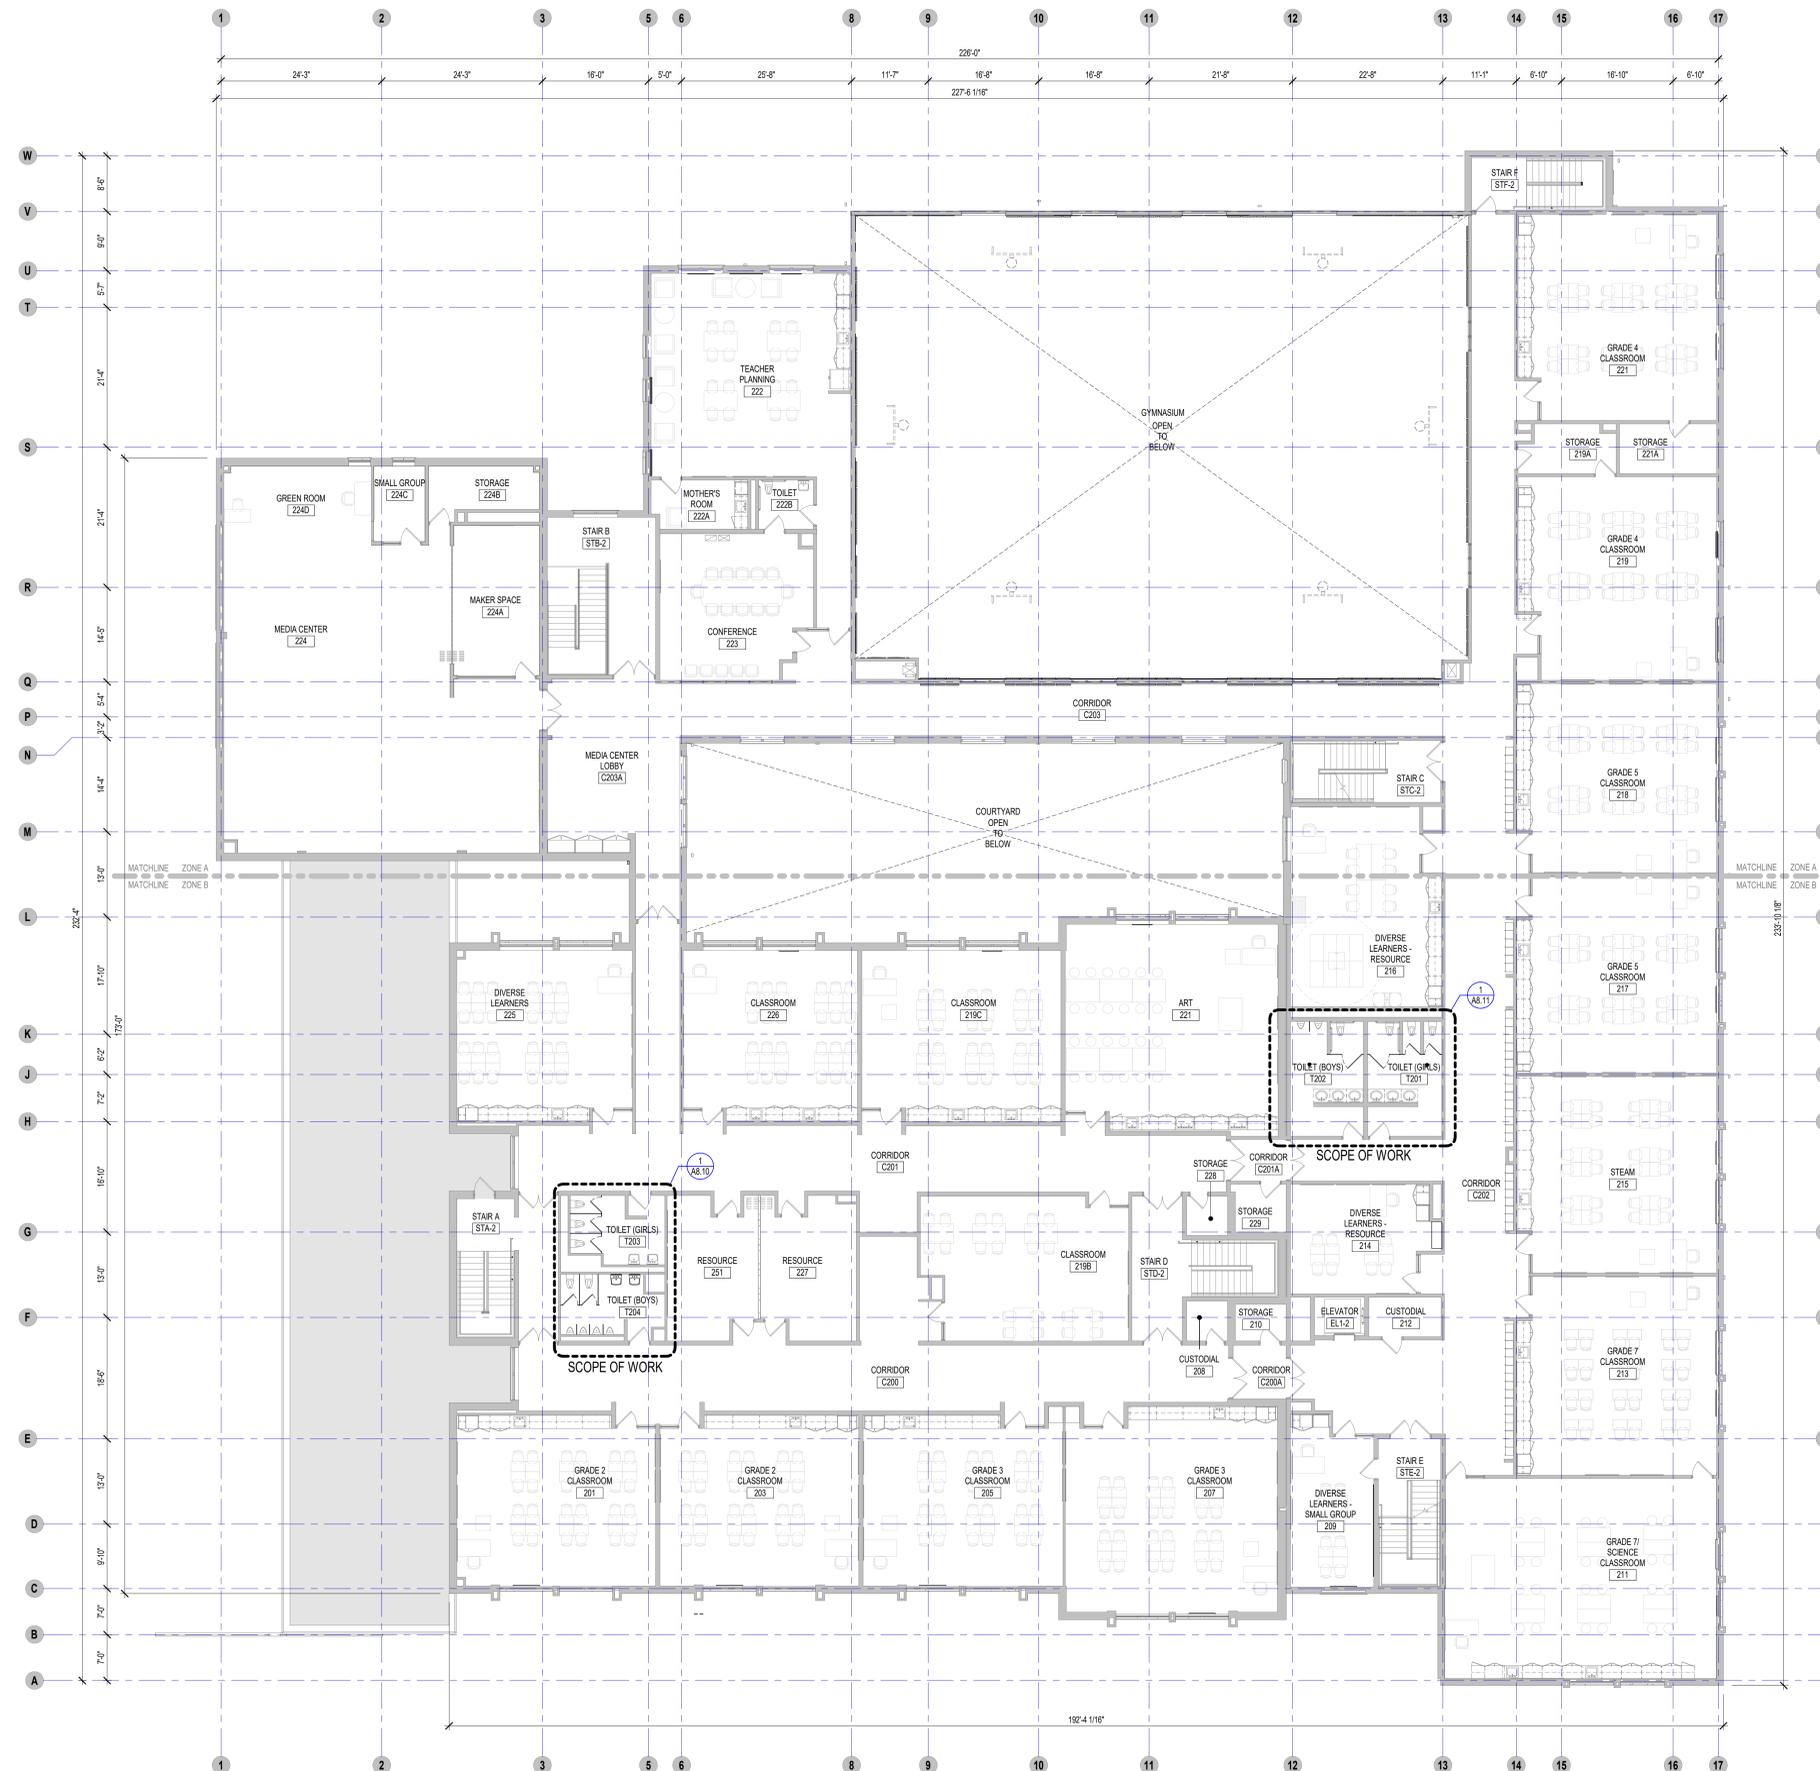

1 OVERALL SECOND FLOOR PLAN
3/32" = 1'-0"



112 WASHINGTON STREET
CENTRAL FALLS, RI 02863

KEYNOTE LEGEND:

GENERAL NOTES:

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- ALL EXISTING TOILET ROOMS TO RECEIVE NEW PARTITIONS, FINISHES, AND VANITIES.

FLOOR PLAN LEGEND:

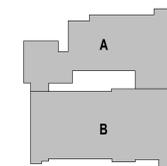
- NEW PARTITION
- EXISTING PARTITION TO REMAIN

**100% CONSTRUCTION DOCUMENTS
BID PACKAGE #1**

KEY PLAN NORTH ARROW



KEYPLAN




DRAWING NAME:

**OVERALL THIRD FLOOR
PLAN**

DRAWN BY: MS

REVIEWED BY: JQ

SCALE: AS INDICATED | DRAWING NUMBER:
JOB NO.: 2202.04
DATE: June 22, 2023 | **A1.13 B1**

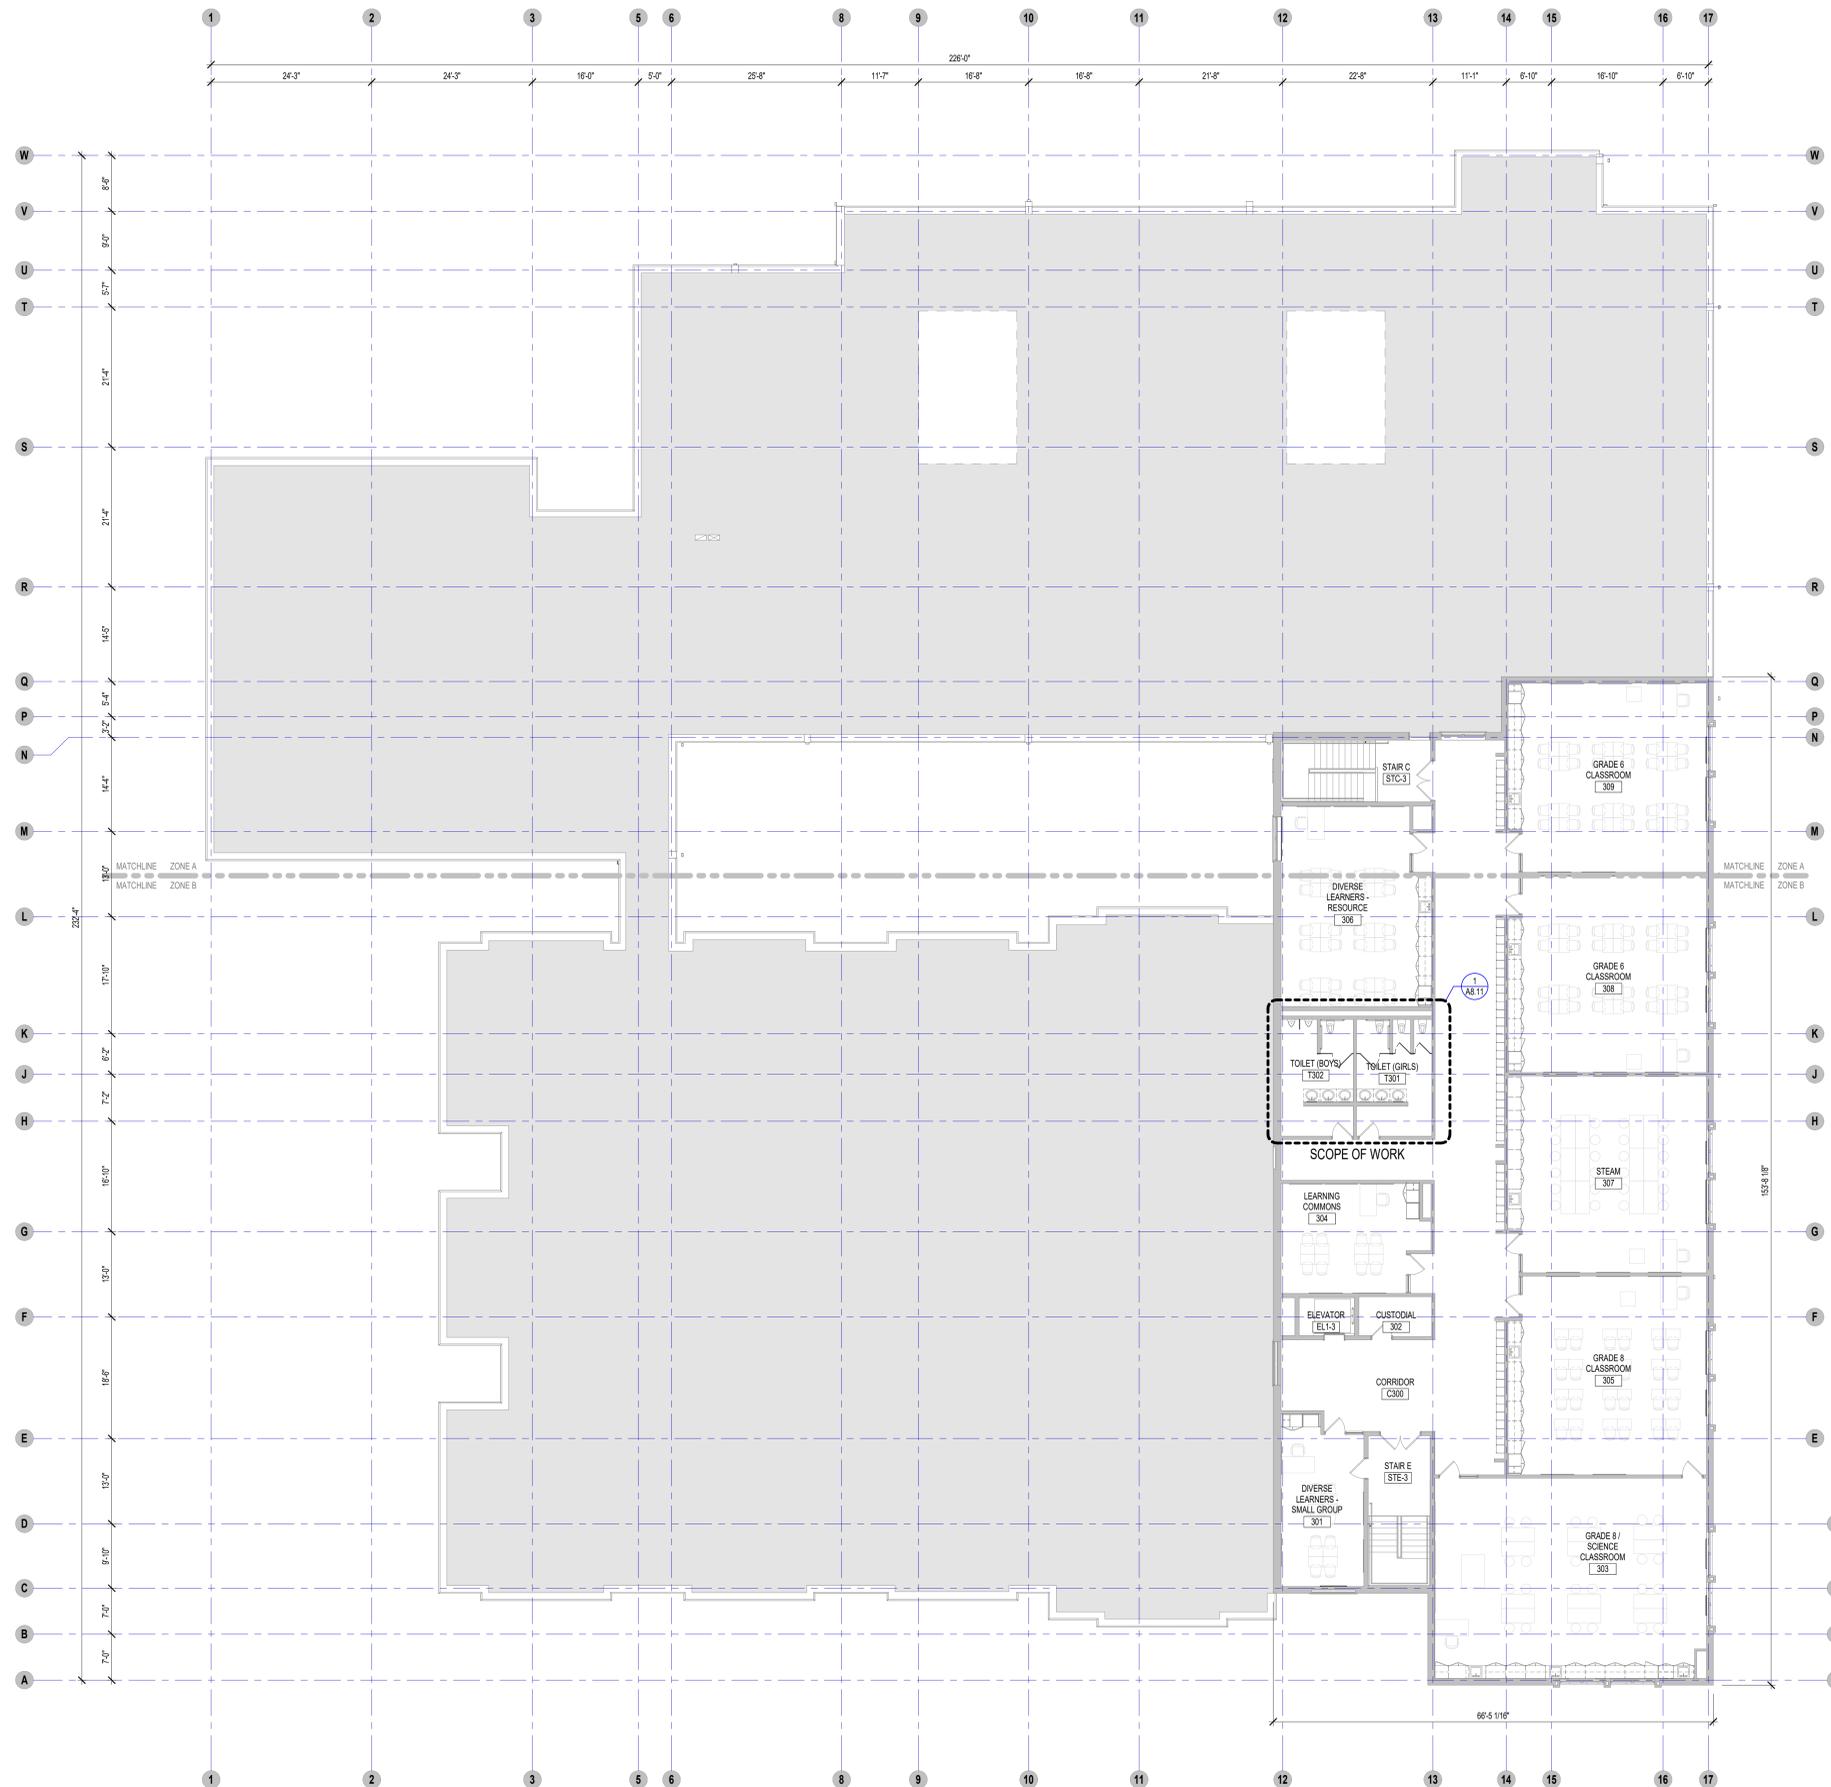

1 OVERALL THIRD FLOOR PLAN
3/2" = 1'-0"



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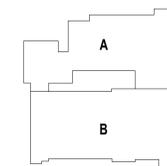
KEYNOTE LEGEND:

**100% CONSTRUCTION DOCUMENTS
BID PACKAGE #1**

KEY PLAN NORTH ARROW



KEYPLAN



DRAWING NAME:

**TOILET ROOMS
ENLARGED RCP**

DRAWN BY: MS


REVIEWED BY: JQ

SCALE: AS INDICATED | DRAWING NUMBER:


JOB NO.: 2202.04

DATE: June 22, 2023

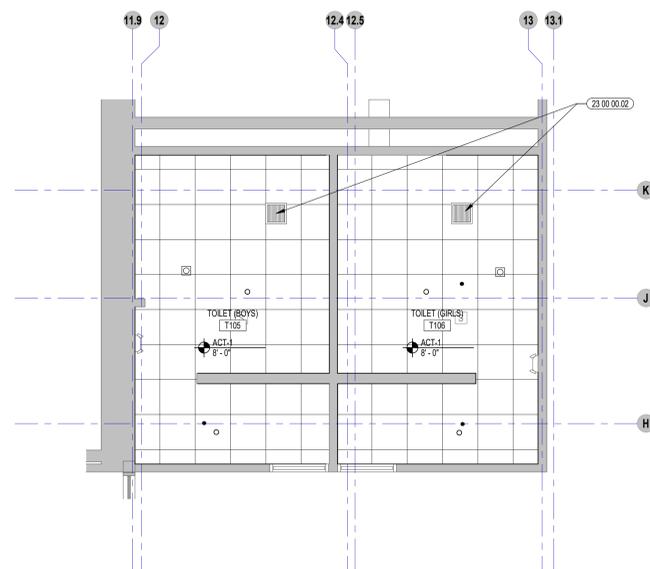A2.21 B1



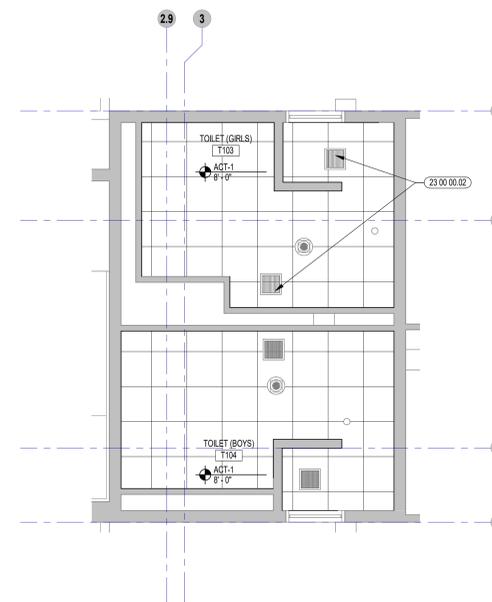2 TYPICAL ENLARGED TOILET ROOM RCP
1/4" = 1'-0"



1 TYPICAL ENLARGED TOILET ROOM RCP
1/4" = 1'-0"

ABBREVIATIONS

ACST	ACOUSTIC	P	PAINTED FINISH
AL	ALUMINUM	PC	POWDER COAT FINISH
ALG	ALUMINUM AND GLASS	PS	POWER SUPPLY REQUIRED FOR DOOR HARDWARE
CLR	CLEAR FINISH	PS1	POWER SUPPLY REQUIRED FOR DOOR OPERATOR ONLY, NO ELECTRIFIED DOOR HARDWARE.
HM	HOLLOW METAL	PVFD	POLYVINYLIDENE FLUORIDE
GL	GLASS	SCW	SOLID CORE WOOD (FLUSH)
MFR	MANUFACTURERS STANDARD	STL	STEEL
OH	OVERHEAD DOOR	TBM1	THERMALLY BROKEN HOLLOW METAL FRAME
OHC	OVERHEAD COILING DOOR		
OHCC	OVERHEAD COILING COUNTER DOOR		
OHS	OVERHEAD COILING GRILLE		

REMARKS: GENERAL NOTES

- A. PROVIDE INSULATION, WEATHERSTRIPPING AND THRESHOLD AT EXTERIOR DOORS.
- B. ALL EXTERIOR HOLLOW METAL DOORS AND FRAMES TO BE GALVANIZED UNLESS NOTED OTHERWISE.
- C. ELECTRICAL (28 00 00) SHALL INSTALL FLEXIBLE CONDUIT IN ALL FRAMES THAT HAVE DOOR POSITION SENSORS AND/OR ACCESS CONTROL DEVICES. COORDINATE CONDUIT REQUIRED & LOCATION WITH ACCESS CONTROL (28 00 00).
- D. ALL EXTERIOR DOOR FRAMES SHALL BE PREPARED TO RECEIVE DOOR POSITION INDICATORS AND/OR ACCESS CONTROL DEVICES AS IDENTIFIED IN THE HARDWARE SET. REFER TO SPECIFICATION SECTIONS: **08 71 00 - DOOR HARDWARE** AND **28 00 00 - ACCESS CONTROL**.
- E. REFER TO FLOOR PLANS FOR DOUBLE EGRESS DOOR FRAMES.
- F. REFER TO MECHANICAL DRAWINGS FOR DOORS THAT REQUIRE UNDERCUTTING.
- G. REFER TO DRAWING A7.02 FOR FLOOR TRANSITION DETAILS. COORDINATE LOCATIONS WITH A7.01 - ROOM FINISH SCHEDULE.
- H. ELECTRICAL & DOOR HARDWARE SHALL COORDINATE WITH HOLLOW METAL AND STOREFRONT FOR ACCESS CONTROL WIRING, REQUIREMENTS, PATHING, AND LOCATION.
- I. FIELD VERIFY ROUGH OPENING PRIOR TO FABRICATION - IF ANY DISCREPANCY BRING TO THE NOTICE OF THE ARCHITECT.

DOOR SCHEDULE

FIRST FLOOR		DOOR					FRAME					HDW SET	FIRE RATING	REMARKS
DOOR #	ROOM NAME	DR SIZE	TYPE	MAT'L	THK	DR FIN	TYPE	MAT'L	FIN.	HEAD	JAMB			
T103-01	TOILET (GIRLS)	3'-0" X 7'-0"	A	SCW		P	EP1.1	HM	P	ETR	ETR	ETR	T-1.0	EXISTING REUSED
T104-01	TOILET (BOYS)	3'-0" X 7'-0"	A	SCW		P	EX	EX	P	ETR	ETR	ETR	T-1.0	EXISTING REUSED
T105-01	TOILET (BOYS)	3'-0" X 7'-0"	A	SCW		P	EP1.1	HM	P	ETR	ETR	ETR	T-1.0	EXISTING REUSED
T106-01	TOILET (GIRLS)	3'-0" X 7'-0"	A	SCW		P	EP1.1	HM	P	ETR	ETR	ETR	T-1.0	EXISTING REUSED

DOOR SCHEDULE

SECOND FLOOR		DOOR					FRAME					HDW SET	FIRE RATING	REMARKS
DOOR #	ROOM NAME	DR SIZE	TYPE	MAT'L	THK	DR FIN	TYPE	MAT'L	FIN.	HEAD	JAMB			
T201-01	TOILET (GIRLS)	3'-0" X 7'-0"	A	SCW		P	F7.1	HM	P	ETR	ETR	ETR	T-1.0	EXISTING REUSED
T202-01	TOILET (BOYS)	3'-0" X 7'-0"	A	SCW		P	F7.1	HM	P	ETR	ETR	ETR	T-1.0	EXISTING REUSED
T203-01	TOILET (GIRLS)	3'-0" X 7'-0"	A	SCW		P	EP1.1	HM	P	ETR	ETR	ETR	T-1.0	EXISTING REUSED
T204-01	TOILET (BOYS)	3'-0" X 7'-0"	A	SCW		P	EP1.1	HM	P	ETR	ETR	ETR	T-1.0	EXISTING REUSED

DOOR SCHEDULE

THIRD FLOOR		DOOR					FRAME					HDW SET	FIRE RATING	REMARKS
DOOR #	ROOM NAME	DR SIZE	TYPE	MAT'L	THK	DR FIN	TYPE	MAT'L	FIN.	HEAD	JAMB			
T301-01	TOILET (GIRLS)	3'-0" X 7'-0"	A	SCW		P	F7.1	HM	P	ETR	ETR	ETR	T-1.0	EXISTING REUSED
T302-01	TOILET (BOYS)	3'-0" X 7'-0"	A	SCW		P	F7.1	HM	P	ETR	ETR	ETR	T-1.0	EXISTING REUSED



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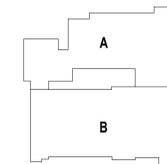
KEYNOTE LEGEND:

**100% CONSTRUCTION DOCUMENTS
BID PACKAGE #1**

KEY PLAN NORTH ARROW



KEYPLAN



DRAWING NAME:

DOOR SCHEDULE

DRAWN BY: MS

REVIEWED BY: JQ

SCALE: AS INDICATED | DRAWING NUMBER:
JOB NO.: 2202.04
DATE: June 22, 2023 **A6.10 B1**

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KEYNOTE LEGEND:

- 07 02 00 01 JOINT SEALANT - TYPE AS REQUIRED
- 09 07 23 01 FLUID APPLIED FLOORING - UCF-1
- 09 07 23 02 FLUID APPLIED FLOORING - UCF-2
- 09 77 33 01 GLASS FIBER REINFORCED PLASTIC PANEL
- 09 91 00 01 PAINT - SEE SCHEDULE
- 10 21 13 11 TOILET PARTITION - PANEL
- 10 21 13 31 URINAL SCREEN

GENERAL NOTES:

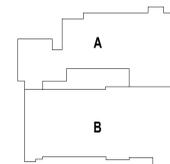
1. REFERENCE SAMPLE WALL TILE PATTERN DRAWINGS ON A1 SERIES FOR ADDITIONAL INFORMATION, TYPICAL.
2. NOT ALL POWER & DATA OUTLET SWITCHING LOCATIONS SHOWN, COORDINATE WITH ELECTRICAL AND TECHNOLOGY DRAWINGS FOR LOCATIONS.

100% CONSTRUCTION DOCUMENTS
BID PACKAGE #1

KEY PLAN NORTH ARROW



KEYPLAN



DRAWING NAME:

ENLARGED TOILET ROOM
PLANS & INTERIOR
ELEVATIONS

DRAWN BY: MS

REVIEWED BY: JQ

SCALE: AS INDICATED | DRAWING NUMBER:

JOB NO.: 2202.04

DATE: June 22, 2023 | A8.10

TOILET ACCESSORY SCHEDULE - GENERAL NOTES


DESCRIPTION	NOTES
SOAP DISPENSERS AND PAPER TOWEL DISPENSERS	ALL SOAP AND PAPER DISPENSERS SHALL BE FURNISHED AND INSTALLED BY OWNER.
TOILET TISSUE DISPENSERS AND SANITARY NAPKIN DISPOSALS	COORDINATE EXACT MOUNTING HEIGHT OF GRAB BARS WITH ARCHITECT. IN FIELD. NOTE: TOILET TISSUE DISPENSERS SHALL BE 15" A.F.F., WITH TOP OF DISPENSER 1 1/2" MIN. BELOW THE SIDE GRAB BAR AND 7" TO 9" FROM THE FRONT EDGE OF THE TOILET TO THE CENTERLINE OF THE DISPENSER.
GRAB BARS	PROVIDE 1 1/2" CLEARANCE FROM WALL WITH CONCEALED MOUNTING.
COAT HOOK	PROVIDE ONE AT EACH TOILET ROOM PARTITION STALL DOOR MOUNTED TO STALL SIDE OF DOOR.
PLUMBING FIXTURES	SEE PLUMBING DRAWINGS FOR PLUMBING FIXTURE LOCATION VERIFICATIONS.
SURFACE MOUNTED TOILET ACCESSORIES	ALL SURFACE MOUNTED TOILET ACCESSORIES SHALL BE FURNISHED AND INSTALLED BY OWNER.

FIXTURE LEGEND


- (WC) WATER CLOSET: ADULT
- (WCA) WATER CLOSET: ADULT ACCESSIBLE
- (WCC) WATER CLOSET: CHILD ACCESSIBLE
- (UR) URINAL: ADULT
- (URA) URINAL: ADULT ACCESSIBLE
- (URC) URINAL: CHILD ACCESSIBLE
- (LAV) LAVATORY: ADULT
- (LAVA) LAVATORY: ADULT ACCESSIBLE
- (LAVC) LAVATORY: CHILD ACCESSIBLE
- (SHRA) SHOWER: ACCESSIBLE
- (SS) SERVICE SINK
- (FD) FLOOR DRAIN
- (HB) HOSE BIB

TOILET ACCESSORY LEGEND: SEE SPEC SECTION 10 28 13

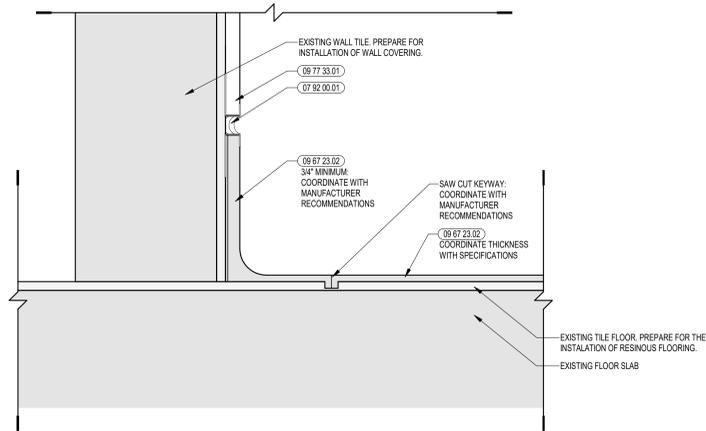
- (G.1) STAINLESS STEEL GRAB BAR (REAR WALL)
- (G.2) STAINLESS STEEL GRAB BAR (SIDE WALL)
- (GC.1) STAINLESS STEEL GRAB BAR: CHLD (REAR WALL)
- (GC.2) STAINLESS STEEL GRAB BAR: CHLD (SIDE WALL)
- (GS1) STAINLESS STEEL GRAB BAR: 2'-4" X 5' HC SHOWER STALL (WALL ADJ. SEAT)
- (GS2) STAINLESS STEEL GRAB BAR: 2'-4" X 5' HC SHOWER STALL (BACK WALL)
- (M) STAINLESS STEEL FRAMED MIRROR
- (MC) STAINLESS STEEL FRAMED MIRROR: CHLD
- (SD) SOAP DISPENSER
- (SDC) SOAP DISPENSER: CHLD
- (PT) SURFACE MOUNTED PAPER TOWEL DISPENSER
- (PTC) SURFACE MOUNTED PAPER TOWEL DISPENSER: CHLD
- (HD) HAND DRYER
- (HDC) HAND DRYER: CHLD
- (TT) TOILET TISSUE DISPENSER
- (TTC) TOILET TISSUE DISPENSER: CHLD
- (CH) STAINLESS STEEL COAT HOOK
- (SN) SANITARY NAPKIN DISPOSAL (TYPE 1: SURFACE MOUNTED)
- (SND) SANITARY NAPKIN DISPOSAL (TYPE 2: PARTITION MOUNTED DUAL ACCESS)
- (MH) MOP HOLDER
- (SH) STAINLESS STEEL SHELF (COORDINATE MOUNTING HEIGHT & LOCATION IN FIELD. MIN 9" AFFI MAX 9'-4" A.F.F.)
- (PS) PADDED SEAT
- (SCR) SHOWER CURTAIN AND ROD (COORDINATE MOUNTING HEIGHT WITH SHOWER CURTAIN LENGTH)



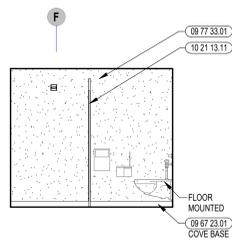
11 RESINOUS FLOORING RADIUS COVE BASE DETAIL
8" = 1'-0"



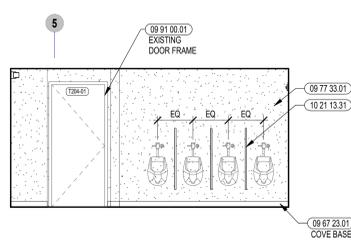
10 TOILET ROOM INTERIOR ELEVATION
1/4" = 1'-0"



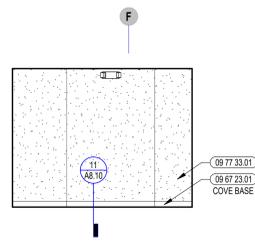
9 TOILET ROOM INTERIOR ELEVATION
1/4" = 1'-0"



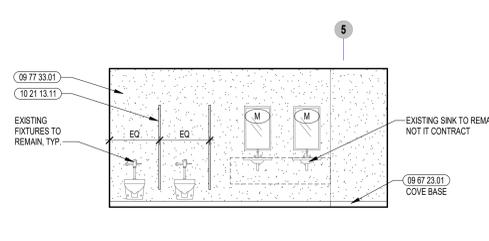
8 TOILET ROOM INTERIOR ELEVATION
1/4" = 1'-0"



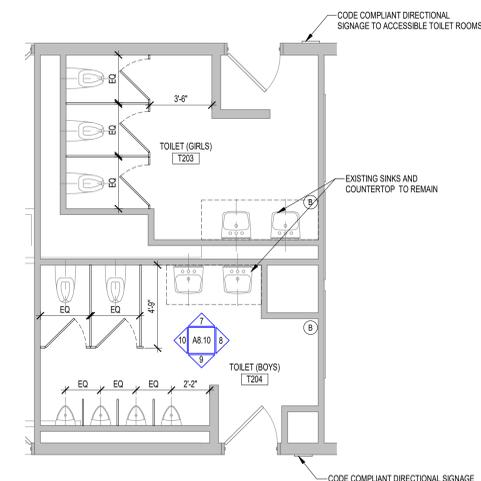
7 TOILET ROOM INTERIOR ELEVATION
1/4" = 1'-0"



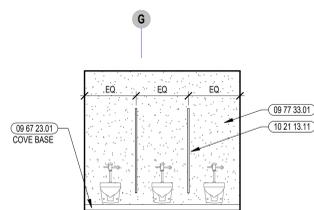
6 TOILET ROOM ENLARGED PLAN
1/4" = 1'-0"



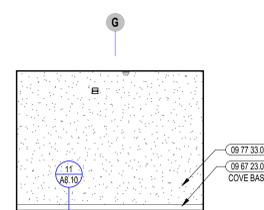
5 TOILET ROOM INTERIOR ELEVATION
1/4" = 1'-0"



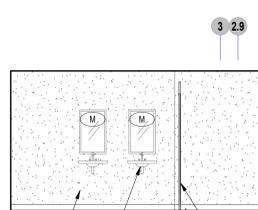
4 TOILET ROOM INTERIOR ELEVATION
1/4" = 1'-0"



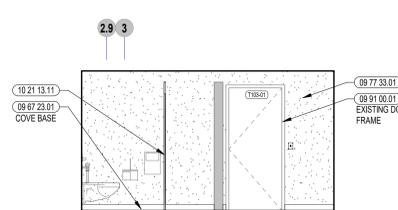3 TOILET ROOM INTERIOR ELEVATION
1/4" = 1'-0"



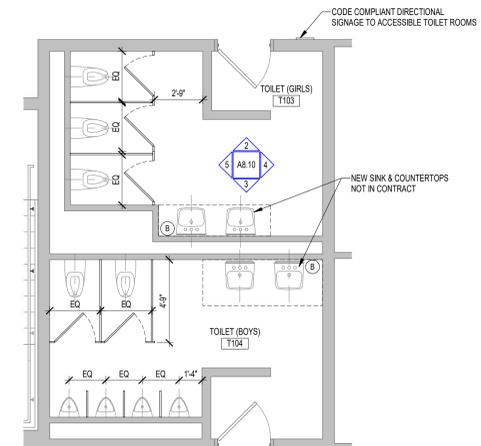2 TOILET ROOM INTERIOR ELEVATION
1/4" = 1'-0"



1 TOILET ROOM ENLARGED PLAN
1/4" = 1'-0"



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CENTRAL FALLS, RI 02863

KEYNOTE LEGEND:

- 09 67 23 01 FLUID APPLIED FLOORING - UCF-1
- 09 67 23 02 FLUID APPLIED FLOORING - UCF-2
- 09 91 00 01 PAINT - SEE SCHEDULE
- 10 21 13 01 TOILET COMPARTMENT

GENERAL NOTES:


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100% CONSTRUCTION DOCUMENTS
BID PACKAGE #1

KEY PLAN NORTH ARROW



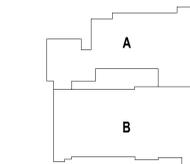KEYPLAN



DRAWING NAME:

ENLARGED TOILET ROOM
PLANS & INTERIOR
ELEVATIONS

DRAWN BY: MS

REVIEWED BY: JQ

SCALE: AS INDICATED | DRAWING NUMBER:
JOB NO.: 2202.04 | A8.11
DATE: June 22, 2023

TOILET ACCESSORY SCHEDULE - GENERAL NOTES

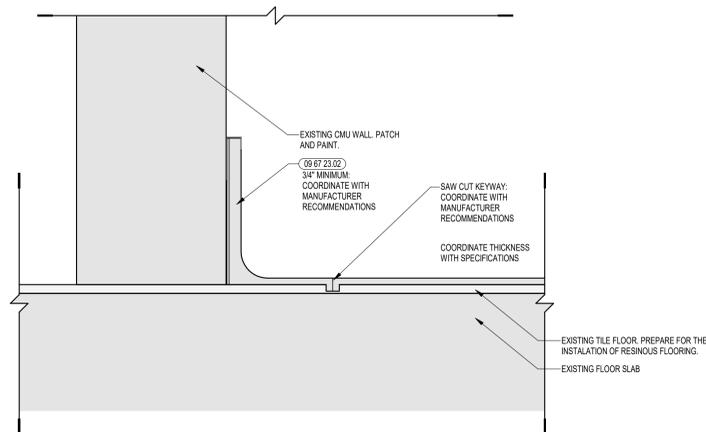
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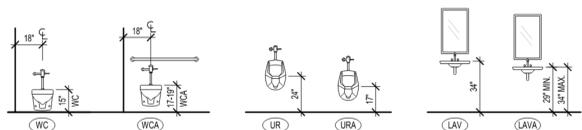
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- (URA) URINAL: ADULT ACCESSIBLE
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- (LAVA) LAVATORY: ADULT ACCESSIBLE
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- (SHRA) SHOWER: ACCESSIBLE
- (SS) SERVICE SINK
- (FD) FLOOR DRAIN
- (HB) HOSE BIB

TOILET ACCESSORY LEGEND: SEE SPEC SECTION 10 28 13

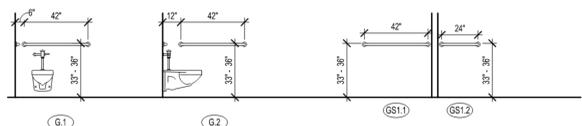
- (G.1) STAINLESS STEEL GRAB BAR (REAR WALL)
- (G.2) STAINLESS STEEL GRAB BAR (SIDE WALL)
- (GC.1) STAINLESS STEEL GRAB BAR: CHILD (REAR WALL)
- (GC.2) STAINLESS STEEL GRAB BAR: CHILD (SIDE WALL)
- (GS1) STAINLESS STEEL GRAB BAR: 2'-4" X 5' HC SHOWER STALL (WALL ADJ. SEAT)
- (GS2) STAINLESS STEEL GRAB BAR: 2'-4" X 5' HC SHOWER STALL (BACK WALL)
- (M) MOP HOLDER
- (MC) STAINLESS STEEL FRAMED MIRROR: CHILD
- (SD) SOAP DISPENSER
- (SDC) SOAP DISPENSER: CHILD
- (PT) SURFACE MOUNTED PAPER TOWEL DISPENSER
- (PTC) SURFACE MOUNTED PAPER TOWEL DISPENSER: CHILD
- (HD) HAND DRYER
- (HDC) HAND DRYER: CHILD
- (TT) TOILET TISSUE DISPENSER
- (TTC) TOILET TISSUE DISPENSER: CHILD
- (CH) STAINLESS STEEL COAT HOOK
- (SN1) SANITARY NAPKIN DISPOSAL (TYPE 1: SURFACE MOUNTED)
- (SN2) SANITARY NAPKIN DISPOSAL (TYPE 2: PARTITION MOUNTED DUAL ACCESS)
- (MS) MOP HOLDER
- (SH) STAINLESS STEEL SHELF (COORDINATE MOUNTING HEIGHT & LOCATION IN FIELD. MIN: 0" AFF; MAX: 3'-0" A.F.F.)
- (PS) PADDED SEAT
- (SCR) SHOWER CURTAIN AND ROD (COORDINATE MOUNTING HEIGHT WITH SHOWER CURTAIN LENGTH)




9 RESINOUS FLOORING RADIUS COVE BASE DETAIL
8" = 1'-0"




TYPICAL FIXTURE MOUNTING HEIGHTS




TYPICAL GRAB BAR MOUNTING HEIGHTS

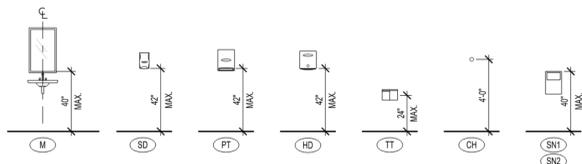


TYPICAL ACCESSORY MOUNTING HEIGHTS

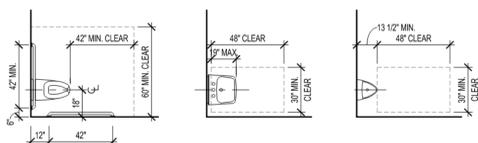


ACCESSIBLE BATHROOM FIXTURE CLEARANCES

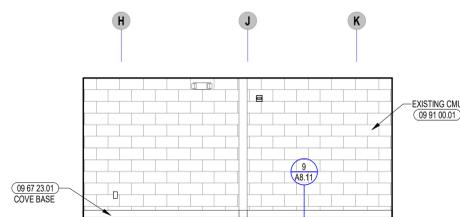

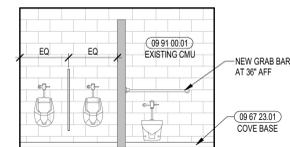
8 TOILET ROOM INTERIOR ELEVATION
1/4" = 1'-0"



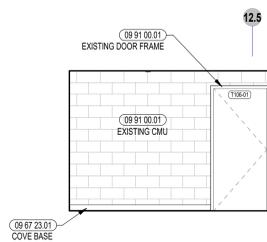
7 TOILET ROOM INTERIOR ELEVATION
1/4" = 1'-0"



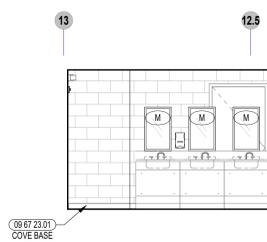
6 TOILET ROOM INTERIOR ELEVATION
1/4" = 1'-0"



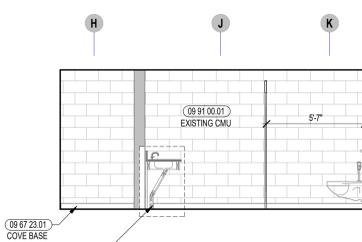
5 TOILET ROOM INTERIOR ELEVATION
1/4" = 1'-0"



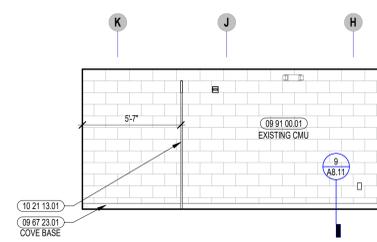
4 TOILET ROOM INTERIOR ELEVATION
1/4" = 1'-0"



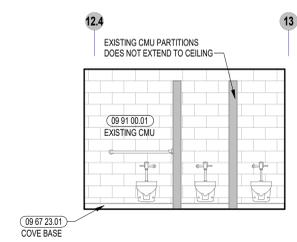3 TOILET ROOM INTERIOR ELEVATION
1/4" = 1'-0"



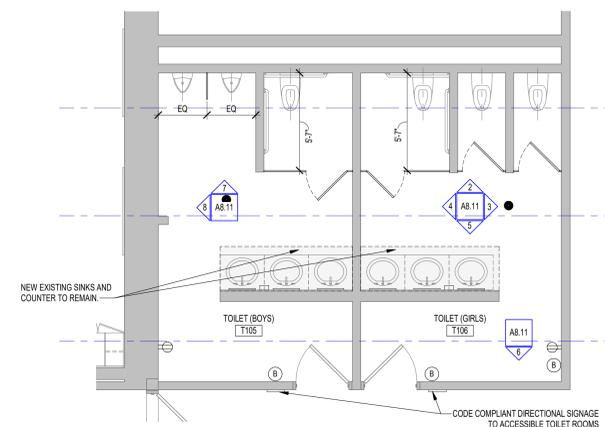2 TOILET ROOM INTERIOR ELEVATION
1/4" = 1'-0"



1 TOILET ROOM ENLARGED PLAN
1/4" = 1'-0"

FIRE PROTECTION LEGEND

GENERAL	DEVICES	ABBREVIATIONS																																																														
		<p>ABBREVIATIONS</p> <table style="width: 100%; border: none;"> <tr> <td style="width: 50%;">AFF ABOVE FINISH FLOOR</td> <td style="width: 50%;">GWB GYPSUM WALL BOARD</td> </tr> <tr> <td>AFG ABOVE FINISH GRADE</td> <td>HMR HYDRAULICALLY MOST REMOTE</td> </tr> <tr> <td>AP ACCESS PANEL</td> <td>INV INVERT</td> </tr> <tr> <td>AC ABOVE CEILING</td> <td>JP JOCKEY PUMP</td> </tr> <tr> <td>ARCH ARCHITECT</td> <td>KW KILOWATTS</td> </tr> <tr> <td>BLDG BUILDING</td> <td>MAX MAXIMUM</td> </tr> <tr> <td>BOP BOTTOM OF PIPE</td> <td>MECH MECHANICAL</td> </tr> <tr> <td>BOR BOTTOM OF RISER</td> <td>MIN MINIMUM</td> </tr> <tr> <td>CI CAST IRON</td> <td>MISC MISCELLANEOUS</td> </tr> <tr> <td>CLNG CEILING</td> <td>N/A NOT APPLICABLE</td> </tr> <tr> <td>CLDI CEMENT LINED DUCTILE IRON</td> <td>NC NORMALLY CLOSED</td> </tr> <tr> <td>CP CHROME PLATED</td> <td>NO NORMALLY OPEN</td> </tr> <tr> <td>CNR CONCENTRIC REDUCER</td> <td>NTS NOT TO SCALE</td> </tr> <tr> <td>CONT CONTINUATION</td> <td>NIC NOT IN CONTRACT</td> </tr> <tr> <td>DA DIAMETER</td> <td>PA PRE-ACTION</td> </tr> <tr> <td>DWG DRAWING</td> <td>PV POST INDICATING VALVE</td> </tr> <tr> <td>EA EACH</td> <td>POS PROVIDED UNDER OTHER SECTION</td> </tr> <tr> <td>ECC ECCENTRIC REDUCER</td> <td>SCH SCHEDULE</td> </tr> <tr> <td>EL OR ELEV. ELEVATION</td> <td>SC SITE CONTACTOR</td> </tr> <tr> <td>ELEC ELECTRIC</td> <td>SPEC SPECIFICATION</td> </tr> <tr> <td>EMER EMERGENCY</td> <td>ST. ST. STAINLESS STEEL</td> </tr> <tr> <td>ETBR EXISTING TO BE REMOVED</td> <td>STD STANDARD</td> </tr> <tr> <td>ETR EXISTING TO REMAIN</td> <td>STL STEEL</td> </tr> <tr> <td>FFE FINISH FLOOR ELEVATION</td> <td>TH TEST HEADER</td> </tr> <tr> <td>FLR FLOOR</td> <td>TOR TOP OF RISER</td> </tr> <tr> <td>FT FOOT</td> <td>TOS TOP OF STAIRS</td> </tr> <tr> <td>FURN FURNISHED</td> <td>TYP TYPICAL</td> </tr> <tr> <td>GALV GALVANIZED</td> <td>UNO UNLESS NOTED OTHERWISE</td> </tr> <tr> <td>GC GENERAL CONTRACTOR</td> <td>VIV VALVE IN VERTICAL</td> </tr> <tr> <td>GPH GALLONS PER HOUR</td> <td>W WITH</td> </tr> <tr> <td>GPM GALLONS PER MINUTE</td> <td>W/O WITHOUT</td> </tr> </table>	AFF ABOVE FINISH FLOOR	GWB GYPSUM WALL BOARD	AFG ABOVE FINISH GRADE	HMR HYDRAULICALLY MOST REMOTE	AP ACCESS PANEL	INV INVERT	AC ABOVE CEILING	JP JOCKEY PUMP	ARCH ARCHITECT	KW KILOWATTS	BLDG BUILDING	MAX MAXIMUM	BOP BOTTOM OF PIPE	MECH MECHANICAL	BOR BOTTOM OF RISER	MIN MINIMUM	CI CAST IRON	MISC MISCELLANEOUS	CLNG CEILING	N/A NOT APPLICABLE	CLDI CEMENT LINED DUCTILE IRON	NC NORMALLY CLOSED	CP CHROME PLATED	NO NORMALLY OPEN	CNR CONCENTRIC REDUCER	NTS NOT TO SCALE	CONT CONTINUATION	NIC NOT IN CONTRACT	DA DIAMETER	PA PRE-ACTION	DWG DRAWING	PV POST INDICATING VALVE	EA EACH	POS PROVIDED UNDER OTHER SECTION	ECC ECCENTRIC REDUCER	SCH SCHEDULE	EL OR ELEV. ELEVATION	SC SITE CONTACTOR	ELEC ELECTRIC	SPEC SPECIFICATION	EMER EMERGENCY	ST. ST. STAINLESS STEEL	ETBR EXISTING TO BE REMOVED	STD STANDARD	ETR EXISTING TO REMAIN	STL STEEL	FFE FINISH FLOOR ELEVATION	TH TEST HEADER	FLR FLOOR	TOR TOP OF RISER	FT FOOT	TOS TOP OF STAIRS	FURN FURNISHED	TYP TYPICAL	GALV GALVANIZED	UNO UNLESS NOTED OTHERWISE	GC GENERAL CONTRACTOR	VIV VALVE IN VERTICAL	GPH GALLONS PER HOUR	W WITH	GPM GALLONS PER MINUTE	W/O WITHOUT
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<p>SYSTEMS</p> <table style="width: 100%; border: none;"> <tr> <td style="width: 50%;">F BURIED FIRE SERVICE</td> <td style="width: 50%;">FIRE SERVICE, MAIN DISTRIBUTION AND/OR STANDPIPE FEED</td> </tr> <tr> <td>F(DRY) DRY DISTRIBUTION AND/OR STANDPIPE FEED</td> <td>FDC FIRE DEPARTMENT INLET CONNECTION</td> </tr> <tr> <td>SPR WET SPRINKLER</td> <td>SPR(PA) PREACTION SPRINKLER</td> </tr> <tr> <td>SPR(DRY) DRY SPRINKLER</td> <td>SPD SPRINKLER DRAIN</td> </tr> <tr> <td>TH (FIRE PUMP) TEST HEADER</td> <td></td> </tr> </table>	F BURIED FIRE SERVICE	FIRE SERVICE, MAIN DISTRIBUTION AND/OR STANDPIPE FEED	F(DRY) DRY DISTRIBUTION AND/OR STANDPIPE FEED	FDC FIRE DEPARTMENT INLET CONNECTION	SPR WET SPRINKLER	SPR(PA) PREACTION SPRINKLER	SPR(DRY) DRY SPRINKLER	SPD SPRINKLER DRAIN	TH (FIRE PUMP) TEST HEADER		<p>VALVES</p> <table style="width: 100%; border: none;"> <tr> <td style="width: 50%;">BV BALL VALVE</td> <td style="width: 50%;">CV CHECK VALVE</td> </tr> <tr> <td>DCVA DOUBLE CHECK VALVE ASSEMBLY</td> <td>GV GATE VALVE</td> </tr> <tr> <td>FDC FIRE DEPARTMENT CONNECTION SIEMENSE</td> <td>FDC FIRE DEPARTMENT CONNECTION STORZ</td> </tr> <tr> <td>FVC FIRE DEPARTMENT VALVE</td> <td>FHC FIRE HOSE CABINET</td> </tr> <tr> <td>FCV FLOOR CONTROL VALVE ASSEMBLY</td> <td>OS&Y SUPERVISED OUTSIDE SCREW & YOLK VALVE STRAINER</td> </tr> <tr> <td>VIV VALVE IN VERTICAL</td> <td></td> </tr> </table>	BV BALL VALVE	CV CHECK VALVE	DCVA DOUBLE CHECK VALVE ASSEMBLY	GV GATE VALVE	FDC FIRE DEPARTMENT CONNECTION SIEMENSE	FDC FIRE DEPARTMENT CONNECTION STORZ	FVC FIRE DEPARTMENT VALVE	FHC FIRE HOSE CABINET	FCV FLOOR CONTROL VALVE ASSEMBLY	OS&Y SUPERVISED OUTSIDE SCREW & YOLK VALVE STRAINER	VIV VALVE IN VERTICAL																																										
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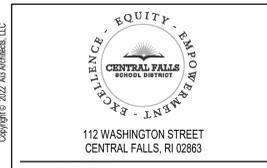
REMARKS:
 ① SYMBOLS WITHIN LEGEND FOR REFERENCE ONLY. ALL SYMBOLS SHOWN MAY NOT BE APPLICABLE TO PROJECT.

TYPICAL NOTES (APPLICABLE TO ALL DRAWINGS)

- ALL SPRINKLER HEADS IN 2x4' CEILING TILES TO BE ON CENTERLINE OF 2'-0" DIMENSION AND TO BE AT 1'-0" OFF EITHER END OR IN THE EXACT CENTER OF THE 4'-0" DIMENSION.
- ALL SPRINKLER HEADS IN 2x2' CEILING TILES TO BE CENTERED IN THE EXACT CENTER OF THE TILE.
- ALL PIPING SHALL RUN HIGH THRU THE STRUCTURE WITH OFFSETS UP OR DOWN, AS REQUIRED.

MINIMUM DESIGN CRITERIA

- ALL CLASSROOMS, HALLWAYS, OFFICES, GYMNASIUM, ETC. SHALL BE PROTECTED WITH A LIGHT HAZARD, WET SYSTEM EMPLOYING PENDANT HEADS DESIGNED TO DELIVER A MINIMUM DENSITY OF 0.10 GPM/SQ. FT. OVER THE MOST HYDRAULICALLY REMOTE 1,500 SQ. FT.



KEYNOTE LEGEND:

100% CONSTRUCTION DOCUMENTS
 BID PACKAGE #1

KEY PLAN NORTH ARROW

KEYPLAN

DRAWING NAME:
FIRE PROTECTION LEGEND & GENERAL NOTES

DRAWN BY: SPD
 REVIEWED BY: AMD

SCALE: AS NOTED | DRAWING NUMBER:
 JOB NO.: 2202.04
 DATE: June 22, 2023 | **FP0.01 B1**



112 WASHINGTON STREET
CENTRAL FALLS, RI 02863

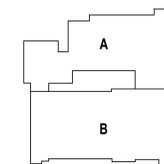
KEYNOTE LEGEND:

100% CONSTRUCTION DOCUMENTS
BID PACKAGE #1

KEY PLAN NORTH ARROW



KEYPLAN



DRAWING NAME:

**FIRE PROTECTION
ENLARGED TOILET PLANS**

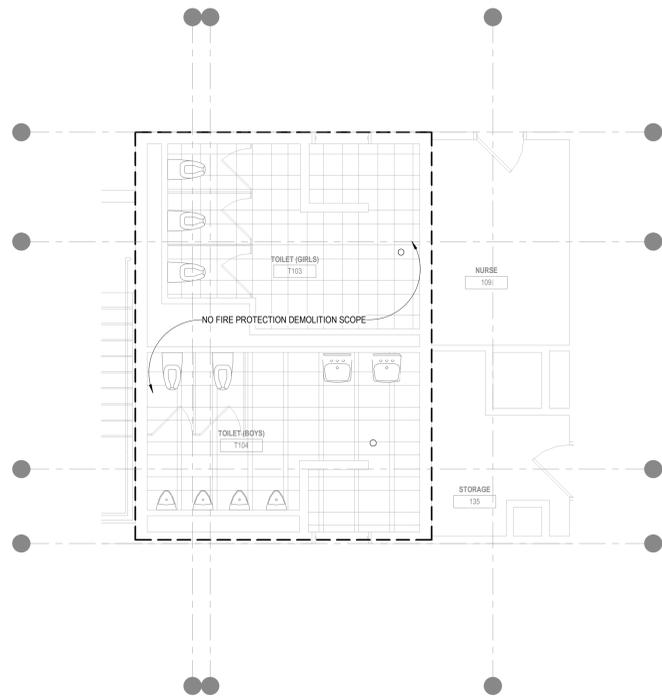
DRAWN BY: SPD

REVIEWED BY: AMD

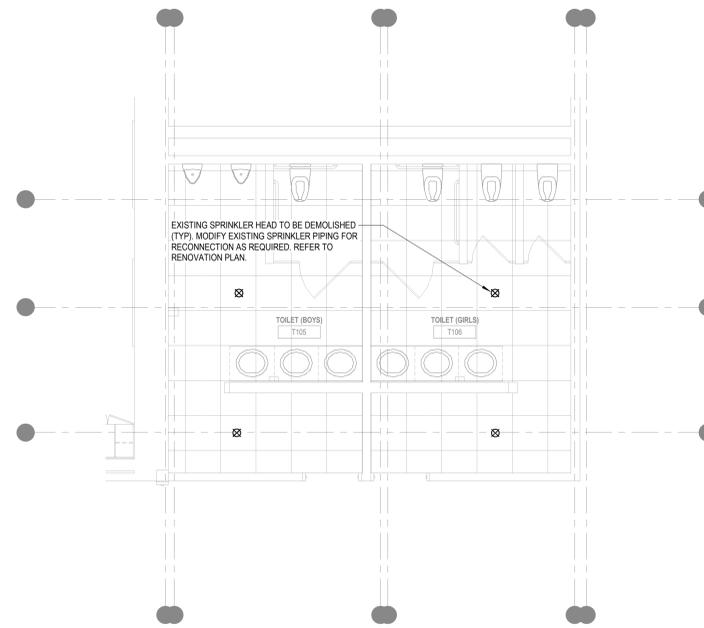
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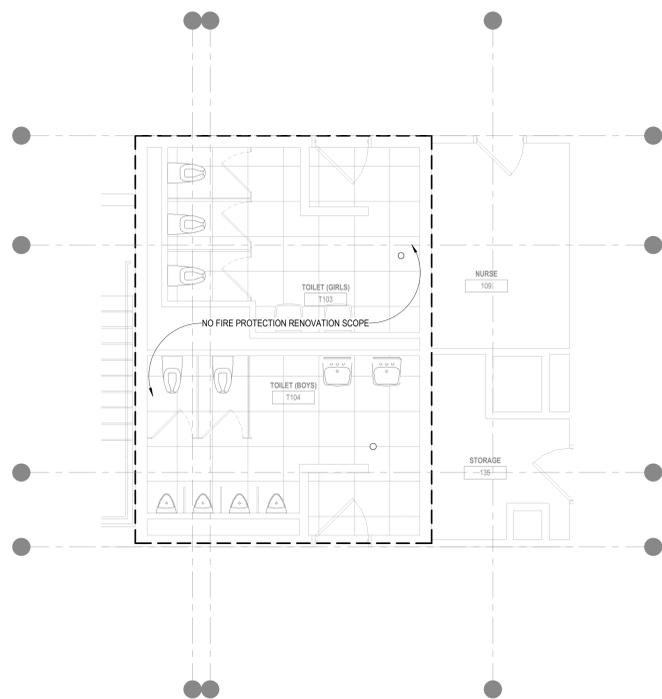
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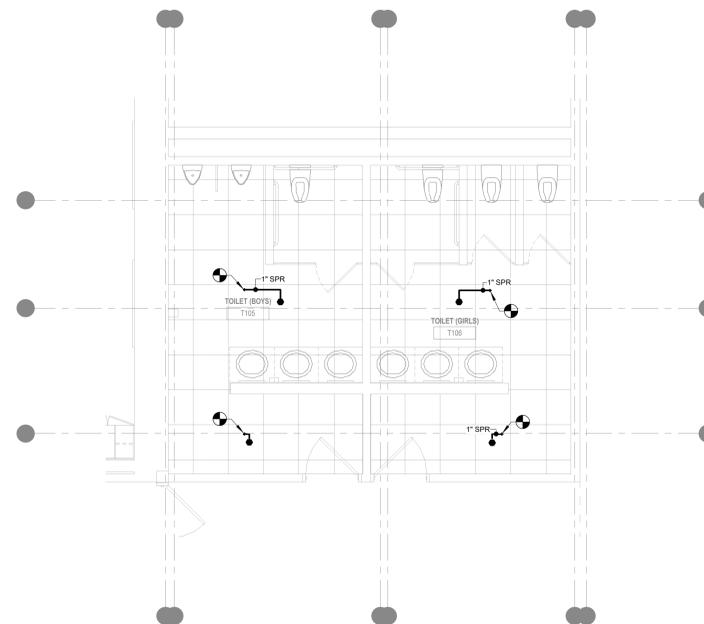
1 ENLARGED DEMO TOILET FIRE PLAN - T103 & T104
1/4" = 1'-0"




2 ENLARGED DEMO TOILET FIRE PLAN - T105 & T106
1/4" = 1'-0"



3 ENLARGED TOILET FIRE PLAN - T103 & T104
1/4" = 1'-0"



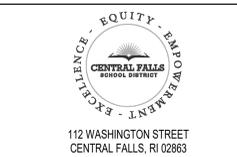4 ENLARGED TOILET FIRE PLAN - T105 & T106
1/4" = 1'-0"




KEYNOTE LEGEND:

100% CONSTRUCTION DOCUMENTS
BID PACKAGE #1

KEY PLAN NORTH ARROW



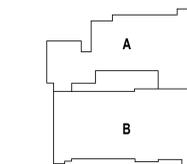KEYPLAN



DRAWING NAME:

FIRE PROTECTION ENLARGED TOILET PLANS

DRAWN BY: SPD

REVIEWED BY: AMD


SCALE: AS NOTED | DRAWING NUMBER:

JOB NO.: 2202.04


DATE: June 22, 2023

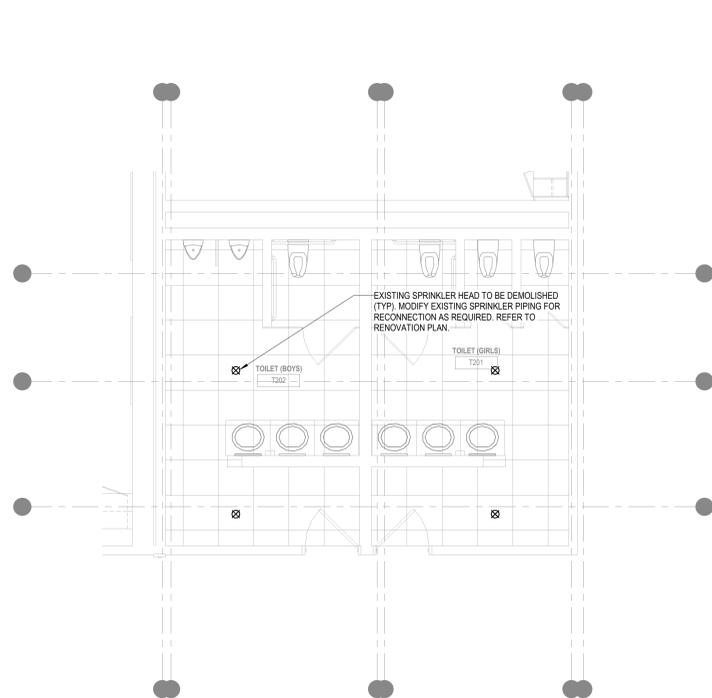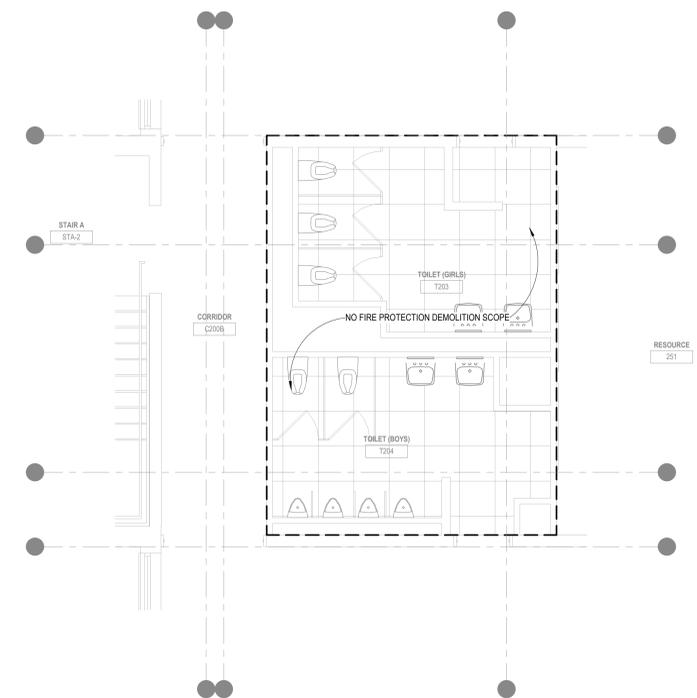FP3.02 B1

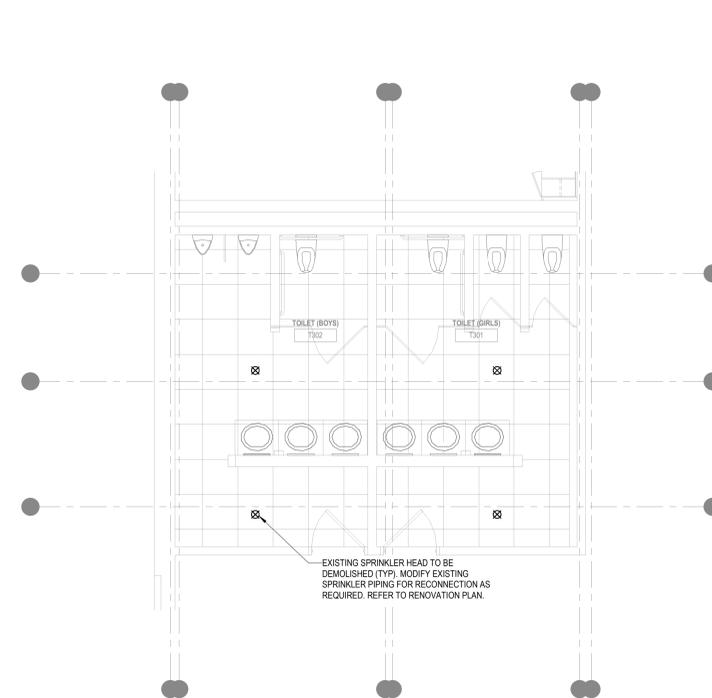
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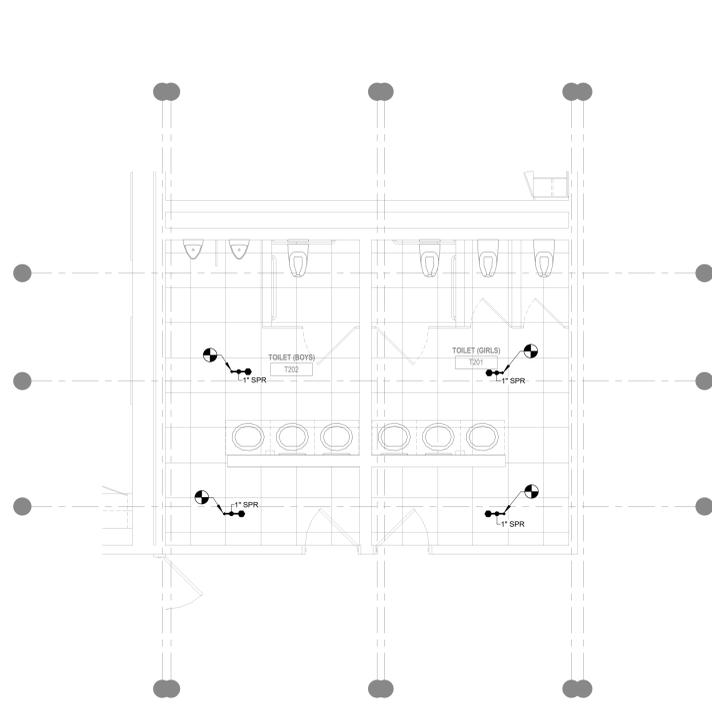
1 ENLARGED DEMO TOILET FIRE PLAN - T201 & T202
1/4" = 1'-0"




2 ENLARGED DEMO TOILET FIRE PLAN - T203 & T204
1/4" = 1'-0"




3 ENLARGED DEMO TOILET FIRE PLAN - T301 & T302
1/4" = 1'-0"



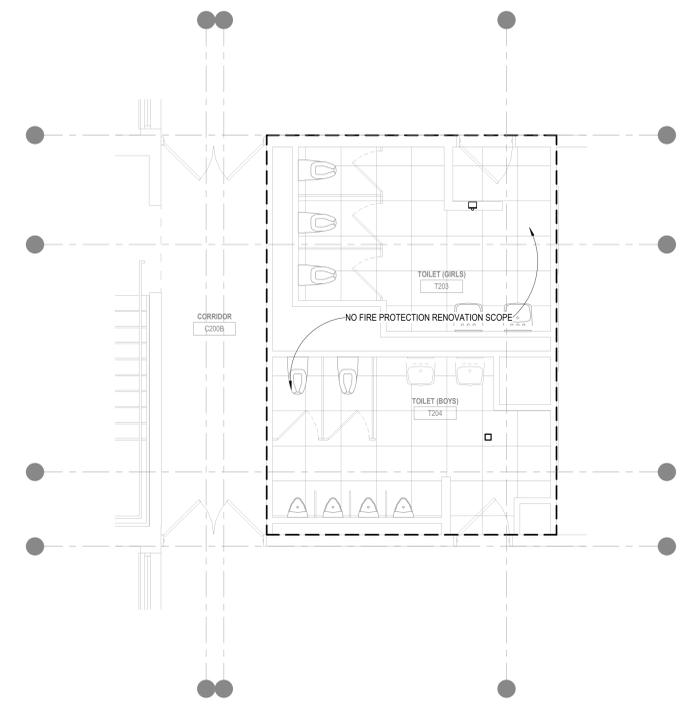4 ENLARGED TOILET FIRE PLAN - T201 & T202
1/4" = 1'-0"






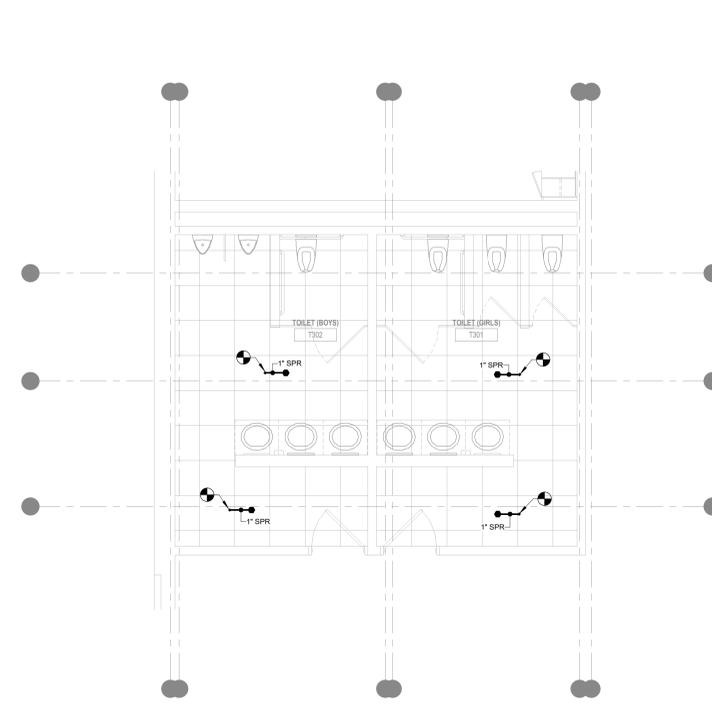
5 ENLARGED TOILET FIRE PLAN - T203 & T204
1/4" = 1'-0"



6 ENLARGED TOILET FIRE PLAN - T301 & T302
1/4" = 1'-0"

KEYED NOTES

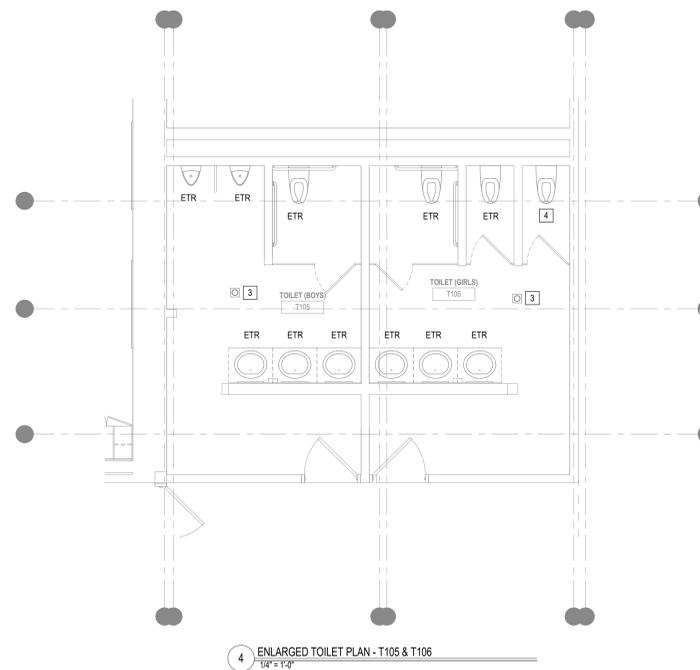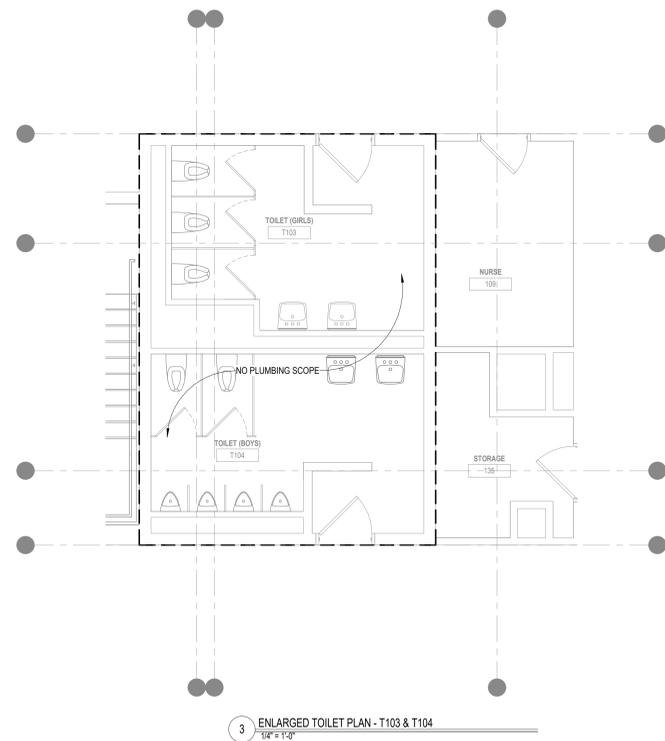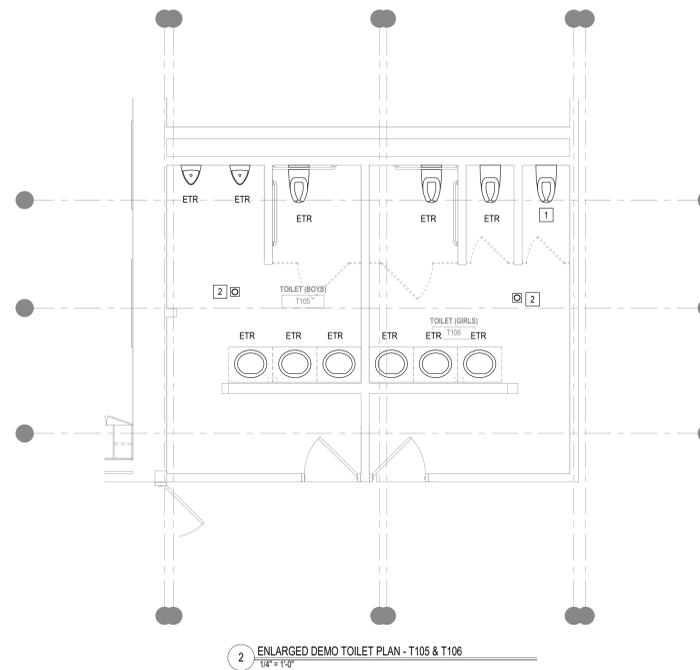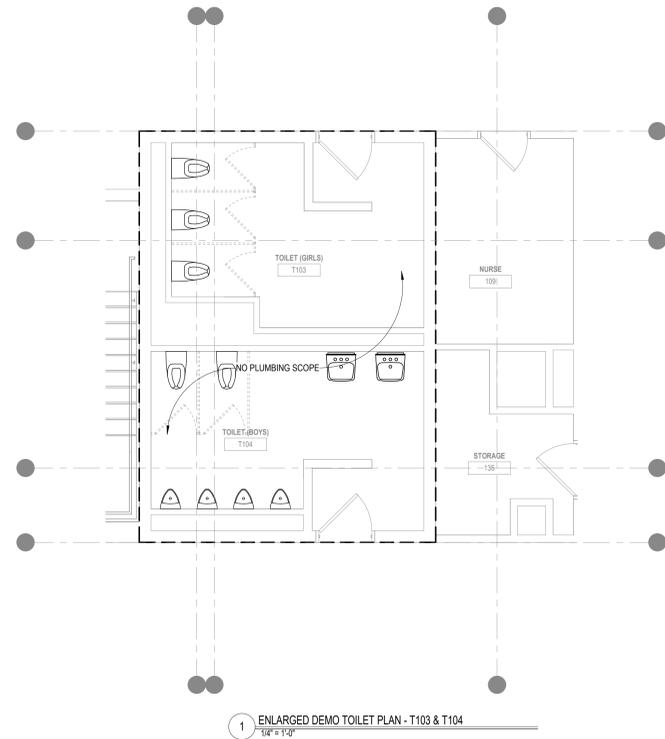- 1 EXISTING WATER CLOSET TO REMAIN. REMOVE EXISTING TOILET SEAT.
- 2 EXISTING FLOOR DRAIN & ALL ASSOCIATED PIPING TO REMAIN. REMOVE EXISTING GRATE & PROVIDE PROPER COVER DURING CONSTRUCTION AS REQUIRED. REFER TO RENOVATION PLANS.
- 3 PROVIDE NEW FLOOR GRATE AT EXISTING FLOOR DRAIN.
- 4 PROVIDE NEW SEAT AT WATER CLOSET EQUAL TO AMERICAN STANDARD ELONGATED SEAT, MODEL #5901.100




KEYNOTE LEGEND:

100% CONSTRUCTION DOCUMENTS
BID PACKAGE #1

KEY PLAN NORTH ARROW



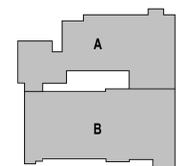KEYPLAN



DRAWING NAME:

**PLUMBING
ENLARGED TOILET PLANS**

DRAWN BY: SPD

REVIEWED BY: AMD

SCALE: AS NOTED | DRAWING NUMBER:

JOB NO.: 2202.04


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P3.01 B1


KEYED NOTES

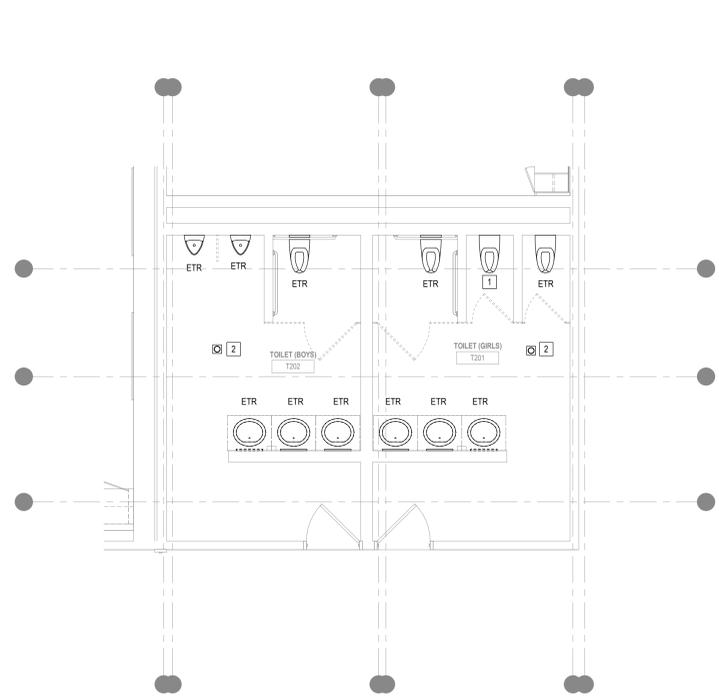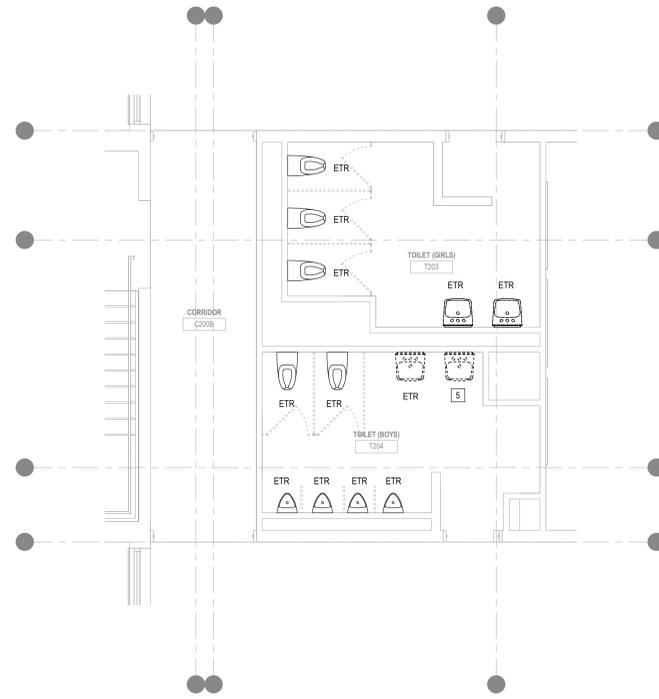- 1 EXISTING WATER CLOSET TO REMAIN. REMOVE EXISTING TOILET SEAT.
- 2 EXISTING FLOOR DRAIN & ALL ASSOCIATED PIPING TO REMAIN. REMOVE EXISTING GRATE & PROVIDE PROPER COVER DURING CONSTRUCTION AS REQUIRED. REFER TO RENOVATION PLANS.
- 3 PROVIDE NEW FLOOR GRATE AT EXISTING FLOOR DRAIN.
- 4 PROVIDE NEW SEAT AT WATER CLOSET, EQUAL TO AMERICAN STANDARD ELONGATED SEAT, MODEL #5901.100
- 5 EXISTING LAVATORY & ALL ASSOCIATED TRIM TO BE REMOVED IN ITS ENTIRETY. MODIFY EXISTING WATER, WASTE & VENT PIPING FOR RECONNECTION AS REQUIRED. REFER TO RENOVATION PLANS.

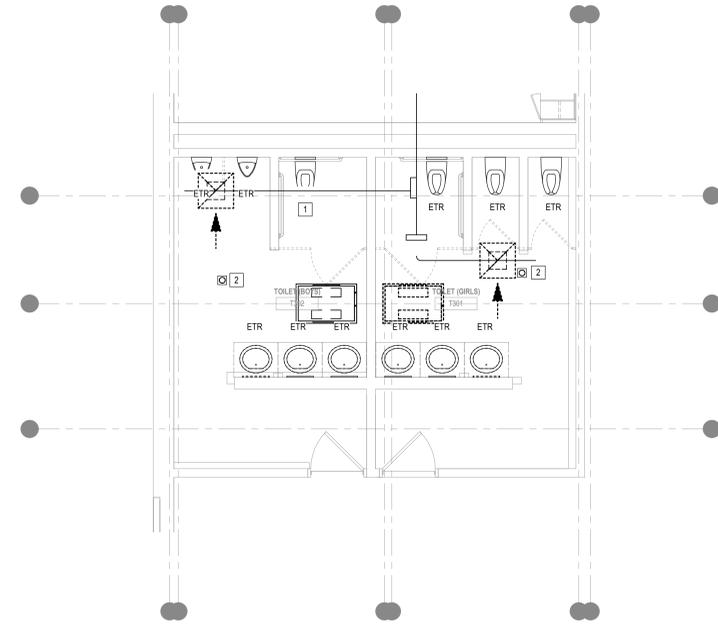
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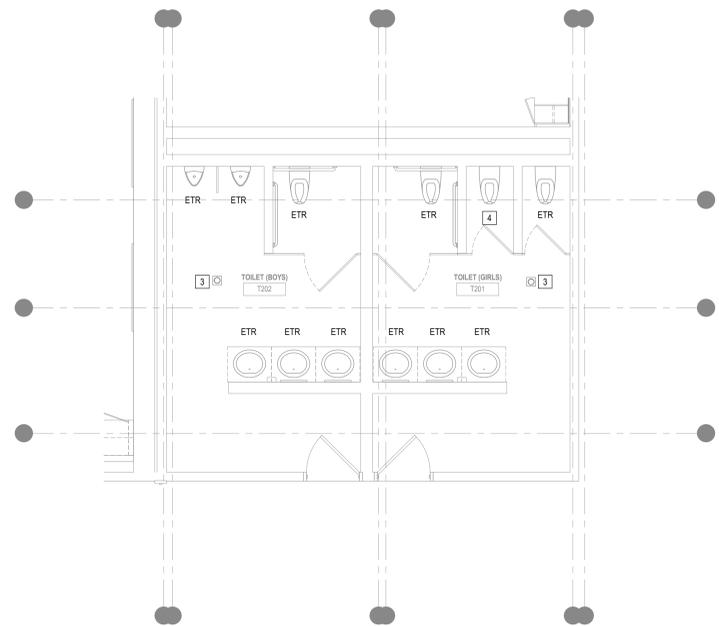
1 ENLARGED DEMO TOILET PLAN - T201 & T202
1/4" = 1'-0"




2 ENLARGED DEMO TOILET PLAN - T203 & T204
1/4" = 1'-0"




3 ENLARGED DEMO TOILET PLAN - T301 & T302
1/4" = 1'-0"



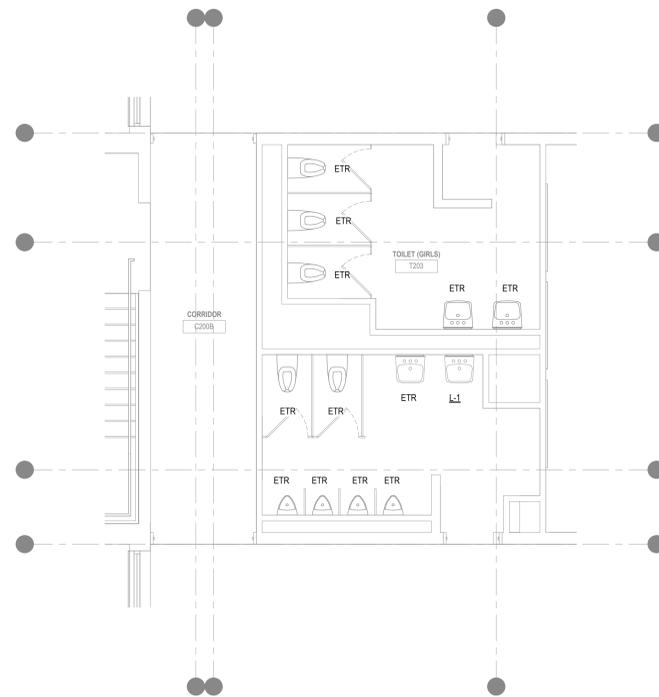4 ENLARGED TOILET PLAN - T201 & T202
1/4" = 1'-0"



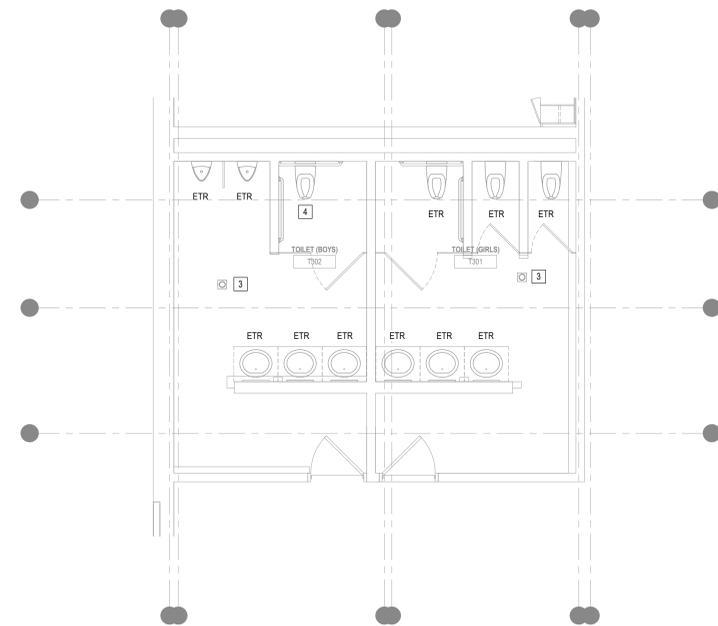5 ENLARGED TOILET PLAN - T203 & T204
1/4" = 1'-0"




6 ENLARGED TOILET PLAN - T301 & T302
1/4" = 1'-0"

100% CONSTRUCTION DOCUMENTS
BID PACKAGE #1

KEY PLAN NORTH ARROW



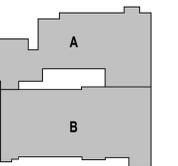KEYPLAN



DRAWING NAME:

**PLUMBING
ENLARGED TOILET PLANS**

DRAWN BY: SPD

REVIEWED BY: AMD

SCALE: AS NOTED | DRAWING NUMBER:

JOB NO.: 2202.04

DATE: June 22, 2023

P3.02 B1

ABBREVIATIONS

CFM	CUBIC FEET PER MINUTE	MAX	MAXIMUM
E	EXHAUST AIR DEVICE	MIN	MINIMUM
EC	ELECTRICAL CONTRACTOR	PC	PLUMBING CONTRACTOR
EF	EXHAUST FAN	R	RETURN AIR DEVICE
GC	GENERAL CONTRACTOR	S	SUPPLY AIR DEVICE
HVAC	HEATING, VENTILATING & AIR CONDITIONING CONTRACTOR		

GENERAL MECHANICAL NOTES

APPLICABLE TO ALL DRAWINGS

- THE HVAC SUBCONTRACTOR SHALL REFER TO THE ARCHITECTURAL DRAWINGS FOR THE CEILING HEIGHTS WHICH SHALL BE MAINTAINED.
- THE HVAC SUBCONTRACTOR SHALL INVESTIGATE AVAILABLE SPACE FOR ALL EQUIPMENT IN CEILINGS BEFORE SUBMISSION OF SHOP DRAWINGS.
- HVAC SUBCONTRACTOR SHALL COORDINATE ALL DIFFUSER, REGISTER AND GRILLE LOCATIONS WITH REFLECTED CEILING PLANS, AND ANY RELOCATIONS DUE TO FIELD CONDITIONS SHALL BE APPROVED BY THE ARCHITECT AND/OR ENGINEER.
- DUCT SIZES INDICATED ON THE DRAWINGS ARE TO BE NET FREE AREA. ALL DUCTWORK SHALL BE CONSTRUCTED, INSTALLED AND SEALED (CLASS A) PER THE LATEST SMACNA REQUIREMENTS.
- ALL SQUARE ELBOWS AND BULLHEAD TEES SHALL HAVE TURNING VANES.
- THE DUCTWORK SYSTEMS SHOWN ON THE DRAWINGS ARE SHOWN DIAGRAMMATICALLY WITHOUT EVERY OFFSET AND TRANSITION REQUIRED TO INSTALL THE WORK. OBVIOUS OFFSETS AND TRANSITIONS, AS RELATED TO HVAC, ARE SHOWN WHERE POSSIBLE WITHOUT AFFECTING THE CLARITY OF THE DRAWINGS.
- ALL DUCTWORK SHALL BE RUN ABOVE THE CEILINGS UNLESS NOTED OTHERWISE.
- ALL MATERIALS INSTALLED IN THIS WORK SHALL BE NEW UNLESS SPECIFICALLY NOTED FOR RE-USE.
- ALL WORK PERFORMED SHALL BE GUARANTEED FREE FROM DEFECTS IN WORKMANSHIP AND MATERIALS FOR A PERIOD OF ONE (1) YEAR FROM DATE OF FINAL ACCEPTANCE BY THE OWNER, UNLESS SUCH DEFECTS ARE CLEARLY THE RESULT OF MISUSE OF EQUIPMENT BY PERSONS NOT UNDER THE CONTROL OF THE SUBCONTRACTOR.
- ALL EQUIPMENT TO BE INSTALLED EXPOSED IN FINISHED AREAS (REGISTERS, GRILLES, DIFFUSERS, ETC.) SHALL BE LOCATED AS INDICATED ON THE ARCHITECTURAL DRAWINGS. FINAL LOCATIONS SHALL BE AS SELECTED BY THE ARCHITECT UNLESS OTHERWISE NOTED.
- ALL EQUIPMENT TO BE INSTALLED EXPOSED IN FINISHED AREAS (REGISTERS, GRILLES, DIFFUSERS, ETC.) SHALL HAVE COLORS SELECTED BY THE ARCHITECT UNLESS OTHERWISE NOTED.
- ALL HVAC EQUIPMENT SHALL BE INSTALLED, COORDINATED WITH ALL TRADES, IN SUCH A WAY SO THAT LIGHTS, CONDUITS, SPRINKLERS, SUPPLY AND/OR DRAIN PIPING DO NOT BLOCK ACCESS TO UNITS AND RELATED ACCESSORIES.
- THE HVAC CONTRACTOR SHALL BE RESPONSIBLE FOR ALL RIGGING AND STAGING REQUIRED FOR THE INSTALLATION OF THE HVAC SYSTEMS.
- UNDERCUT DOORS AND DOOR LOUVERS ARE BY THE GENERAL CONTRACTOR.
- HVAC CONTRACTOR SHALL BE RESPONSIBLE FOR ALL SHEETMETAL TRANSITIONS AT AIR TERMINAL UNITS, FANS, COILS AND OTHER SIMILAR HVAC EQUIPMENT.

SHEETMETAL



SUPPLY DIFFUSER OR GRILLE



RETURN/EXHAUST REGISTER OR GRILLE

GENERAL




EQUIPMENT DESIGNATION

DIFFUSER, REGISTER & GRILLE SCHEDULE

ITEM	MFG'R ①	MODEL	SIZE	NECK	CFM MAX.	THROW	BORDER TYPE	REMARKS
E-1	NAILOR	51EC	-	10x10	400	N/A	S, L	
T-1	NAILOR	51EC	-	10x10	400	N/A	S, L	

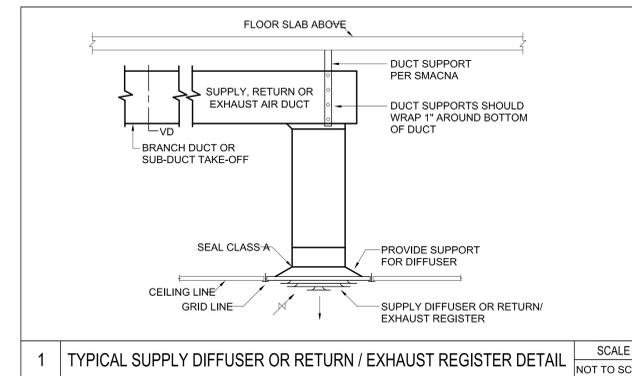① ACCEPTABLE ALT. MANUFACTURERS: METAL-AIRE, PRICE, NAILOR OR APPROVED EQUAL.



1 TYPICAL SUPPLY DIFFUSER OR RETURN / EXHAUST REGISTER DETAIL SCALE NOT TO SCALE



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KEY PLAN NORTH ARROW

KEYPLAN

DRAWING NAME:

**MECHANICAL
LEGEND, SCHEDULES &
DETAILS**

DRAWN BY: SPD

REVIEWED BY: DAH

SCALE: NTS DRAWING NUMBER:

JOB NO.: 2202.04

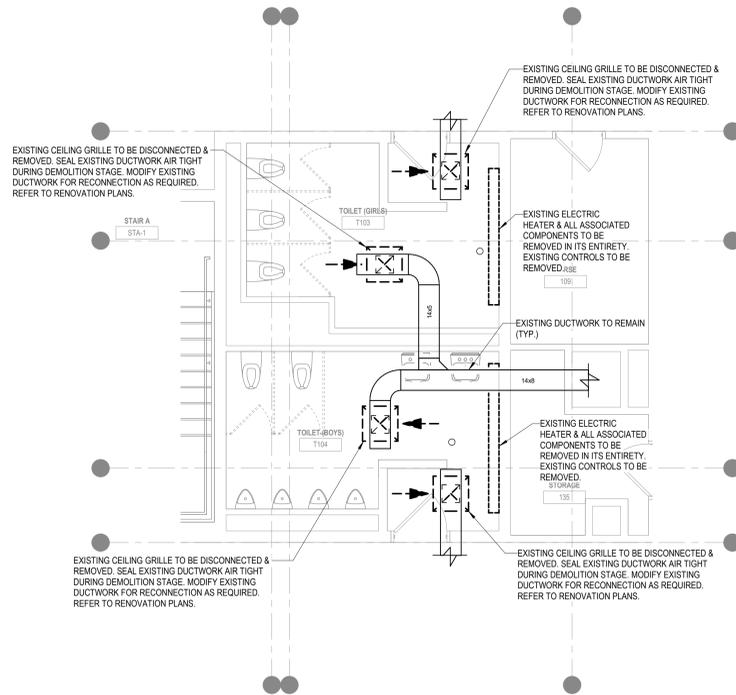
DATE: June 22, 2023

M0.01 B1

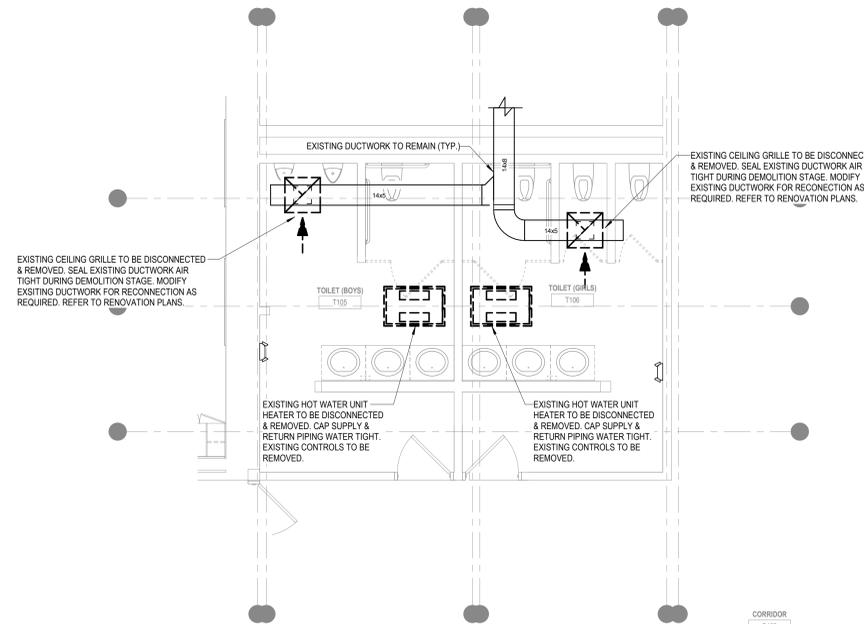
GENERAL NOTES

- PERFORM PRECONSTRUCTION AIR BALANCING REPORT FOR REVIEW.

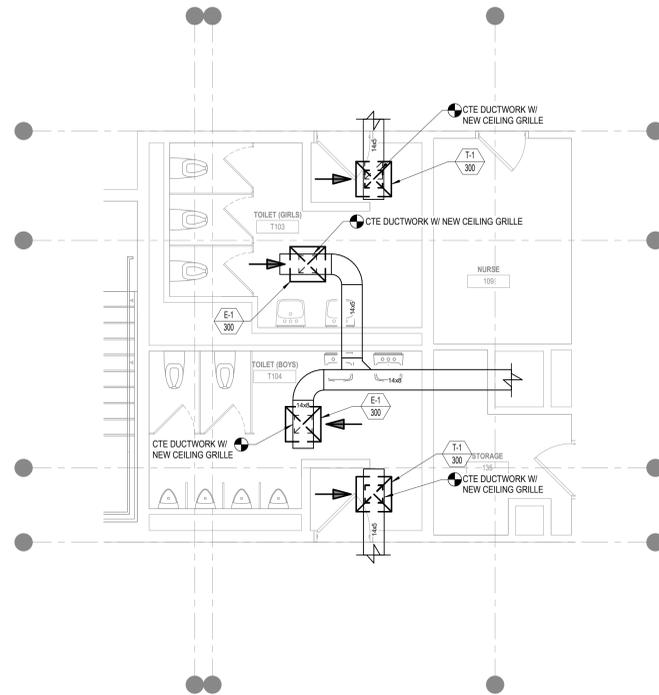
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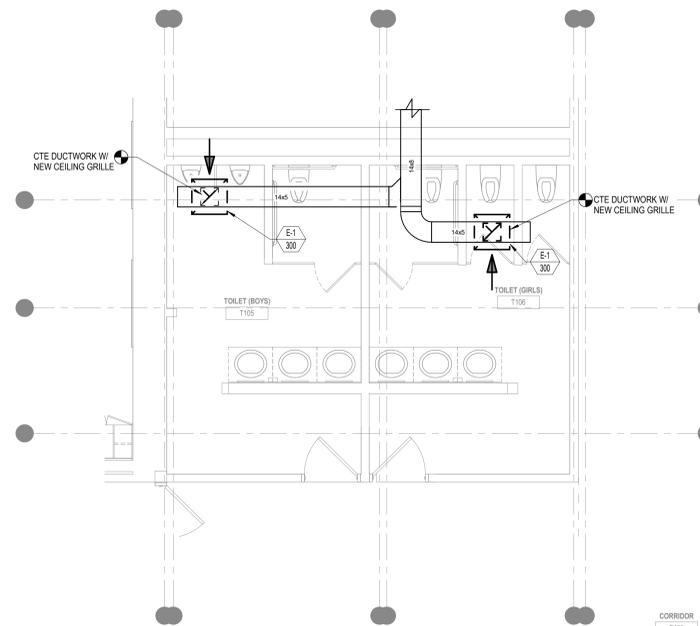
1 ENLARGED TOILET DUCTWORK PLAN - T103 & T104 - DEMOLITION
Scale: 1/4" = 1'-0"



2 ENLARGED TOILET DUCTWORK PLAN - T105 & T106 - DEMOLITION
Scale: 1/4" = 1'-0"



3 ENLARGED TOILET DUCTWORK PLAN - T103 & T104 - RENOVATION
Scale: 1/4" = 1'-0"



4 ENLARGED TOILET DUCTWORK PLAN - T105 & T106 - RENOVATION
Scale: 1/4" = 1'-0"


KEYNOTE LEGEND:

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BID PACKAGE #1**

KEY PLAN NORTH ARROW



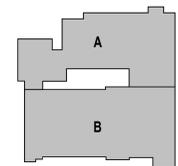KEYPLAN



DRAWING NAME:

**MECHANICAL
ENLARGED TOILET PLANS
DEMOLITION &
RENOVATION**

DRAWN BY: SPD

REVIEWED BY: DAH

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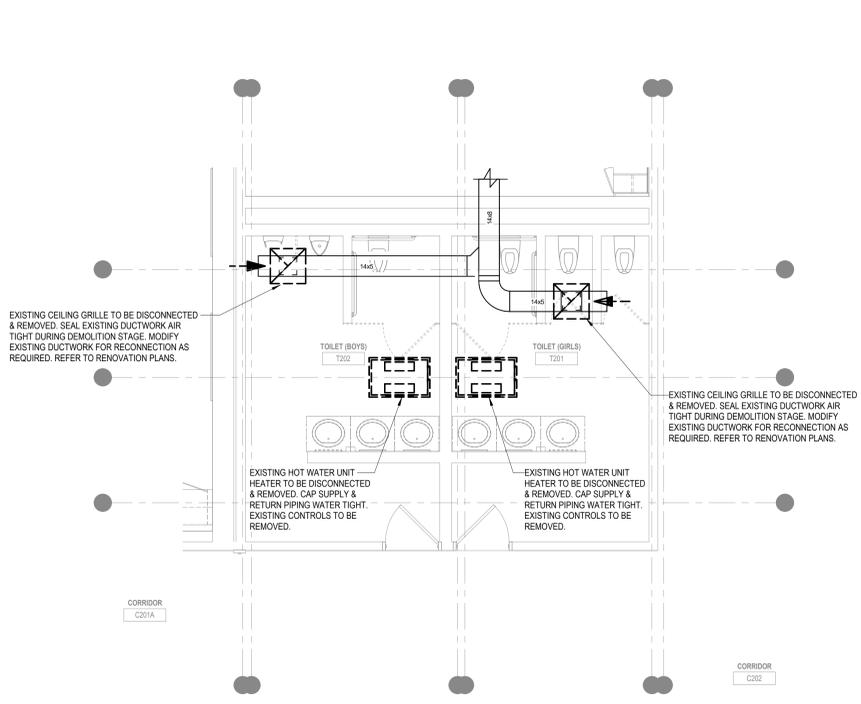
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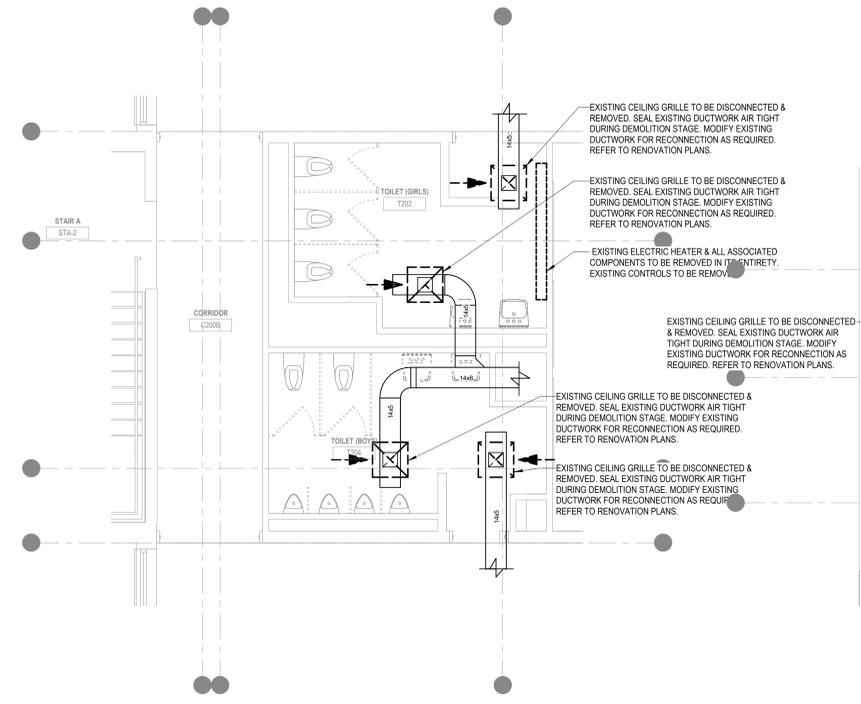
M3.01 B1

GENERAL NOTES
 1. PERFORM PRECONSTRUCTION AIR BALANCING REPORT FOR REVIEW.

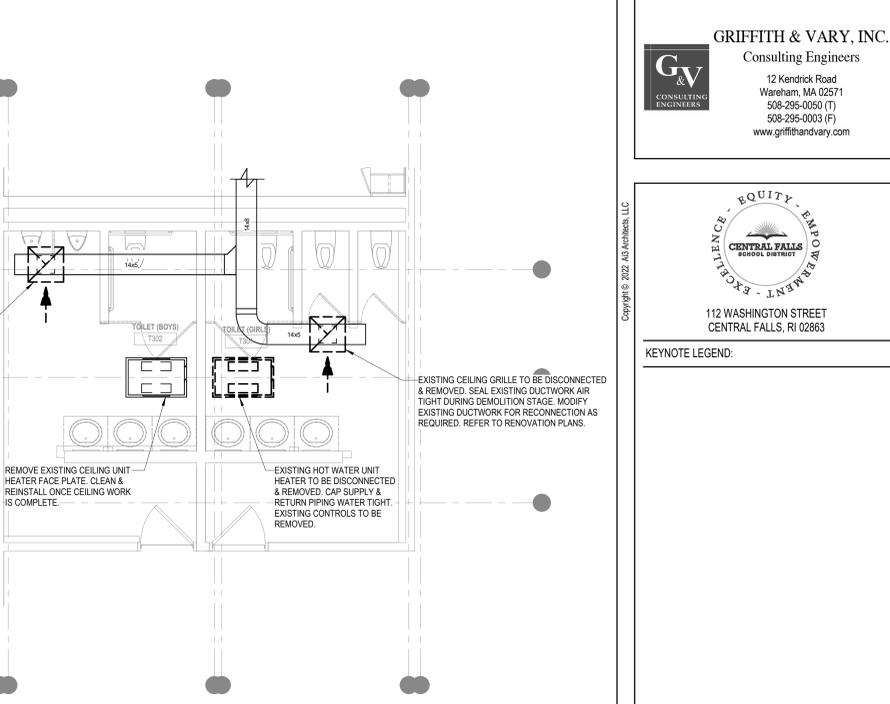
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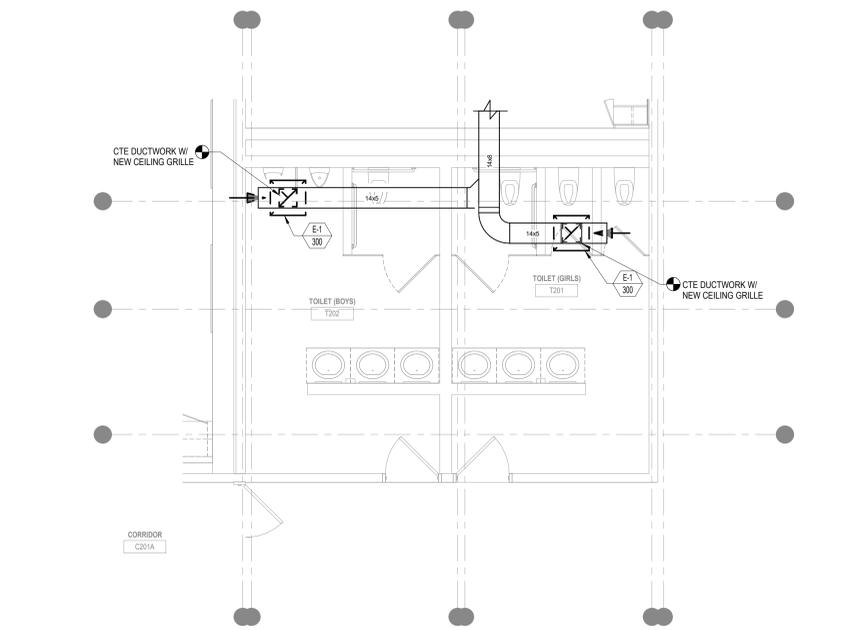
1 ENLARGED TOILET DUCTWORK PLAN - T201 & T202 - DEMOLITION
 Scale: 1/4" = 1'-0"




2 ENLARGED TOILET DUCTWORK PLAN - T203 & T204 - DEMOLITION
 Scale: 1/4" = 1'-0"




3 ENLARGED TOILET DUCTWORK PLAN - T301 & T302 - DEMOLITION
 Scale: 1/4" = 1'-0"



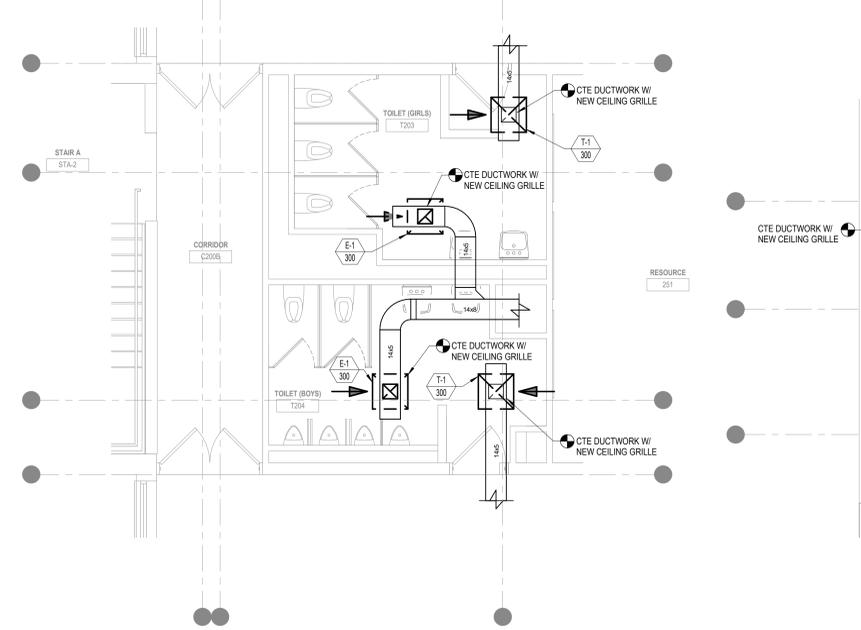4 ENLARGED TOILET DUCTWORK PLAN - T201 & T202 - RENOVATION
 Scale: 1/4" = 1'-0"



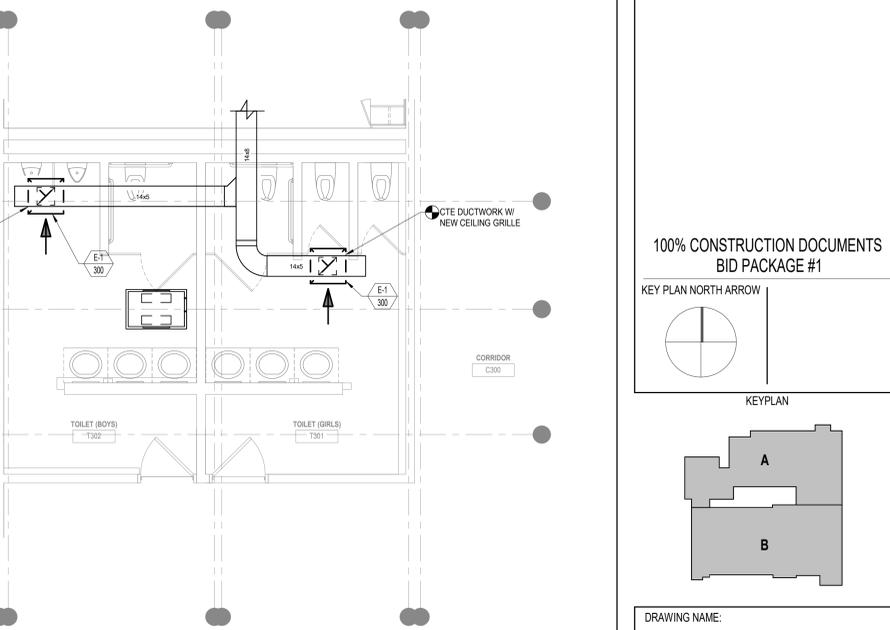5 ENLARGED TOILET DUCTWORK PLAN - T203 & T204 - RENOVATION
 Scale: 1/4" = 1'-0"



6 ENLARGED TOILET DUCTWORK PLAN - T301 & T302 - RENOVATION
 Scale: 1/4" = 1'-0"


KEYNOTE LEGEND:

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 BID PACKAGE #1

KEY PLAN NORTH ARROW



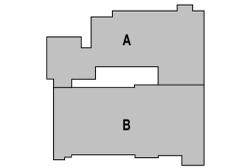KEYPLAN



DRAWING NAME:
MECHANICAL ENLARGED TOILET PLANS DEMOLITION & RENOVATION

DRAWN BY: SPD
 REVIEWED BY: DAH
 SCALE: AS NOTED | DRAWING NUMBER:
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 DATE: June 22, 2023 | **M3.02 B1**

- LIGHTING:**
- A LIGHT FIXTURE (LUMINAIRE) AND OUTLET ON NORMAL CIRCUIT.
 - B
 - C
 - D DOWNLIGHT FIXTURE (LUMINAIRE) AND OUTLET ON NORMAL CIRCUIT.
 - E WALL MOUNTED LIGHT FIXTURE (LUMINAIRE) AND OUTLET ON NORMAL CIRCUIT.
 - F STRIP LIGHT FIXTURE (LUMINAIRE) AND OUTLET ON NORMAL CIRCUIT.
 - G LIGHT FIXTURE SYMBOLS WITH FULL SHADING ARE CONNECTED TO EMERGENCY/LIFE SAFETY CIRCUIT.
 - H LIGHT FIXTURE SYMBOLS WITH HALF SHADING ARE CONNECTED TO CRITICAL CIRCUIT.
 - I TRACK WITH TRACK HEAD LIGHT FIXTURES (LUMINAIRES), REFER TO PLANS FOR LENGTH OF TRACK AND NUMBER OF TRACK HEAD LIGHT FIXTURES ON THE TRACK.
 - J

- K SINGLE FACE EXIT SIGN WITH OUTLET AND ARROWS AS INDICATED ON PLAN. "E" DESIGNATION INDICATES TOP OF EXIT SIGN TO BE AT 18" A.F.F. "H" DESIGNATION INDICATES HANDICAP TYPE EXIT SIGN.
- L DUAL FACE EXIT SIGN WITH OUTLET AND ARROWS AS INDICATED ON PLAN.
- M COMBINATION EMERGENCY BATTERY UNIT/EXIT SIGN WITH INTEGRAL EMERGENCY LIGHT HEADS, WITH OUTLET.
- N SINGLE FACE "NOT AN EXIT" SIGN WITH OUTLET.
- O REMOTE SINGLE EMERGENCY LIGHT HEAD.
- P REMOTE DUAL EMERGENCY LIGHT HEADS.
- Q EMERGENCY BATTERY UNIT WITH INTEGRAL LIGHT HEADS.

LIGHTING CONTROL:

- Sa SINGLE POLE SWITCH MOUNTED AT 48" A.F.F TO CENTER. SUBSCRIPT INDICATES LIGHT FIXTURE CONTROL.
- S3a THREE WAY SWITCH MOUNTED AT 48" A.F.F TO CENTER. SUBSCRIPT INDICATES LIGHT FIXTURE CONTROL.
- S4a FOUR WAY SWITCH MOUNTED AT 48" A.F.F TO CENTER. SUBSCRIPT INDICATES LIGHT FIXTURE CONTROL.
- SDa DIMMER SWITCH MOUNTED AT 48" A.F.F TO CENTER. SUBSCRIPT INDICATES LIGHT FIXTURE CONTROL.
- SD3a THREE WAY DIMMER SWITCH MOUNTED AT 48" A.F.F TO CENTER. SUBSCRIPT INDICATES LIGHT FIXTURE CONTROL.
- SLa LED PRESET, SINGLE POLE, AND THREE WAY DIMMER EQUAL TO LEGRAND RH4FBL3PTW MOUNTED AT 48" A.F.F TO CENTER. SUBSCRIPT INDICATES LIGHT FIXTURE CONTROL.
- SX CLASS 1, DIVISION 2, EXPLOSION PROOF LIGHT SWITCH.
- SWP SINGLE POLE SWITCH WITH WEATHERPROOF COVER MOUNTED AT 48" A.F.F. TO CENTER.
- TL TIMELOCK.
- PH PHOTOCELL.
- ES DIMMING SYSTEM ENTRY STATION.

DIGITAL SYSTEM:

- SLa SINGLE BUTTON LOW VOLTAGE DIGITAL SWITCH, EQUAL TO WATT STOPPER #LMSW-101, MOUNTED AT 48" A.F.F TO CENTER. SUBSCRIPT INDICATES LIGHT FIXTURE CONTROL.
- SLab TWO BUTTON LOW VOLTAGE DIGITAL SWITCH, EQUAL TO WATT STOPPER #LMSW-102, MOUNTED AT 48" A.F.F TO CENTER. SUBSCRIPT INDICATES LIGHT FIXTURE CONTROL.
- SLabc THREE BUTTON LOW VOLTAGE DIGITAL SWITCH, EQUAL TO WATT STOPPER #LMSW-103, MOUNTED AT 48" A.F.F TO CENTER. SUBSCRIPT INDICATES LIGHT FIXTURE CONTROL.
- SLabcd FOUR BUTTON LOW VOLTAGE DIGITAL SWITCH, EQUAL TO WATT STOPPER #LMSW-104, MOUNTED AT 48" A.F.F TO CENTER. SUBSCRIPT INDICATES LIGHT FIXTURE CONTROL.
- SLabodegh EIGHT BUTTON LOW VOLTAGE DIGITAL SWITCH, EQUAL TO WATT STOPPER #LMSW-108, MOUNTED AT 48" A.F.F TO CENTER. SUBSCRIPT INDICATES LIGHT FIXTURE CONTROL.
- SLDa LOW VOLTAGE DIGITAL DIMMING SWITCH, EQUAL TO WATT STOPPER #LMDM-101, MOUNTED AT 48" A.F.F TO CENTER. SUBSCRIPT INDICATES LIGHT FIXTURE CONTROL.
- OSa CEILING MOUNTED DIGITAL PASSIVE INFRARED OCCUPANCY SENSOR, EQUAL TO WATT STOPPER #LMPC-100, MOUNT AT LEAST 6'-0" FROM A SUPPLY REGISTER. LOWER CASE LETTER INDICATES SWITCH CONTROL. TIME DELAY SHALL BE 15 MINUTES. PROVIDE CAT 5e CABLE TO ROOM CONTROLLER.
- OSb CEILING MOUNTED DIGITAL DUAL TECHNOLOGY PASSIVE INFRARED AND ULTRASONIC OCCUPANCY SENSOR, EQUAL TO WATT STOPPER #LMDC-100, MOUNT AT LEAST 6'-0" FROM A SUPPLY REGISTER. LOWER CASE LETTER INDICATES SWITCH CONTROL. TIME DELAY SHALL BE 15 MINUTES. PROVIDE CAT 5e CABLE TO ROOM CONTROLLER.
- OSc CEILING MOUNTED DIGITAL ULTRASONIC OCCUPANCY SENSOR, EQUAL TO WATT STOPPER #LMUC-100-2, MOUNT AT LEAST 6'-0" FROM A SUPPLY REGISTER. LOWER CASE LETTER INDICATES SWITCH CONTROL. TIME DELAY SHALL BE 15 MINUTES. PROVIDE CAT 5e CABLE TO ROOM CONTROLLER.
- OSd CEILING MOUNTED DIGITAL PASSIVE INFRARED OCCUPANCY SENSOR WITH EXTENDED HEIGHT LENS (FOR HIGH CEILINGS), EQUAL TO WATT STOPPER #LMPC-100-5, MOUNT AT LEAST 6'-0" FROM A SUPPLY REGISTER. LOWER CASE LETTER INDICATES SWITCH CONTROL. TIME DELAY SHALL BE 15 MINUTES. PROVIDE CAT 5e CABLE TO ROOM CONTROLLER.
- OS1 WALL MOUNTED PASSIVE INFRARED OCCUPANCY SENSOR WITH INTEGRAL SWITCH, MANUAL-ON UNLESS OTHERWISE NOTED. EQUAL TO WATT STOPPER #DW-301, MOUNTED AT 48" A.F.F. TO CENTER. LOWER CASE LETTER INDICATES SWITCH CONTROL. TIME DELAY SHALL BE 15 MINUTES.
- OS2 WALL MOUNTED DUAL TECHNOLOGY OCCUPANCY SENSOR WITH TWO INTEGRAL SWITCHES, MANUAL-ON UNLESS OTHERWISE NOTED. EQUAL TO WATT STOPPER #DSW-302, MOUNTED AT 48" A.F.F. TO CENTER. LOWER CASE LETTER INDICATES SWITCH CONTROL. TIME DELAY SHALL BE 15 MINUTES.
- OS3 WALL MOUNTED DUAL TECHNOLOGY PASSIVE INFRARED AND ULTRASONIC OCCUPANCY SENSOR WITH TWO INTEGRAL SWITCHES, MANUAL-ON UNLESS OTHERWISE NOTED. EQUAL TO WATT STOPPER #DW-311, MOUNTED AT 48" A.F.F. TO CENTER. LOWER CASE LETTER INDICATES SWITCH CONTROL. TIME DELAY SHALL BE 15 MINUTES.
- DT WALL MOUNTED MANUAL-ON DIGITAL TIME SWITCH, EQUAL TO WATT STOPPER #TDS-400, MOUNTED AT 48" A.F.F TO CENTER. TIME DELAY SHALL BE 15 MINUTES.
- D CEILING MOUNTED OPEN LOOP PHOTOSENSOR FOR DAY LIGHT HARVESTING UP TO THREE ZONES OF DIMMING, EQUAL TO WATT STOPPER #MLS-400, PHOTOSENSOR PLACEMENT PER MANUFACTURER'S RECOMMENDED LOCATIONS. PLACEMENT ON FLOOR PLANS IS DIAGRAMMATICAL. REFER TO PHOTOSENSOR PLACEMENT DETAIL. PHOTOSENSOR CONTROLS DAY LIGHT ZONES AS INDICATED ON THE LIGHTING CONTROL DETAILS.

POWER OUTLETS:

- ALL RECEPTACLES SHALL BE MOUNTED AT 18" A.F.F. TO CENTER, UNLESS OTHERWISE NOTED. THE FOLLOWING DESIGNATIONS SHALL APPLY TO ALL RECEPTACLE TYPES.
- C = MOUNTED AT 6" ABOVE BACK SPLASH TO BOTTOM. REFER TO ARCHITECTURAL ELEVATIONS.
 - CP = FOR CONDENSATE PUMP. MOUNT ABOVE ACCESSIBLE CEILING, SURFACE MOUNT TO STRUCTURE.
 - CM = CEILING MOUNTED.
 - IG = ISOLATED GROUND.
 - MF = MOUNTED IN FURNITURE. REFER TO ARCHITECTURAL ELEVATIONS.
 - T = TABLE CHARGING STATION, MOUNTED AT 48" A.F.F. TO CENTER.
 - WP = WEATHERPROOF.
 - Y = MOUNT ADJACENT TO TECHNOLOGY OUTLET.
 - H = PROVIDED WITH HVAC EQUIPMENT. CIRCUIT AS INDICATED.
 - OW = MOUNTED ON FACE OF CASEWORK. REFER TO ARCHITECTURAL ELEVATIONS.
 - XP = CLASS 1, DIVISION 2, EXPLOSION PROOF.
 - G = GOGGLE CABINET.
 - P = MOUNT ADJACENT TO PROJECTOR OUTLET.
 - PC = CONTROLLED BY DIGITAL PLUG LOAD ROOM CONTROLLER.

- DUPLX RECEPTACLE.
- GROUND FAULT CIRCUIT INTERRUPTING DUPLX RECEPTACLE.
- DOUBLE DUPLX RECEPTACLE.
- EMERGENCY DUPLX RECEPTACLE.
- EMERGENCY GROUND FAULT CIRCUIT INTERRUPTING DUPLX.
- EMERGENCY DOUBLE DUPLX RECEPTACLE.
- GROUND FAULT CIRCUIT INTERRUPTING DOUBLE DUPLX RECEPTACLE.
- SPECIAL PURPOSE RECEPTACLE. RECEPTACLE TO MATCH EQUIPMENT REQUIREMENTS. RATING AS INDICATED BY CIRCUIT BREAKER SIZE.

- GROUND FAULT CIRCUIT INTERRUPTING TRIPLEX RECEPTACLE.
- TRIPLEX RECEPTACLE.
- DUPLX RECEPTACLE WITH ONE HALF SWITCHED. SUBSCRIPT INDICATES SWITCH CONTROL.
- 2 USB CHARGERS WITH DUPLX RECEPTACLE.
- 4 USB CHARGER RECEPTACLE.
- 120V, 20A TWIST LOCK RECEPTACLE NEMA L5-20R, MOUNTED TO CABLE TRAY, ABOVE THE REAR OF THE RACK.
- 120V, 20A TWIST LOCK RECEPTACLE NEMA L5-20R, WALL MOUNTED.
- 208V, 10 20A TWIST LOCK RECEPTACLE NEMA L6-20R, MOUNTED TO CABLE TRAY, ABOVE THE REAR OF THE RACK.
- 208V, 10 20A TWIST LOCK RECEPTACLE NEMA L6-20R, WALL MOUNTED.
- 208V, 30 20A TWIST LOCK RECEPTACLE NEMA L21-20R, WALL MOUNTED.
- 208V, 30 20A TWIST LOCK RECEPTACLE NEMA L21-20R, WALL MOUNTED.

- WHITE CORD REEL, WITH 120, 45' S/EO CORD, AND BLACK PORTABLE OUTLET BOX WITH TWO DUPLX RECEPTACLES ON END. PROVIDE SINGLE RECEPTACLE ON CEILING AT CORD REEL LOCATION FOR PLUGGING IN CORD REEL.

- FLUSH MOUNTED FLOOR BOX WITH RECEPTACLES AND TECHNOLOGY OUTLETS AS INDICATED IN FLOOR BOX ON ELECTRICAL AND TECHNOLOGY DRAWINGS. PROVIDE CONDUIT FROM EACH INDIVIDUAL TECHNOLOGY OUTLET AS INDICATED TO ABOVE ACCESSIBLE CEILING OF ROOM WHICH FLOOR BOX IS LOCATED. COORDINATE COVER COLOR WITH ARCHITECT IN FIELD.

- TWO HOUR RATED POKE-THRU WITH RECEPTACLES AND TECHNOLOGY OUTLETS AS INDICATED IN POKE-THRU ON ELECTRICAL AND TECHNOLOGY DRAWINGS. PROVIDE CONDUIT FROM EACH INDIVIDUAL TECHNOLOGY OUTLET AS INDICATED TO ABOVE ACCESSIBLE CEILING OF ROOM WHICH POKE-THRU IS LOCATED. COORDINATE COVER COLOR WITH ARCHITECT IN FIELD.

- FLUSH MOUNTED FLOOR BOX EQUAL TO WIREMOLD FLUSH FURNITURE FEED SERIES. PROVIDE WITH FURNITURE FEED POWER WHIP FOR CONNECTION TO PRE-WIRED FURNITURE.

- FIRE RATED POKE-THRU EQUAL TO WIREMOLD FLUSH FURNITURE FEED SERIES. PROVIDE WITH FURNITURE FEED POWER WHIP FOR CONNECTION TO PRE-WIRED FURNITURE.

- JUNCTION BOX IN WALL WITH COVER AND POWER WHIP FOR CONNECTION TO PRE-WIRED FURNITURE.

- SURFACE METAL RACEWAY, EQUAL TO WIREMOLD SERIES 3000. PROVIDE WITH RECEPTACLES AS INDICATED ON PLANS WITH ACCESSORIES (ELBOWS, COUPLINGS, ETC.) FOR A CONTINUOUS, COMPLETE INSTALLATION. COLOR BY ARCHITECT, IVORY OR GRAY.

- SURFACE METAL RACEWAY, EQUAL TO WIREMOLD SERIES 4000. PROVIDE WITH RECEPTACLES AND TECHNOLOGY OUTLETS AS INDICATED ON PLANS WITH ACCESSORIES (ELBOWS, COUPLINGS, DIVIDERS, ETC.) FOR A CONTINUOUS, COMPLETE INSTALLATION. COLOR BY ARCHITECT, IVORY OR GRAY.

- PLUGMOLD.

- TELEPHONE/POWER/DATE/TELEPHONE/VIDEO POLE WITH OUTLETS AND RECEPTACLES AS SPECIFIED.

- FLUSH VALVE/FAUCET SENSOR POWER CONNECTION TO ALL TRANSFORMERS FOR PLUMBING FIXTURES IN ROOM COORDINATE EXACT REQUIREMENTS AND LOCATIONS WITH PLUMBING SUBCONTRACTOR.

- DROP CORD WITH STRAIN RELIEF AND SINGLE RECEPTACLE ON END, ELECTRICAL SUBCONTRACTOR TO DETERMINE CORD LENGTH IN FIELD.

- PAD MOUNTED ALUMINUM WEATHERPROOF PEDESTAL WITH (2) GFI WEATHERPROOF RECEPTACLES AND LOCKING DOOR AS MANUFACTURED BY LEGRAND MODEL #KCS3P20R2BK1CGLCK-0K-8K OR EQUAL. COLOR SHALL BE BLACK. REFER TO PAD MOUNTED PEDESTAL DETAIL.

- LAB BENCH PEDESTAL, EQUAL TO LEGRAND MODEL #B29, WITH DIVIDER. FOR POWER SIDE. PROVIDE DUPLX GFI RECEPTACLE WITH 3/4" CONDUIT STUB BASEPLATE. FOR LOW VOLTAGE SIDE, REMOVE BLANK PLATE, DO NOT INSTALL 3/4" CONDUIT STUB BASEPLATE, AND PROVIDE BULL NOSE FACEPLATE.

FIRE ALARM/MASS NOTIFICATION:

- FIRE ALARM CONTROL PANEL.
- MASS NOTIFICATION LOCAL OPERATOR CONTROL PANEL.
- FIRE ALARM ANNUNCIATOR PANEL.
- FIRE ALARM COMBINATION HORN OR SPEAKER/STROBE, AS PER SPECIFICATIONS, WALL MOUNTED AT 80" A.F.F. TO BOTTOM OF LENS OR 6" BELOW CEILING WHICHEVER IS LOWER. "WP" INDICATES WEATHERPROOF. "WG" INDICATES WITH WIREGUARD. CANDELA RATING SHALL BE 15, UNLESS OTHERWISE NOTED.
- FIRE ALARM / MASS NOTIFICATION ADDRESSABLE VISIBLE ONLY STROBE UNIT, WITH TWO LENSES, (CLEAR AND AMBER) AS PER SPECIFICATIONS, WALL MOUNTED AT 80" A.F.F. TO BOTTOM OF CLEAR LENS OR BELOW CEILING WHICHEVER IS LOWER. "WP" INDICATES WEATHERPROOF. "WG" INDICATES WITH WIREGUARD. CANDELA RATING SHALL BE 15, UNLESS OTHERWISE NOTED.
- MASS NOTIFICATION ADDRESSABLE VISIBLE ONLY STROBE UNIT/SPEAKER, WITH LENS (AMBER) AS PER SPECIFICATIONS, WALL MOUNTED AT 80" A.F.F. TO BOTTOM OF LENS OR 6" BELOW CEILING WHICHEVER IS LOWER. "WP" INDICATES WEATHERPROOF. "WG" INDICATES WITH WIREGUARD. CANDELA RATING SHALL BE 15, UNLESS OTHERWISE NOTED.
- FIRE ALARM / MASS NOTIFICATION ADDRESSABLE SPEAKER, WALL MOUNTED AT 80" A.F.F. TO TOP OR 6" BELOW CEILING WHICHEVER IS LOWER. "CLG" INDICATES MOUNTED ON CEILING.
- MASS NOTIFICATION PANIC ALARM, PROVIDE STAINLESS STEEL MUSHROOM BUTTON LABELED "EMERGENCY", WITH A CLEAR LEXAN PLASTIC COVER TO PROTECT THE DEVICE.
- FIRE ALARM LOW FREQUENCY AUDIO OUTPUT/VISUAL ALARM, WALL MOUNTED AT 80" A.F.F. TO BOTTOM OF LENS OR 6" BELOW CEILING WHICHEVER IS LOWER. CANDELA RATING SHALL BE 15, UNLESS OTHERWISE NOTED.
- FIRE ALARM LOW FREQUENCY AUDIO OUTPUT ALARM, WALL MOUNTED AT 90" A.F.F. TO TOP OR 6" BELOW CEILING WHICHEVER IS LOWER.
- FIRE ALARM STROBE WALL MOUNTED AT 80" A.F.F. TO BOTTOM OF LENS OR 6" BELOW CEILING WHICHEVER IS LOWER. "WP" INDICATES WEATHERPROOF. "WG" INDICATES WITH WIREGUARD. CANDELA RATING SHALL BE 15, UNLESS OTHERWISE NOTED.
- FIRE ALARM COMBINATION HORN OR SPEAKER/STROBE, AS PER SPECIFICATIONS, MOUNTED ON CEILING. "WP" INDICATES WEATHERPROOF. "WG" INDICATES WITH WIREGUARD. CANDELA RATING SHALL BE 15, UNLESS OTHERWISE NOTED.
- FIRE ALARM STROBE MOUNTED ON CEILING. "WP" INDICATES WEATHERPROOF. "WG" INDICATES WITH WIREGUARD. CANDELA RATING SHALL BE 15, UNLESS OTHERWISE NOTED.
- MASS NOTIFICATION ADDRESSABLE VISIBLE ONLY STROBE UNIT, WITH LENS (AMBER) AS PER SPECIFICATIONS, CEILING MOUNTED. "WP" INDICATES WEATHERPROOF. "WG" INDICATES WITH WIREGUARD. CANDELA RATING SHALL BE 15, UNLESS OTHERWISE NOTED.
- FIRE ALARM BEACON, WALL MOUNTED AT 80" A.F.F. OR FINISHED GRADE TO CENTER.
- FIRE ALARM HORN, WALL MOUNTED AT 80" A.F.F. TO TOP OR 6" BELOW CEILING WHICHEVER IS LOWER. "CLG" INDICATES MOUNTED ON CEILING.
- FIRE ALARM PULL STATION WALL MOUNTED AT 48" A.F.F. TO CENTER. "WG" INDICATES WITH WIREGUARD.
- FIRE ALARM SMOKE DETECTOR.
- FIRE ALARM TRANSMITTER/RECEIVER BEAM SMOKE DETECTOR.
- FIRE ALARM REFLECTOR FOR BEAM SMOKE DETECTOR.

FIRE ALARM TERMINAL CABINET:

- SMOKE CONTROL PANEL.
- MASS NOTIFICATION CONTROL PANEL.
- MASS NOTIFICATION/FIRE ALARM TRANSPONDER PANEL.
- MASS NOTIFICATION HIGH POWER EXTERIOR SPEAKER ARRAY.
- MASS NOTIFICATION HIGH POWER EXTERIOR SPEAKER ARRAY AMPLIFIER.
- NOTIFICATION COMMANDER (SEE SPECIFICATIONS), GRAPHIC CONTROLLER.

- FIRE ALARM KEYED REMOTE TEST STATION FOR BEAM SMOKE DETECTOR, WALL MOUNTED AT 48" A.F.F. IN CORRIDOR BELOW BEAM SMOKE DETECTOR.
- FIRE ALARM COMBINATION RATE OF RISE AND ONE HUNDRED THIRTY FIVE DEGREE TO ONE HUNDRED FORTY DEGREE FIXED TEMPERATURE HEAT DETECTOR. "FT" INDICATES FIXED ONE HUNDRED NINETY DEGREE TO TWO HUNDRED DEGREE TEMPERATURE. "AC" INDICATES ABOVE CEILING.
- WEATHERPROOF AND EXPLOSION PROOF HEAT DETECTOR.
- WALL MOUNTED FIRE ALARM CARBON MONOXIDE DETECTOR. REFER TO MANUFACTURER'S RECOMMENDATIONS FOR MOUNTING HEIGHT. PROVIDE WIRE GUARD OVER DETECTOR.
- FIRE ALARM DUCT SMOKE DETECTOR, FURNISHED AND WIRED BY ELECTRICAL SUBCONTRACTOR. INSTALLED BY HVAC SUBCONTRACTOR.
- FIRE ALARM KEYED REMOTE TEST STATION FOR DUCT SMOKE DETECTOR, WALL MOUNTED AT 48" A.F.F. IN CORRIDOR BELOW DUCT SMOKE DETECTOR.
- FIRE ALARM DOOR HOLDER (WALL MOUNTED).
- FIRE ALARM DOOR HOLDER (FLOOR MOUNTED).
- WALL MOUNTED FIRE ALARM MASTER BOX.
- WALL MOUNTED FIRE ALARM RADIO MASTER BOX.
- FIRE ALARM RADIO MASTER BOX ANTENNA. MOUNT AT HIGHEST POINT ON BUILDING EXTERIOR.
- FIRE ALARM CELLULAR COMMUNICATOR.
- WALL MOUNTED FIRE ALARM KEY BOX, KNOX 3200 SERIES, TO BE INSTALLED AS PER FIRE DEPARTMENT REQUIREMENTS.
- FIRE ALARM REMOTE INDICATOR LED, MOUNTED 6" ABOVE DOOR TO BOTTOM.
- FIRE ALARM TAMPER SWITCH, PROVIDED BY FIRE PROTECTION SUBCONTRACTOR, WIRED BY ELECTRICAL SUBCONTRACTOR.
- FIRE ALARM FLOW SWITCH, PROVIDED BY FIRE PROTECTION SUBCONTRACTOR, WIRED BY ELECTRICAL SUBCONTRACTOR.
- FIRE ALARM PRESSURE SWITCH, PROVIDED BY FIRE PROTECTION SUBCONTRACTOR, WIRED BY ELECTRICAL SUBCONTRACTOR.
- FIRE ALARM POST INDICATING VALVE, PROVIDED BY FIRE PROTECTION SUBCONTRACTOR, WIRED BY ELECTRICAL SUBCONTRACTOR.
- FIRE ALARM ADDRESSABLE CONTROL RELAY MODULE.
- RELAY, SPACE AGE #MR201
- FIRE ALARM ADDRESSABLE MONITOR MODULE.
- FIRE ALARM ADDRESSABLE ISOLATION MODULE.
- FIRE ALARM SYNCHRONIZATION MODULE.
- WALL MOUNTED FIRE ALARM POWER EXPANDER UNIT FOR NOTIFICATION APPLIANCES.
- FIRE-O-MATIC.
- FIRE ALARM DRILL SWITCH, WALL MOUNTED AT 48" A.F.F. TO CENTER.
- WALL MOUNTED ADDRESSABLE TEXTUAL NOTIFICATION APPLIANCE (TEXT MESSAGE BOARD), VERIFY EXACT MOUNTING HEIGHT AND LOCATION WITH ARCHITECT OWNERS REPRESENTATIVE PRIOR TO THE START OF ANY WORK.
- FIRE SMOKE DAMPER, PROVIDED BY MECHANICAL SUBCONTRACTOR, WIRED BY ELECTRICAL SUBCONTRACTOR.
- FIRE ALARM BELL, PROVIDED BY FIRE PROTECTION SUBCONTRACTOR, WIRED BY ELECTRICAL SUBCONTRACTOR.
- SMOKE HATCH, PROVIDED BY GENERAL CONTRACTOR, WIRED BY ELECTRICAL SUBCONTRACTOR.
- SMOKE HATCH CONTROLLER, WALL MOUNTED AT 48" A.F.F. TO CENTER, FURNISHED BY GENERAL CONTRACTOR, INSTALLED AND WIRED BY ELECTRICAL SUBCONTRACTOR. ELECTRICAL SUBCONTRACTOR SHALL PROVIDE CONTROL WIRING AS PER MANUFACTURER'S SPECIFICATIONS TO SMOKE HATCH. VIA T/C. SUBSCRIPT INDICATES SMOKE HATCH CONTROL.

NOTE FOR LOCAL FIRE ALARM DEVICES:

INTERCONNECT ALL LOCAL FIRE ALARM DEVICES AS PER MANUFACTURER'S SPECIFICATIONS WITHIN EACH APARTMENT SO THAT IF ANY DEVICE INITIATES AN ALARM, ALL DEVICES IN THAT APARTMENT WILL GO INTO ALARM. WHERE APARTMENTS ARE NOT BEING COMPLETELY RENOVATED, CONNECT NEW FIRE ALARM DEVICES TO EXISTING APARTMENT LOCAL FIRE ALARM DEVICE 120V CIRCUIT OR IF NOT AVAILABLE, EXISTING UNSWITCHED 120V CIRCUIT.

LOCAL ONLY SELF CONTAINED SMOKE ALARM, 120V, PHOTOELECTRIC TYPE, WITH BATTERY BACKUP, INTERCONNECTABLE.

LOCAL ONLY SELF CONTAINED COMBINATION SMOKE/CARBON MONOXIDE ALARM, 120V, WITH BATTERY BACKUP, INTERCONNECTABLE.

LOCAL ONLY SELF CONTAINED CARBON MONOXIDE ALARM, 120V, WITH BATTERY BACKUP, INTERCONNECTABLE.

LOCAL ONLY STROBE, 120V, WALL MOUNTED AT 80" A.F.F. TO CENTER. "C" INDICATES CEILING TYPE, UNLESS OTHERWISE NOTED. CANDELA RATING SHALL BE 177.

POWER:

- SURFACE MOUNTED PANELBOARD.
- FLUSH MOUNTED PANELBOARD.
- TRANSFORMER.

MECHANICAL EQUIPMENT (REQUIRING POWER CONNECTION):

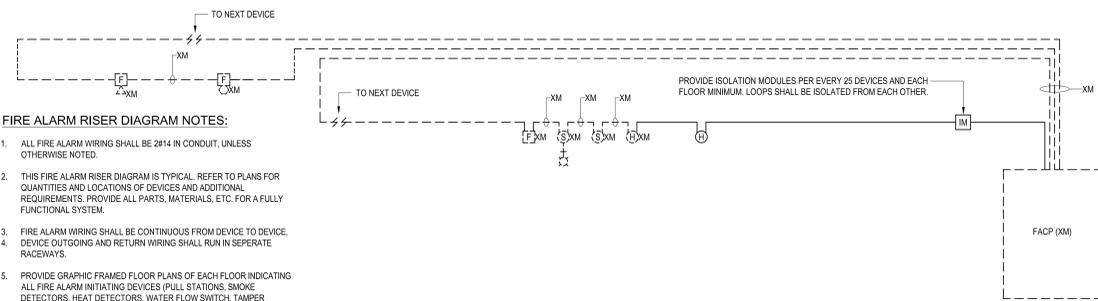
- EXHAUST FAN
- PUMP
- CABINET UNIT HEATER
- HORIZONTAL UNIT HEATER
- ROOF TOP UNIT
- BOILER
- ELECTRIC UNIT HEATER
- ELECTRIC CABINET UNIT HEATER
- CHILLER
- COOLING TOWER
- VARIABLE FREQUENCY DRIVE
- DUCTLESS FAN COIL
- CONDENSING UNIT
- ENERGY RECOVERY UNIT
- MAKE-UP AIR UNIT
- AIR HANDLING UNIT
- UNIT HEATER
- ELECTRIC BASEBOARD
- PUBLIC SAFETY SIGNAL BOOSTER SYSTEM
- WALL MOUNTED BIDIRECTIONAL AMPLIFIER.
- WALL MOUNTED BIDIRECTIONAL AMPLIFIER STATUS MONITORING PANEL.
- DIRECTIONAL YAGI ANTENNA.
- BIDIRECTIONAL AMPLIFIER CABLE AND ANTENNAS.

EXISTING ELECTRICAL LEGEND:

- EXISTING ELECTRICAL EQUIPMENT WITHOUT A DESIGNATION IS TO REMAIN.
- "X" INDICATES EXISTING ELECTRICAL EQUIPMENT WHICH IS TO BE REMOVED. PULL BACK WIRING AND CONDUIT BACK TO NEXT ACTIVE OUTLET OR POWER SOURCE.
- "R" INDICATES EXISTING ELECTRICAL EQUIPMENT TO BE REMOVED AND RELOCATED. EXISTING CIRCUIT SHALL BE EXTENDED TO NEW LOCATION OF RELOCATED EXISTING ELECTRICAL EQUIPMENT.
- "N" INDICATES NEW LOCATION OF RELOCATED EXISTING ELECTRICAL EQUIPMENT.

NOTES:

- 1. DOTTED SYMBOLS INDICATE EXISTING ELECTRICAL EQUIPMENT.
- 2. REFER TO SPECIFICATIONS FOR ADDITIONAL INFORMATION.
- 3. ELECTRICAL SUBCONTRACTOR SHALL BE RESPONSIBLE FOR ENSURING THE CONTINUITY OF ALL EXISTING CIRCUITS WHICH ARE REMAINING.
- 4. ELECTRICAL SUBCONTRACTOR SHALL DISCONNECT AND REMOVE ALL ELECTRICAL EQUIPMENT, WIRING, CONDUIT, ETC. ASSOCIATED WITH EXISTING MECHANICAL PLUMBING, AND FIRE PROTECTION EQUIPMENT SCHEDULED TO BE REMOVED. REFER TO DRAWINGS FOR LOCATIONS OF EQUIPMENT.



FIRE ALARM RISER DIAGRAM NOTES:

1. ALL FIRE ALARM WIRING SHALL BE 2#14 IN CONDUIT, UNLESS OTHERWISE NOTED.
2. THIS FIRE ALARM RISER DIAGRAM IS TYPICAL. REFER TO PLANS FOR QUANTITIES AND LOCATIONS OF DEVICES AND ADDITIONAL REQUIREMENTS. PROVIDE ALL PARTS, MATERIALS, ETC. FOR A FULLY FUNCTIONAL SYSTEM.
3. FIRE ALARM WIRING SHALL BE CONTINUOUS FROM DEVICE TO DEVICE.
4. DEVICE OUTGOING AND RETURN WIRING SHALL RUN IN SEPERATE RACEWAYS.
5. PROVIDE GRAPHIC FRAMED FLOOR PLANS OF EACH FLOOR INDICATING ALL FIRE ALARM INITIATING DEVICES (PULL STATIONS, SMOKE DETECTORS, HEAT DETECTORS, WATER FLOW SWITCH, TAMPER SWITCH, ETC.), INDICATE YOU ARE HERE ON FIRST FLOOR PLAN. ORIENTATE FLOOR PLANS ACCORDINGLY. HIGHLIGHT LOCATIONS OF ALL STAIRS, ELEVATORS, AND SPRINKLER ROOM. INDICATE LOCATION OF MASTER BOX. INDICATE VIA RED DOT FIRE DEPARTMENT HOSE VALVE CONNECTION. INDICATE FIRE PUMPER CONNECTIONS. GRAPHIC FLOOR PLANS SHALL BE MOUNTED ADJACENT TO FIRE ALARM CONTROL PANEL AND ANNUNCIATORS.
6. WHERE EXISTING FIRE ALARM DEVICES ARE BEING REMOVED AND RELOCATED AS SHOWN ON ELECTRICAL DEMOLITION AND RENOVATION PLANS AND WHERE ADDITIONAL FIRE ALARM DEVICES ARE ADDED TO EXISTING FIRE ALARM INITIATION OR NOTIFICATION CIRCUITS, PROVIDE TERMINAL STRIPS TO EXTEND EXISTING CIRCUIT WIRING TO NEW DEVICE LOCATION FROM EXISTING DEVICE LOCATION. PROVIDE TERMINAL STRIPS INSIDE A TAMPER PROOF LOCKABLE JUNCTION BOX. ALL TERMINAL STRIP AND FIRE ALARM JUNCTION BOXES SHALL BE PAINTED RED.

FIRE ALARM RISER DIAGRAM

NOT TO SCALE



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KEY PLAN NORTH ARROW



KEYPLAN

DRAWING NAME:

ELECTRICAL LEGEND

DRAWN BY: JGM

REVIEWED BY: RCB

SCALE: NOT TO SCALE | DRAWING NUMBER:

JOB NO.: 2202.04

DATE: June 22, 2023

E0.01 B1



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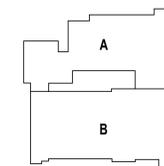
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KEY PLAN NORTH ARROW



KEYPLAN



DRAWING NAME:

ELECTRICAL ENLARGED TOILET LIGHTING PLANS

DRAWN BY: JGM

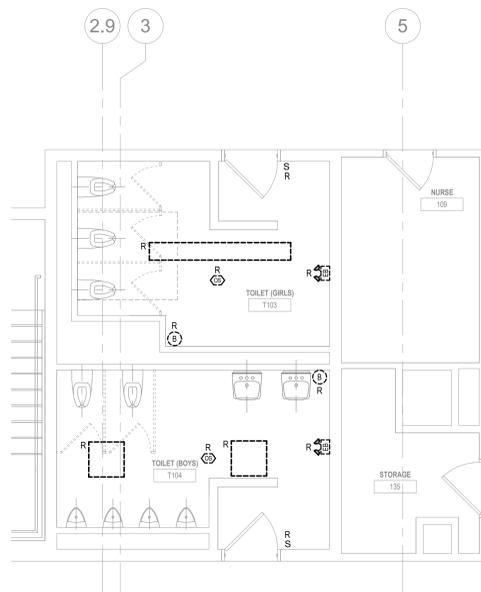
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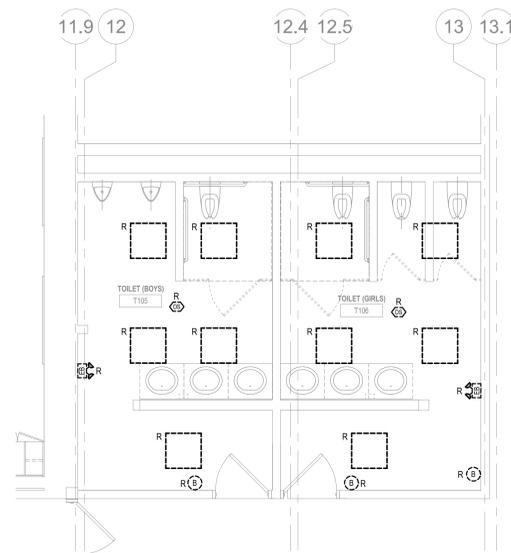
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DATE: June 22, 2023

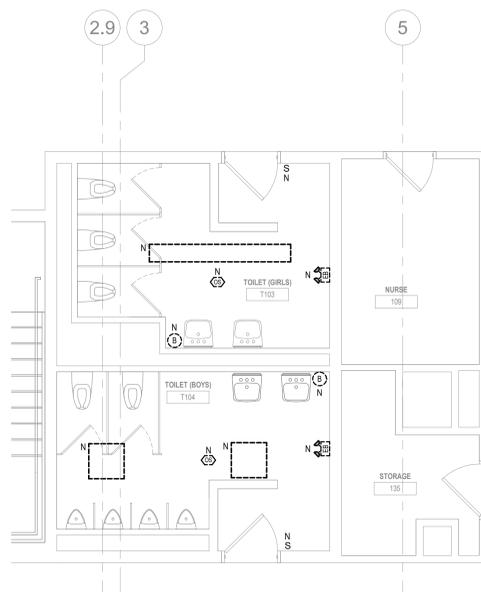
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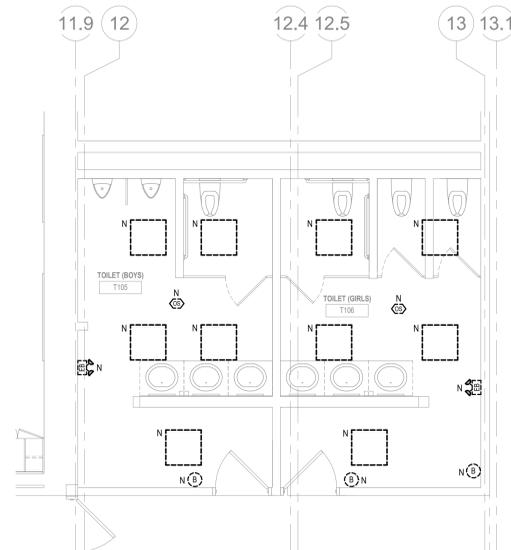
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1/4" = 1'-0"




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1/4" = 1'-0"



3 ENLARGED TOILET PART PLAN - T103 & T104
1/4" = 1'-0"




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1/4" = 1'-0"

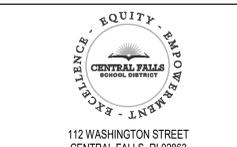

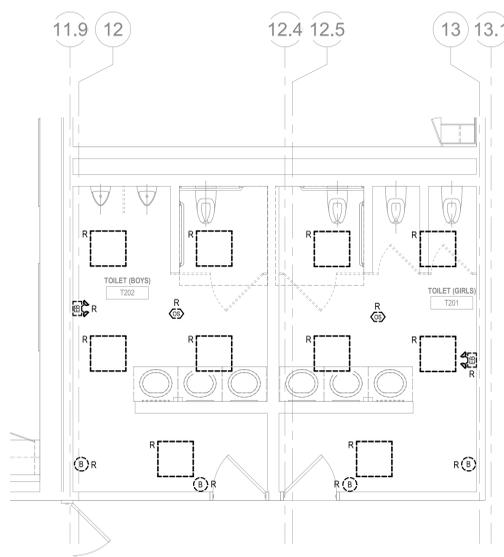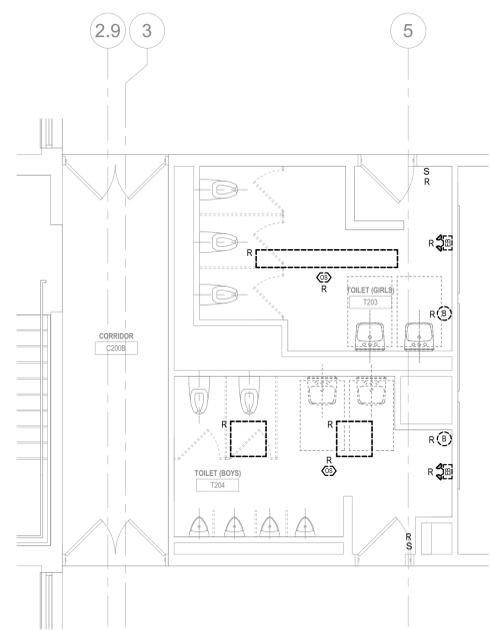
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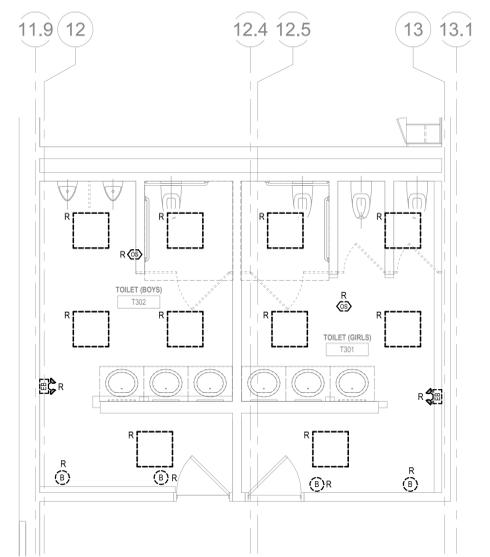
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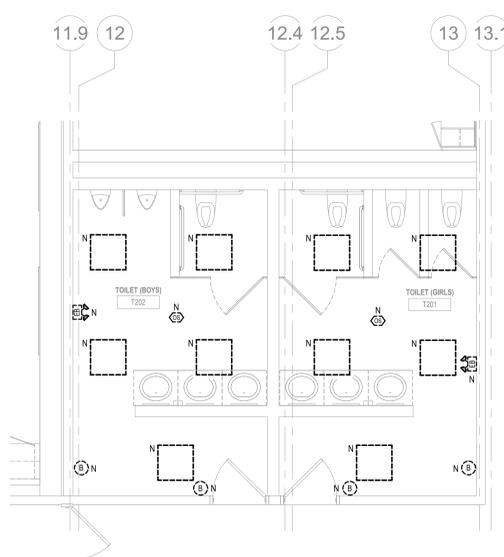
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1/4" = 1'-0"




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1/4" = 1'-0"




3 ENLARGED DEMO TOILET LIGHTING PLAN - T301 & T302
1/4" = 1'-0"



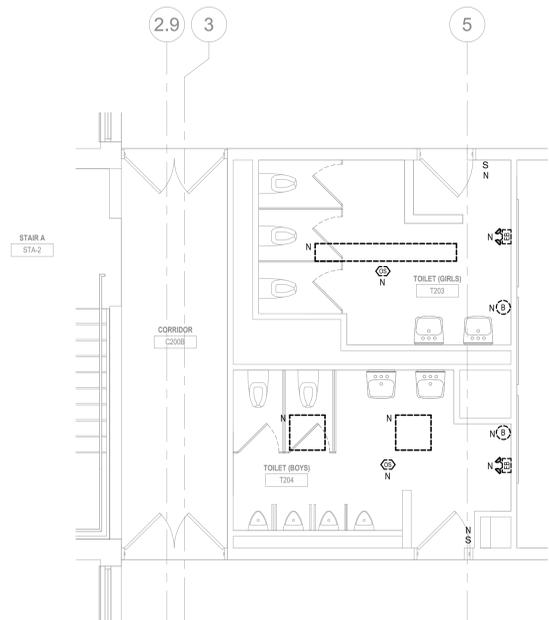4 ENLARGED TOILET PART PLAN - T201 & T202
1/4" = 1'-0"



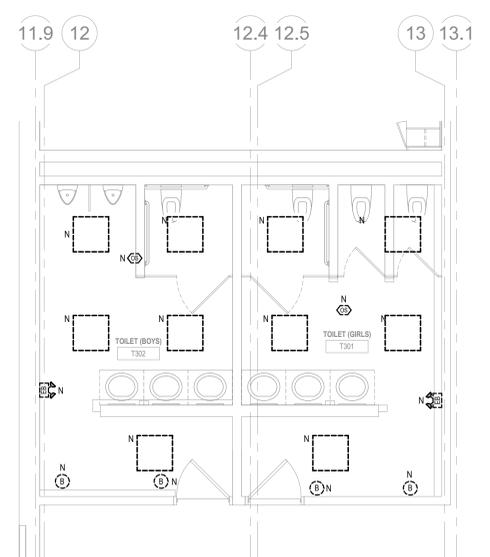5 ENLARGED TOILET PART PLAN - T203 & T204
1/4" = 1'-0"




6 ENLARGED TOILET PART PLAN - T301 & T302
1/4" = 1'-0"

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BID PACKAGE #1

KEY PLAN NORTH ARROW



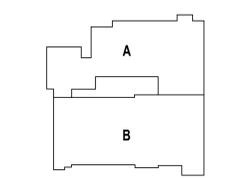KEYPLAN



DRAWING NAME:

**ELECTRICAL
ENLARGED TOILET
LIGHTING PLANS**

DRAWN BY: JGM

REVIEWED BY: RCB

SCALE: AS NOTED | DRAWING NUMBER:

JOB NO.: 2202.04

DATE: June 22, 2023

E3.02 B1



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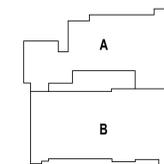
KEYNOTE LEGEND:

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KEY PLAN NORTH ARROW



KEYPLAN



DRAWING NAME:

**ELECTRICAL
ENLARGED TOILET
POWER PLANS**

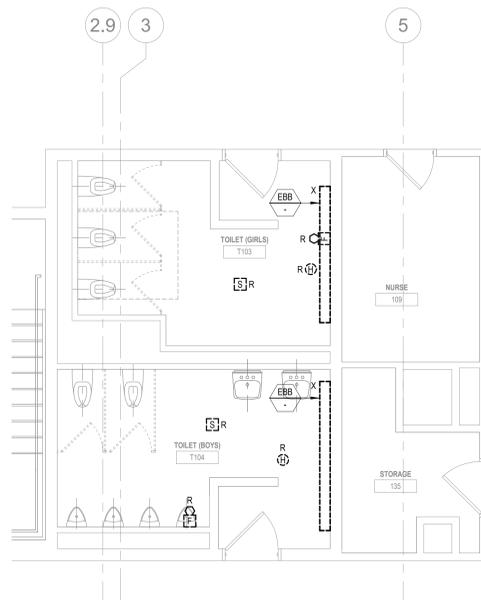
DRAWN BY: JGM

REVIEWED BY: RCB

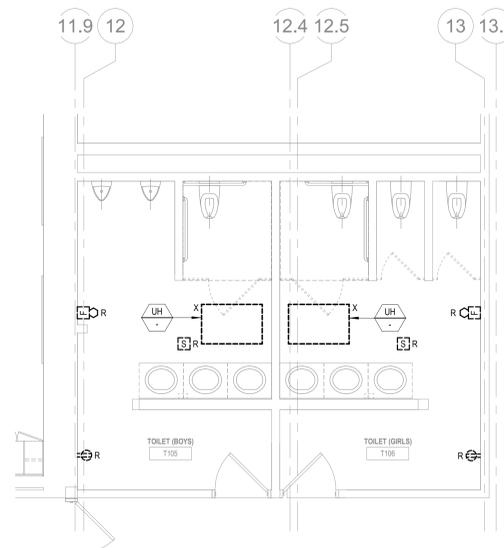
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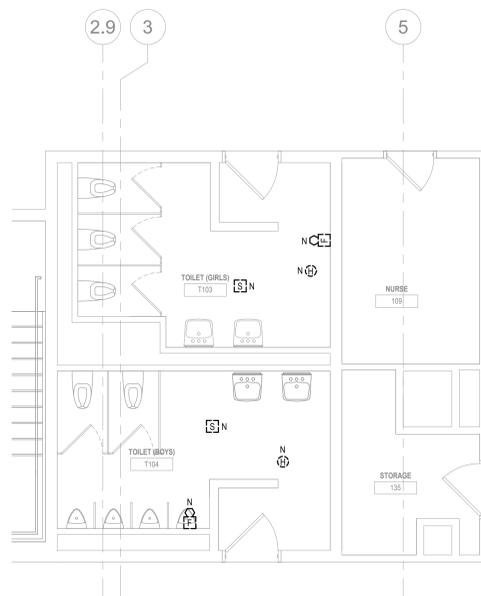
DATE: June 22, 2023 | **E3.03 B1**




1 ENLARGED DEMO TOILET POWER PLAN - T103 & T104
1/4" = 1'-0"



2 ENLARGED DEMO TOILET POWER PLAN - T105 & T106
1/4" = 1'-0"



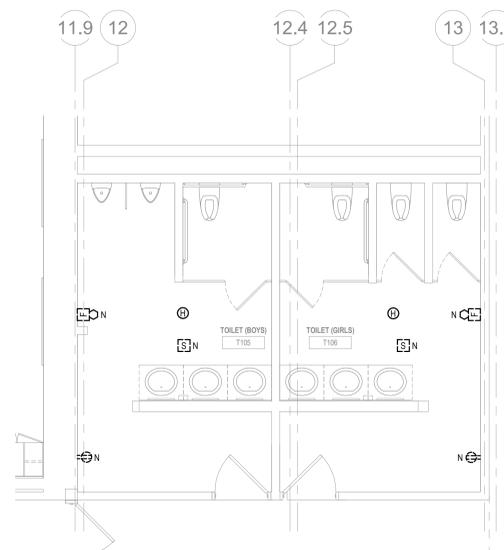3 ENLARGED TOILET POWER PLAN - T103 & T104
1/4" = 1'-0"



4 ENLARGED TOILET POWER PLAN - T105 & T106
1/4" = 1'-0"



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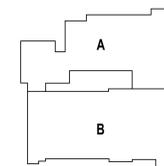
KEYNOTE LEGEND:

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KEY PLAN NORTH ARROW



KEYPLAN



DRAWING NAME:

**ELECTRICAL
ENLARGED TOILET
POWER PLANS**

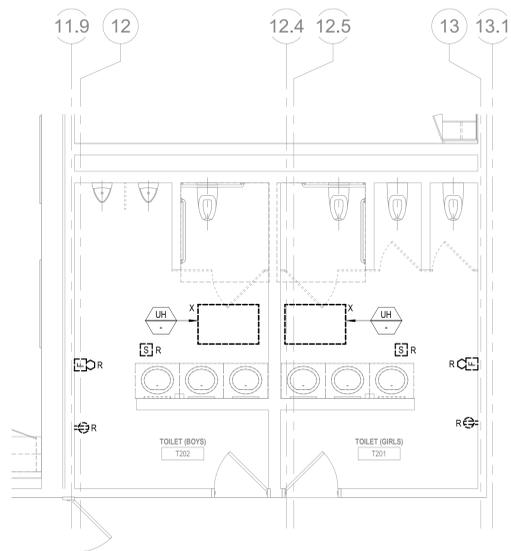
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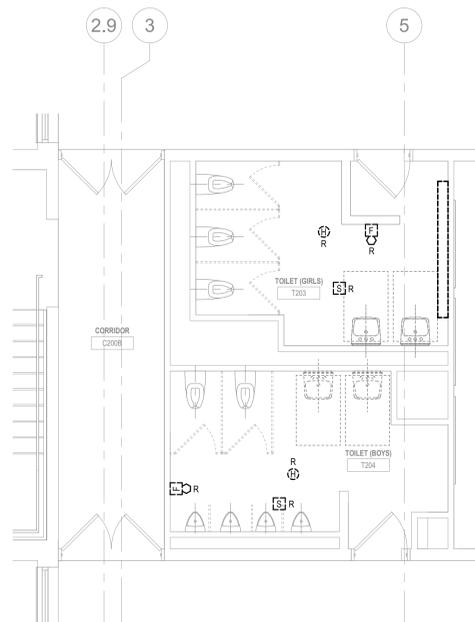
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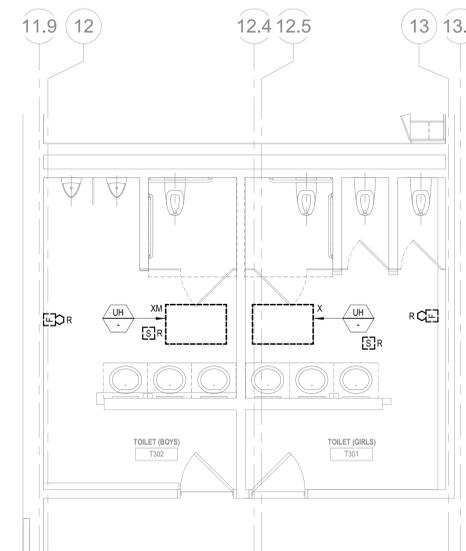
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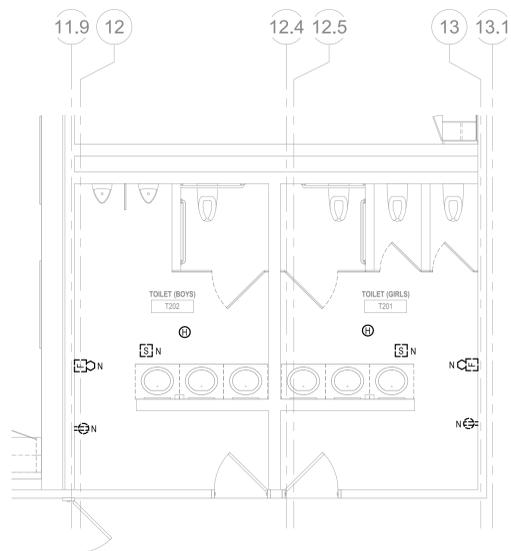
1 ENLARGED DEMO TOILET POWER PLAN - T201 & T202
1/4" = 1'-0"




2 ENLARGED DEMO TOILET POWER PLAN - T203 & T204
1/4" = 1'-0"




3 ENLARGED DEMO TOILET POWER PLAN - T301 & T302
1/4" = 1'-0"



4 ENLARGED TOILET POWER PLAN - T201 & T202
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5 ENLARGED TOILET POWER PLAN - T203 & T204
1/4" = 1'-0"

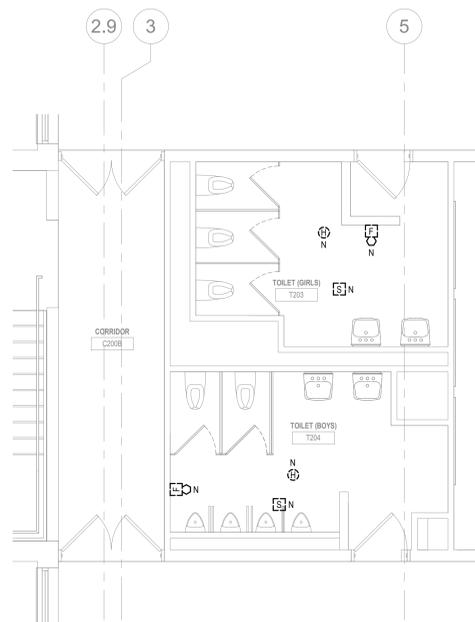

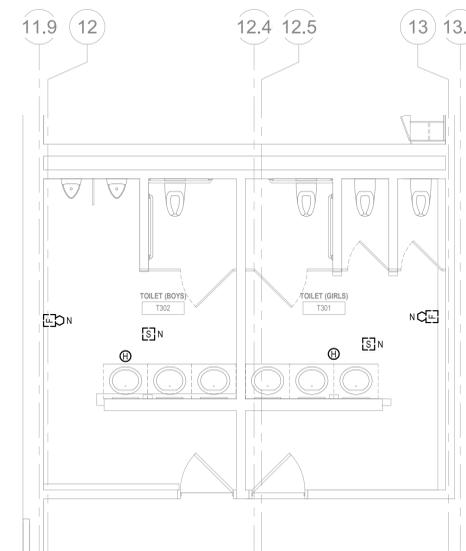6 ENLARGED TOILET POWER PLAN - T301 & T302
1/4" = 1'-0"